MSU - LUTZ FARM WILDLIFE FENCE PROJECT GALLATIN COUNTY, MONTANA

PHASE: 100% CONSTRUCTION DOC'S DATE: AUGUST. 15 2023

PROJECT TEAM

OWNER

MONTANA STATE UNIVERSITY PLANNING, DESIGN & CONSTR. UNIVERISTY FACILITIES MGMT. PHONE: 406.599.0402 CONTACT: DONNY BEEBE donald.beebe@montana.edu

ARCHITECTURAL

HIP AND HUMBLE ARCHITECTURE 418 SOUTH 5th AVENUE BOZEMAN, MT 59715 PHONE: 406.581.3832 CONTACT: BOB MECHELS Bob@hahaarchitect.com

CIVIL/SURVEY

STAHLY ENGINEERING & ASSOC. 851 BRIDGER DRIVE, SUITE 1 BOZEMAN, MT 59715 PHONE: 405.522.8594 CONTACT: NATHAN BOLTON

STRUCTURAL

JOHNSON STRUCTURAL ENG. 152 W. SHORT STREET BOZEMAN, MT 59715 PHONE: 406.585.2939 **CONTACT: LARRY JOHNSON** larry@johnsonengineering.com

LUTZ FARM PROPERTY: S 1/2 NW 1/4 AND SW 1/4 S 24 AND W 1/2 S 25 T1N, R5E, P.M.M 571.98 ACRES

SHEET INDEX ARCHITECTURAL

FENCE DEMO PLANS SITE INFORMATION CORNERS & H-FRAMES

18' & 36' GATES RECESSED GATES DITCH & CREEK FENCES

KIOSK GATES & FENCES DETAILS & SPECIFICATIONS EXISTING CONDITIONS EXISTING CONDITIONS


CIVIL / SURVEY

SETBACKS & BOUNDARY SURVEY

PROJECT INFORMATION

PERIMETER SPOT ELEVATION PLANS ENLARGED TOPO AREAS

VICINITY MAP

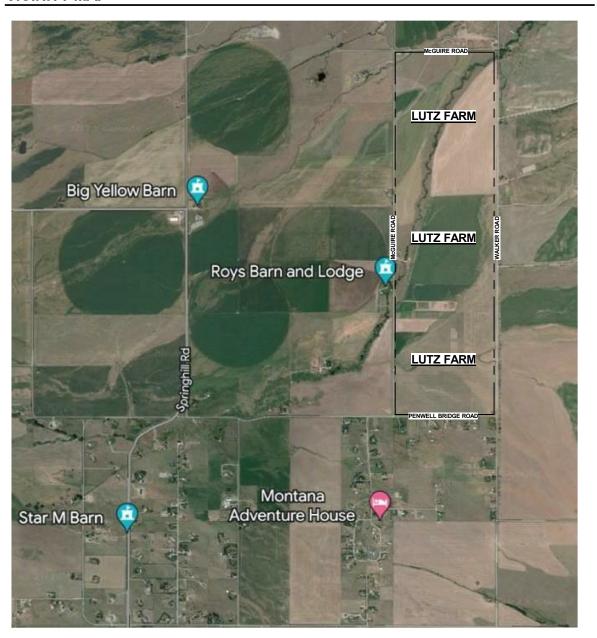


PROJECT SPECIFIC NOTES

- 1. DIMENSIONS ARE SHOWN ON THE DRAWINGS. DO NOT SCALE THE DRAWINGS
- 2. THE CONTRACTOR IS RESPONSIBLE FOR PROVIDING ALL NEW MATERIALS (UNO) & QUALIFIED CRAFTPERSONS TO COMPLETE THE WORK.
- 3. CONSTRUCTION DOCUMENTS SHOW THE DESIGN INTENT OF THE PROJECT & MAY NOT SHOW MINOR DETAILS OF PROPOSED INSTALLATION. THE INCLUSION OF THESE MINOR DETAILS IS IMPLIED TO PROVIDE A COMPLETE PROJECT & ARE TO BE INCLUDED AS A PART OF A BID.
- 5. IT IS THE CONTRACTOR'S RESPONSIBILITY TO INSPECT EXISTING CONDITIONS PRIOR TO PROCEEDING WITH EACH INSTALLATION OR PART OF THE WORK. DISCREPANCIES MUST BE REPORTED TO THE ARCHITECT PRIOR TO PROCEEDING.
- 6. THE CONTRACTOR IS TO COORDINATE THE INSTALLATION OF MATERIALS & WORK OF OTHERS WHO ARE NOT SUB-CONTRACTORS TO THE GC, YET ARE REQUIRED IN PROVIDING A COMPLETED PROJECT. AREAS OF WORK REQUIRING COORDINATION INCLUDE BUT ARE NOT LIMITED TO THOSE
- 7. REFER TO STRUCTURAL & CIVIL/SURVEY DRAWINGS FOR COORDINATION OF
- 9. IN THE CASE OF CONTRADICTIONS BETWEEN DRAWINGS OR BETWEEN DRAWINGS & SPECIFICATIONS. ASSUME THE MORE COSTLY APPROACH FOR BIDDING PURPOSES. BRING ALL CONTRADICTIONS TO THE ATTENTION OF THE
- 10. THE CONSTRUCTION DOCUMENTS CONSIST OF THE CONSTRUCTION DRAWINGS & SPECIFICATIONS INCLUSIVELY. SOME ITEMS MAY BE SHOWN ONLY ON THE DRAWINGS OR INDICATED ONLY IN THE SPECIFICATION. FOR EXAMPLE, THE SPECIFICATIONS MAY SAY TO PAINT ALL EXPOSED STRUCTURAL STEEL, BUT THIS WILL NOT BE CALLED OUT ON ALL OF THE DRAWINGS.
- D VIEWS ARE SHOWN TO CLARIFY CONDITIONS THAT CANNOT BE SHOWN IN OTHER VIEWS. 3-D VIEWS MAY NOT SHOW ALL DETAILS REQUIRED TO COMPLETE THE AREA. REFER TO DETAILS AT ADJACENT AREAS AS NECESSAR OR ASK THE ARCHITECT PRIOR TO BIDDING.


THESE DRAWINGS WERE PREPARED BY HIP AND HUMBLE ARCHITECTURE, LLC. FOR CONSTRUCTION OF THE BUILDING DESCRIBED. AS SUCH, THEY ARE THE PROPERTY OF HIP AND HUMBLE ARCHITECTURE, LLC. AND MAY NOT BE REPRODUCET COPIED OR USED IN ANY WAY WITHOUT PRIOR APPROVAL FROM HIP AND HUMBLE ARCHITECTURE, LLC.

REFERENCE SYMBOLS

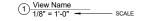





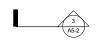

EX: SHEET A5-2 DETAIL 3



SEE DRAWINGS EX: SHEET A7-1, DETAIL 4



SEE DRAWINGS EX: SHEET A6-3, DETAIL 2



EX: SHEET A7-1, DETAIL 4 & 5



DOOR SYMBOL SEE DOOR SCHEDULE



ROOM SYMBOL EX: 202 - SECOND FLOOR

WINDOW SYMBOL SEE WINDOW TYPES



GRID LINES: LETTERS LEFT TO RIGHT NUMBERS BOTTOM TO TOP

WALL/PARTITION TYPE SYMBOL SEE WALL/PARTITION TYPES



BENCHMARK





MSU-CPDC

BOZEMAN, MONTANA PHONE: 406.994.5413 FAX: 406.994.5665

ARM WILDLIFE FENCE 凶

DRAWN BY: RM
REVIEWED BY: DB REV. DESCRIPTION



PPA#21- 0122 A/E#00-00-00 CONSULTANT#:

SHEET TITLE **COVER SHEET**

SHEET

1 SITE DEMO PLAN A1-1 1 : 6000

GATE / FENCING DEMOLITION NOTES:

- 1. SEE SITE DEMOLITION PLANS FOR ANTICIPATED LOCATIONS AND LENGTHS OF EXISTING FENCING AND GATE DEMOLITION AND REMOVAL.
- 2. FENCING DEMOLITION TO INCLUDE ALL EXISTING METAL AND WOOD POSTS, BRACES, FASTENERS, BARBED WIRE AND OTHER TYPSES OF FENCING AND GATES THAT ARE INSTALLED IN THE INDICATED FENCING RUNS. CONTRACTOR TO FIELD VERIFY ALL FENCING TYPES AND LOCATIONS TO BE DEMOLISHED.
- 3. CONTRACTOR TO PROPERLY DISPOSE OF ALL DEMOLISHED FENCING COMPONENTS AND LEAVE EXISTING SITE IN A CLEAN AND ORGANIZED CONDITION READY FOR NEW FENCING AND GATE INSTALLATIONS.



ENLARGED SITE DEMO PLAN @ KIOSK
A1-1 1" = 30'-0"





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LUTZ FARM WILDLIFE FENCE








PPA#21-0122 A/E#00-00-00 CONSULTANT#:

> SHEET TITLE FENCE DEMO

PLANS SHEET

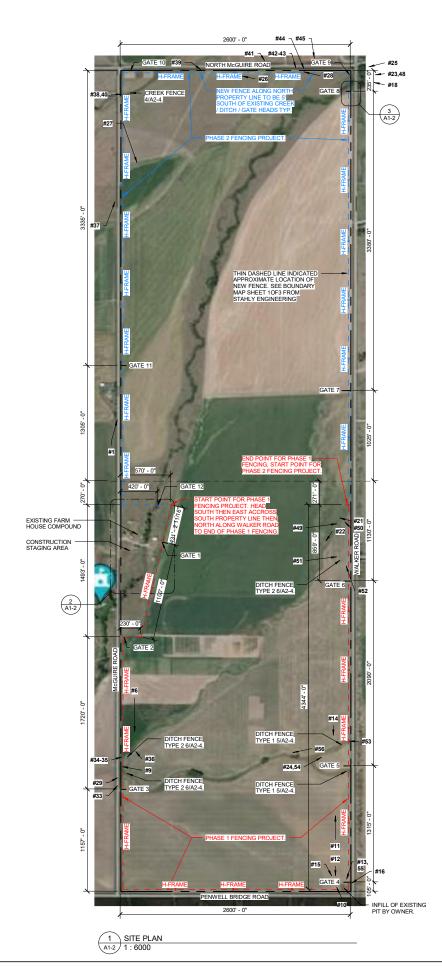



2 ENLARGED SITE PLAN @ FARM 1" = 100'-0"

GATE / FENCING NOTES:

- 1. SEE SITE PLAN FOR GATE NUMBERS AND APPOXIMATE LOCATIONS. OWNER WILL STAKE FINAL GATE LOCATIONS.
- 2. SEE PROJECT SPECIFICATIONS FOR MORE DETAILED INFORMATION REGARDING POSTS, BRACES, FASTENERS, FENCING, GATES, ETC.
- 3. GATES 1, 2, 4, 5, 6, 7, 9, & 11 TO BE 36' WIDE OPENINGS WITH (2) 18' GATES PER DETAILS 4, 5 & 6 / A2-2.
- 4. GATE 3 TO BE 36' WIDE OPENINGS WITH (2) 18' GATES, (1) 4' MAN GATE AND 10' STEP BACK PER DETAILS 1, 2, 3 & 4 / A2-3.
- 5. GATE 8 TO BE 36' WIDE OPENINGS WITH (2) 18' GATES, (1) 4' MAN GATE IN CUSTOM CONFIGURATION AROUND EXISTING INFORMATION KIOSK PER DETAILS 1, 2, 3 & 4 / A2-5.
- 6. GATES 10 & 12 TO BE 18' WIDE OPENINGS WITH A SINGLE 18' GATE PER DETAILS 1, 2 & 3 /
- 7. CORNER FRAME AND "H" FRAME DETAILS ARE ON SHEET A2-1. PROVIDE ONE "H" FRAME (INTERIOR FENCE LINE BRACE) EVERY 1/8 MILE OR 660'.
- 8. DITCH AND CREEK CROSSING FENCE DETAILS ARE ON SHEET A2-4.
- 9. PROVIDE 1 SET OF RACHET WIRE TIGHTENERS EVERY 1/4 MILE OR 1320'. ONE RACHET FOR EACH HORIZONTAL WIRE TYPICAL.
- 10. GAME FENCING TO BE FIXED KNOT HIGH TENSILE WOVEN WIRE THAT IS 96" TALL. HOLD BOTTOM OF FENCING TIGHT TO SURFACE OF EXISTING GRADE. INSTALL FENCING WITH SMALLER OPENINGS AT THE TOP OF THE FENCE. SEE PROJECT SPECIFICATIONS FOR MORE INFORMATION.
- 11. SMALL NUMBERS WITH ARROWS ON THESE AERIAL IMAGES INDICATE APPROXIMATE LOCATIONS WHERE THE EXISTING CONDITIONS PHOTOS ON SHEET A4-1 WERE TAKEN.
- 12. SEE ATTACHED CIVIL DRAWINGS 1 OF 3 THRU 3 OF 3 BY STAHLY ENGINEERING FOR ADDITIONAL SITE, SURVEY AND TOPO INFORMATION REGARDING THIS PROPERTY.
- 13. ON STRIAGHT RUNS OF FENCING, PROVIDE 12' T-POSTS @ 12' O.C. WITH 8' OF T-POST EXPOSED ABOVE GRADE. INSTALL ONE 2-7/8" DRILL STEM POST EVERY 96' IN PLACE OF T-POST ALONG THOSE STRAIGHT RUNS OF FENCING.







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ARM WILDLIFE FENCE 阡

CONSTRUCTION SET (100%)


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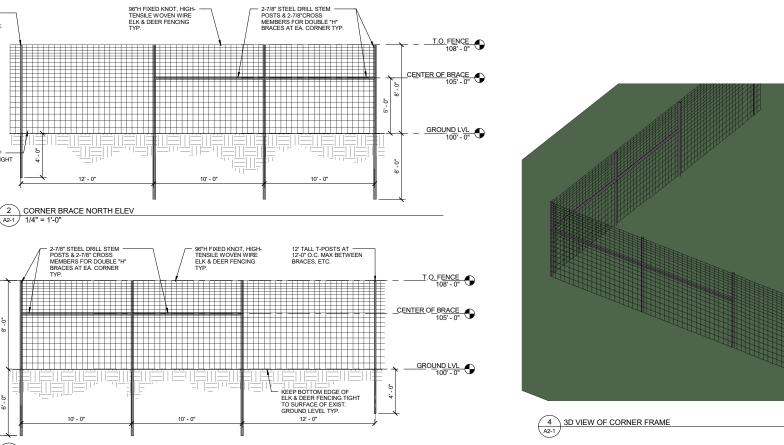


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SHEET TITLE INFORMATION

SHEET



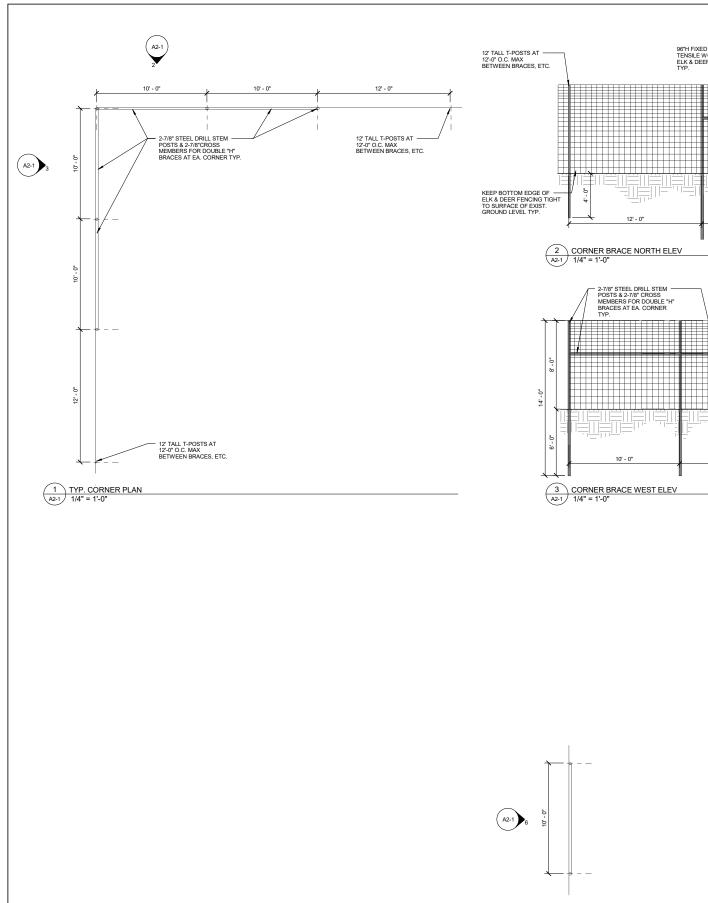

96"H FIXED KNOT, HIGH-TENSILE WOVEN WIRE ELK & DEER FENCING TYP.


- KEEP BOTTOM EDGE OF ELK & DEER FENCING TIGHT TO SURFACE OF EXIST. GROUND LEVEL TYP.

CENTER OF BRACE

2-7/8" STEEL DRILL STEM POSTS & CROSS MEMBERS FOR "H" BRACES

6 TYPICAL H-BRACE ELEV A2-1 1/4" = 1'-0"

5 TYP. H-FRAME PLAN 1/4" = 1'-0"

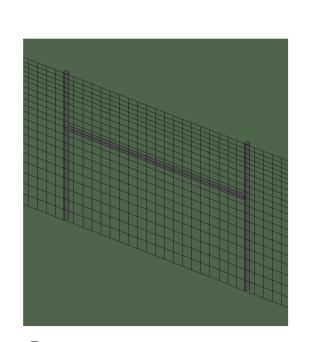

7 3D VIEW OF H FRAME





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LUTZ FARM

WILDLIFE FENCE FINAL CONSTRUCTION SET (100%)

HIP & HUMBLE ARCHITECTURE, LLC 418 S. 5TH AVE. BOZEMAN MT 59715 406.581.3832

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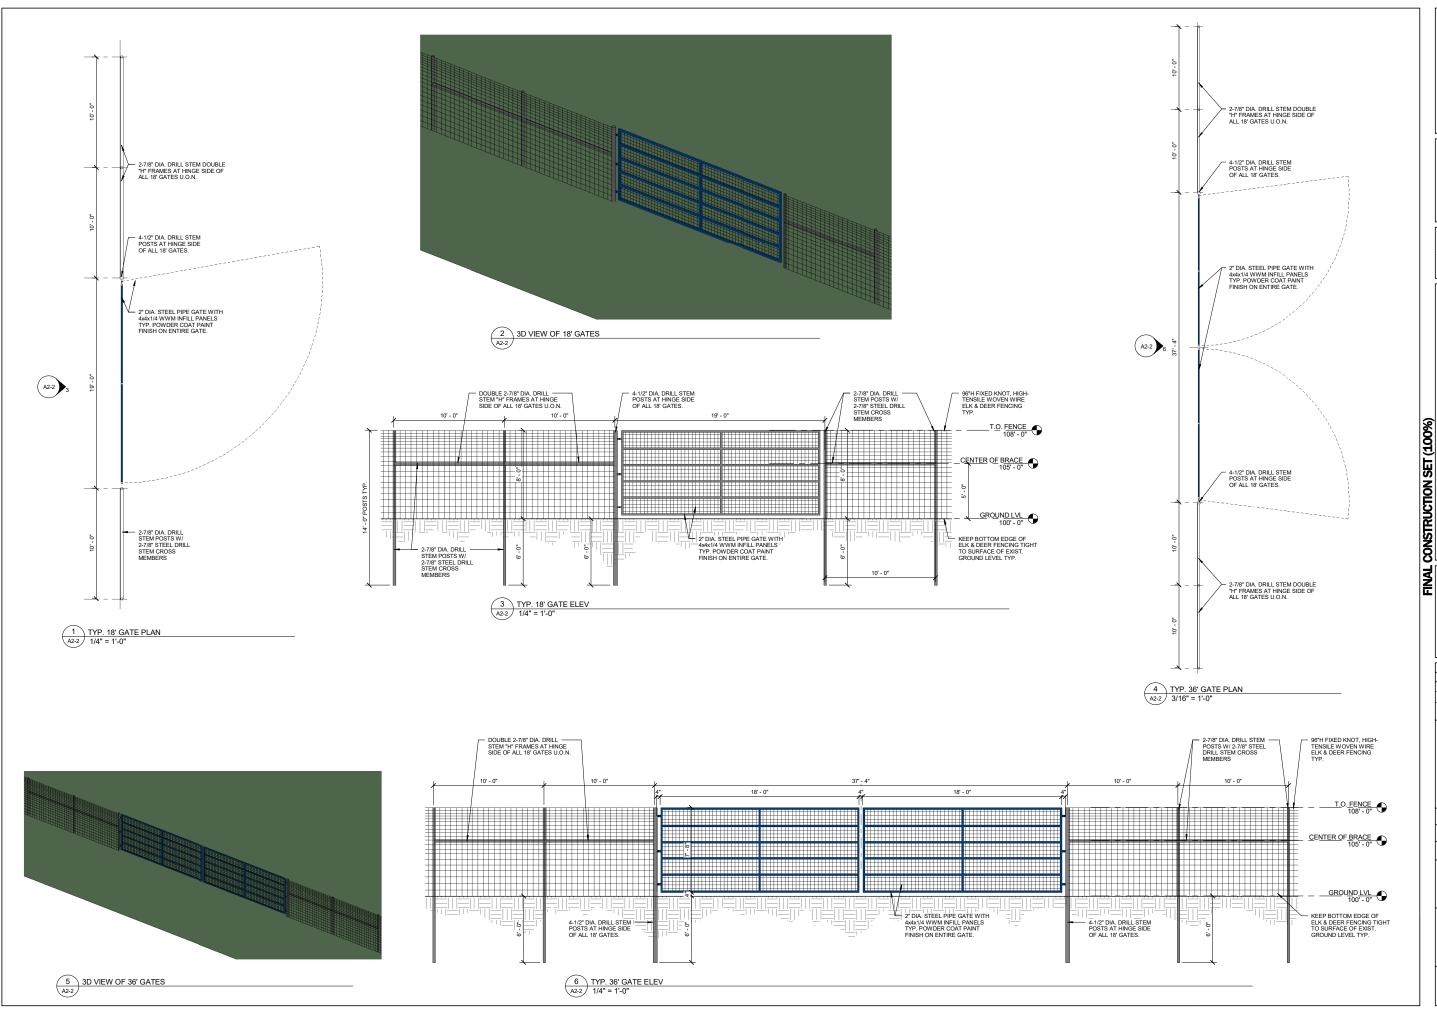


PPA#21- 0122 A/E#00-00-00 CONSULTANT#:

SHEET TITLE CORNERS &

H-FRAMES SHEET

A2-1







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WILDLIFE FENCE

LUTZ FARM

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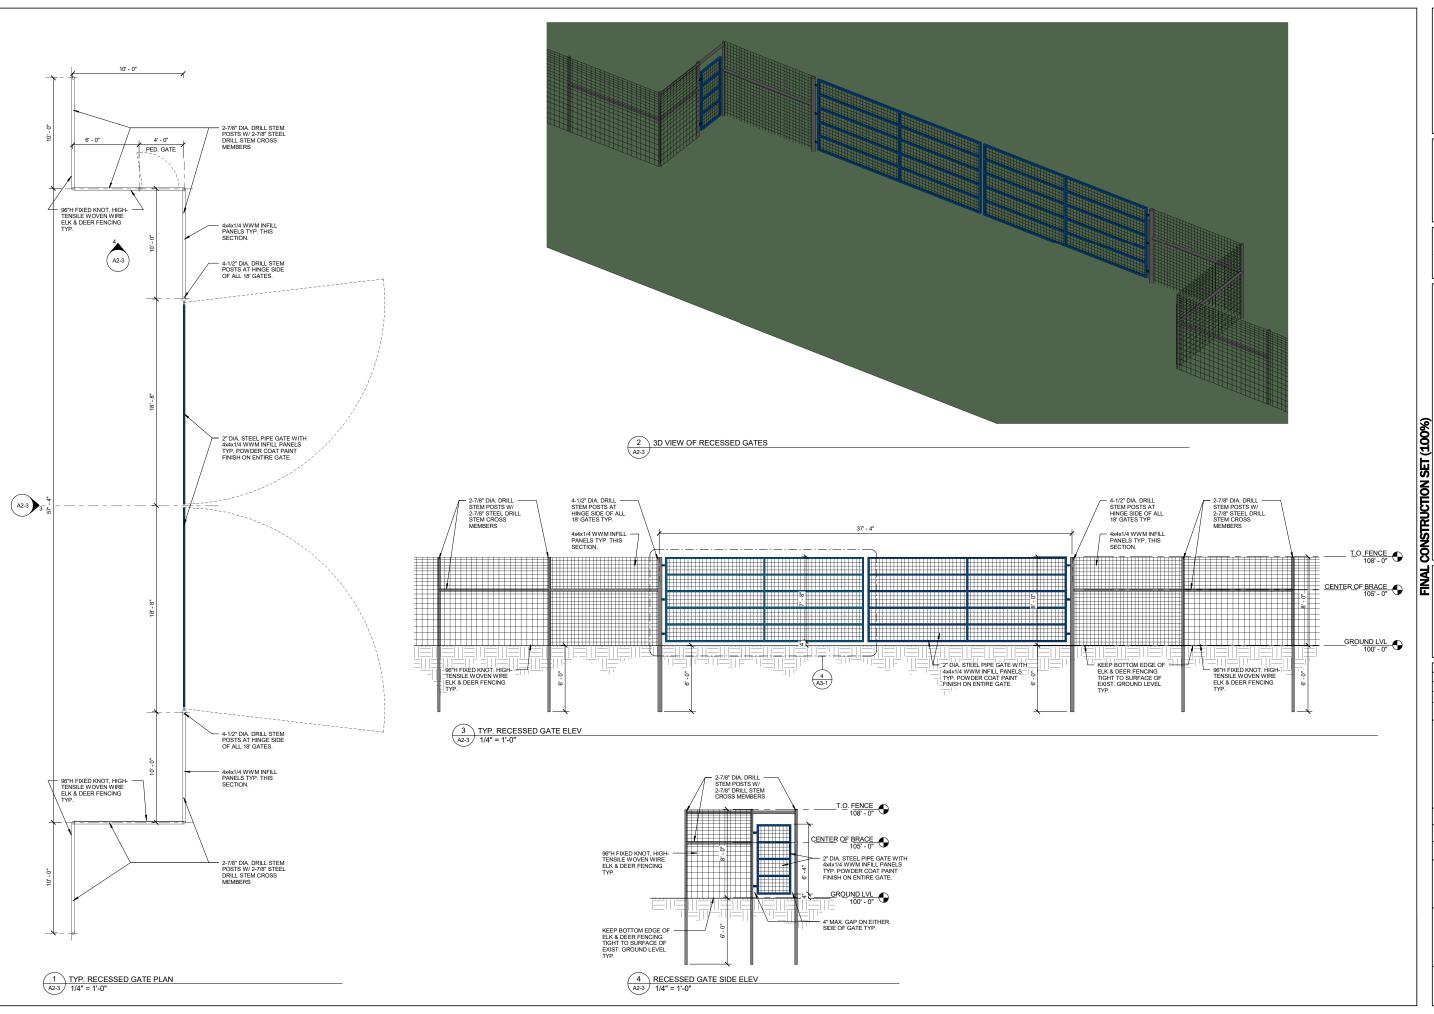
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SHEET TITLE 18' & 36' GATES

> SHEET **A2-2**







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WILDLIFE FENCE

LUTZ FARM

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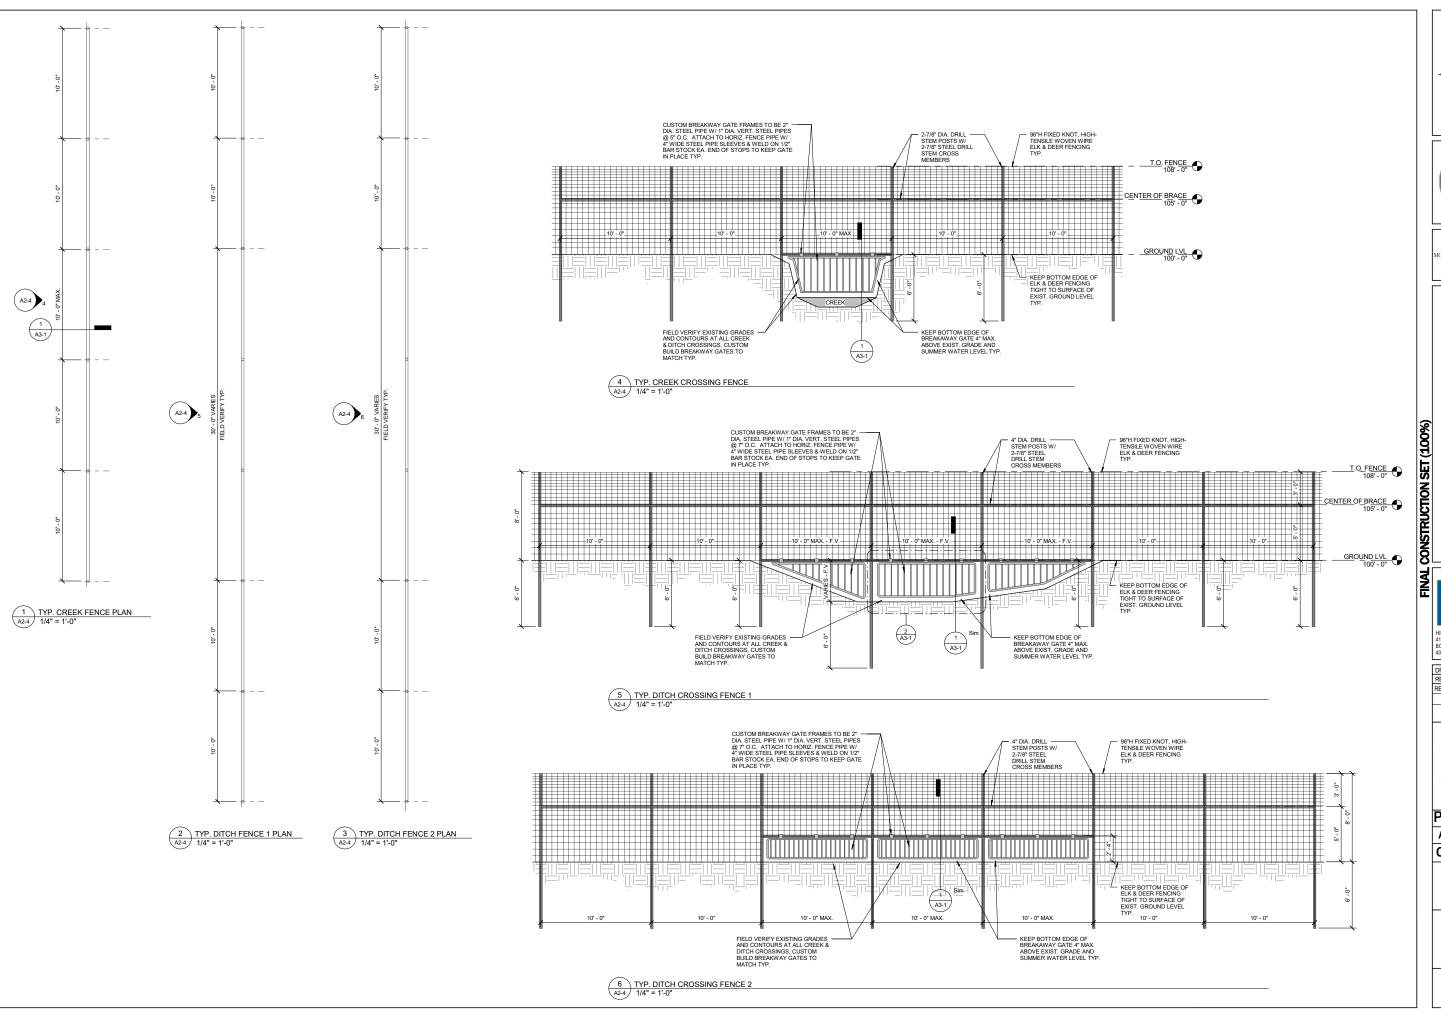


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RECESSED GATES

SHEET

A2-3







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ARM 田

WILDLIFE FENCE

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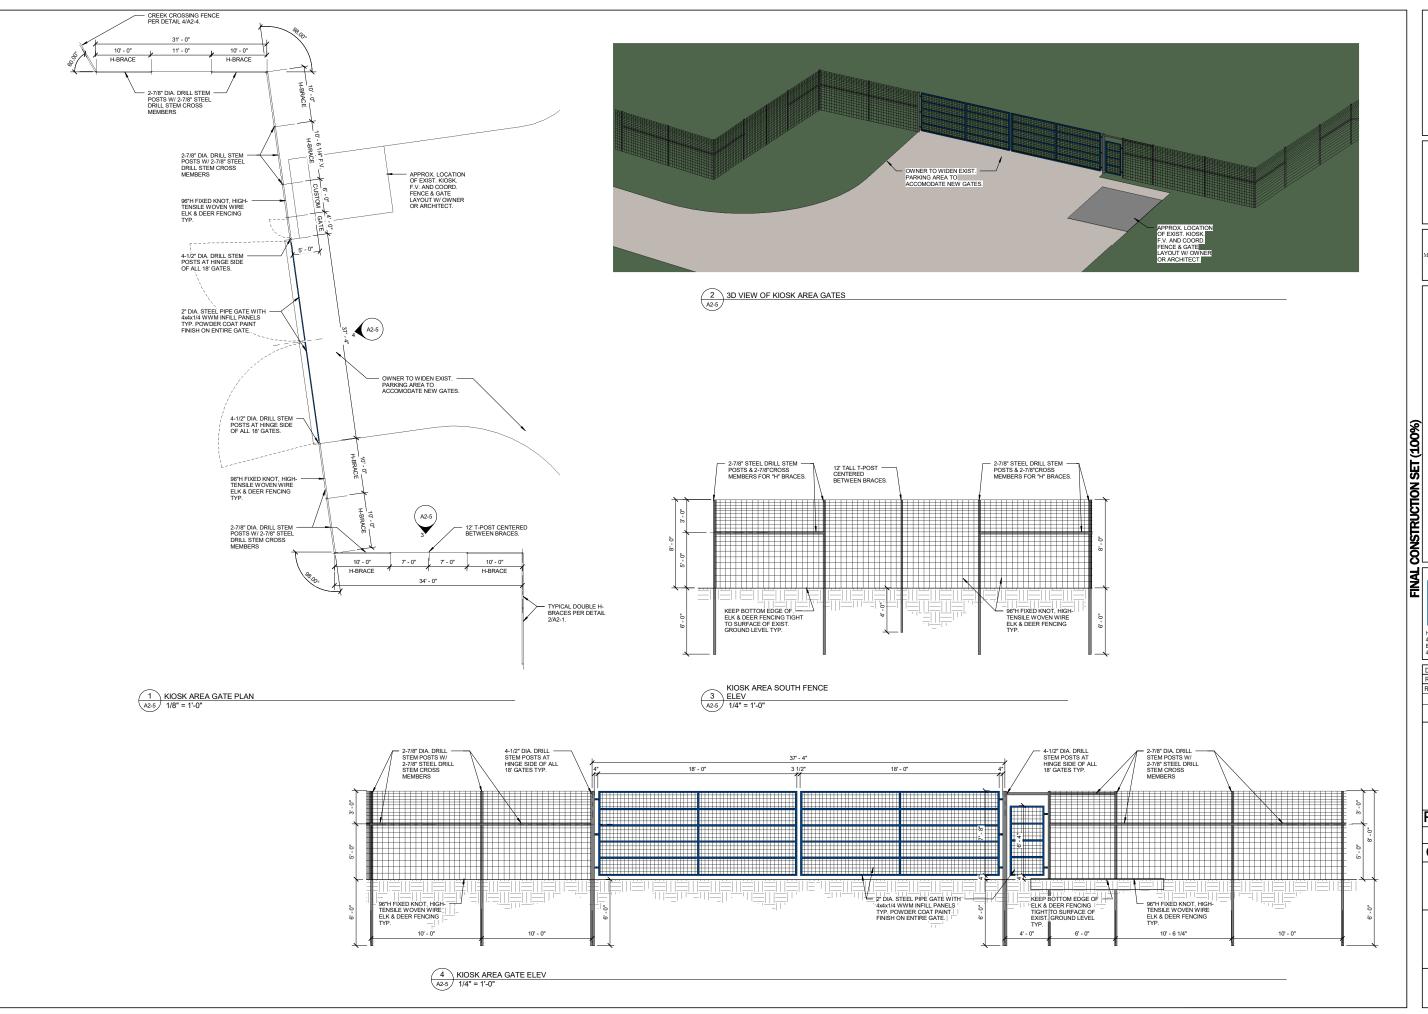


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SHEET TITLE **DITCH & CREEK**

FENCES SHEET

A2-4







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WILDLIFE FENCE

LUTZ FARM

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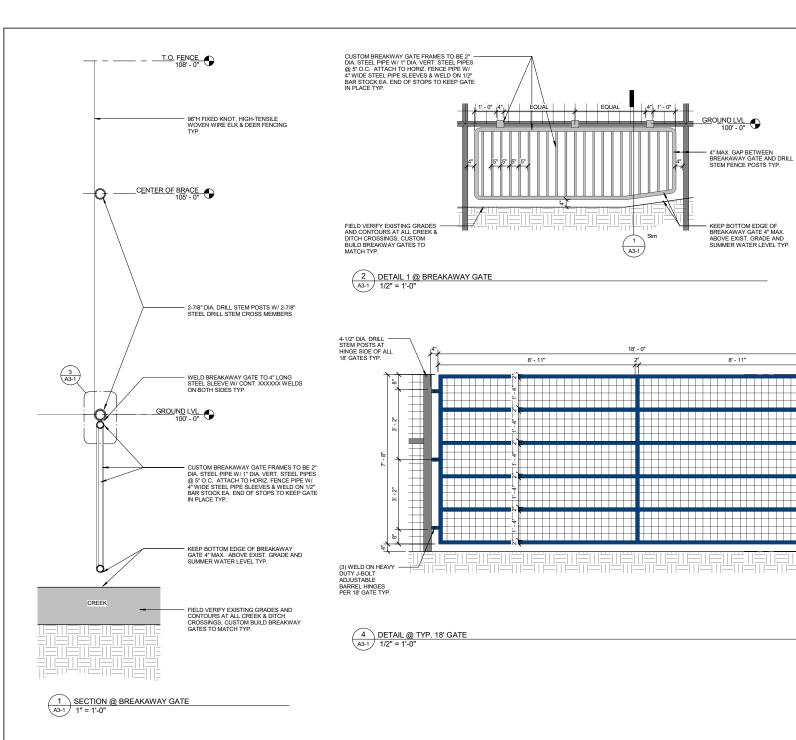



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SHEET TITLE

KIOSK GATES & **FENCES**

SHEET A2-5



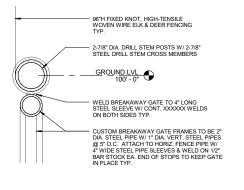

3 DETAIL 2 @ BREAKAWAY GATE
A3-1 3" = 1'-0"

T.O. FENCE 108' - 0"

2" DIA 13 GA (SHCED 40) STEEL PIPE GATE WITH 4x4x1/4
WWM INFILL PANELS TYP.
POWDER COAT PAINT FINISH
ON ENTIRE GATE.

(1) 24" GALV. CHAIN @ EACH PAIR OF 18' GATES AND (1) 32" GALV. CHAIN @ EA. SINGLE 18' GATE W/ ONE PADLOCK PER CHAIN TYP. ALL PADLOCKS TO HAVE MATCHING KEYING.

GROUND LVL 100' - 0"

PROJECT MATERIAL SPECIFICATIONS:

1. FIXED KNOT WILDLIFE FENCING: ALL WILDLIFE FENCING TO BE 96" HEIGHT WITH 20 HORIZONTAL WIRES AND VERTICAL WIRES AT 6" O.C. SPECIFIED AS 2096-6 12.5 GA HIGH TENSILE CLASS 3 FIXED KNOT GAME FENCE WITH A PROTECTIVE COATING ON ALL COMPONENTS TO PROVIDE A 30 YEAR WARRANTY. FENCING TO BE INSTALLED TIGHT TO THE SURFACE OF THE EXISTING GRADE AND INSTALLED WITH THE TIGHT 3 WIRE SPACING TOWARDS THE TOP AND INTENDED TO WIRE SPACING TOWARDS THE BOTTOM OF THE FENCE. BASIS OF SPECIFICATION IS SOLIDLOCK PRO 30 BY BEKAERT. APPROVED ALTERNATE MANUFACTURERS INCLIDE KENCOVE, HUTCHINSON AND STAY TUFF FENCE. SUSTITUTION ROUGHSTS FOR EQUAL OR GREATER PRODUCTS WILL BE REVIEWED BY OWNER AND ARCHITECT DURING THE BIDDING PROCESS.

2. T-POSTS: ALL T-POSTS TO BE GALVANIZED HEAVY DUTY T-POSTS WITH A STUDDED BOTTOM PLATE 12' IN LENGTH 1.33 2.1-90313. ALL 1-90313 TO BE GRAVINALED HEAVY TOUTH 1-90313 WITH A STUDIED BUT TOWN PAIR. I.Z. IN LENGTH, 1.33 LB PER FOOT. BASIS OF SPECIFICATION IS KENCOVE. PROVIDE GALVANIZED STEEL CLIPS FOR SECURELY ATTACHING WIRE FENCE TO T-POSTS FROM T-POST MANUFACTURER. PROVIDE ONE CLIP PER 12° OF POST HEIGHT ABOVE GROUND. 8° EXPOSED POST REQUIRES 9 CLIPS TYPICAL SUSTITUTION REQUESTS FOR EQUAL OR GREATER PRODUCTS WILL BE REVIEWED BY OWNER AND ARCHITECT DURING THE BIDDING PROCESS.

3. RATCHET STRAINERS: ALL RATCHET STRAINERS TO HAVE 11 TOOTH SPOOL FOR FINE TENSION CONTROL. GALVANIZED REINFORCED FRAME AND SPRING CLIP, HIGHLY CONDUCTIVE IF USED WITHIN AN ELECTRICAL STRAND. BASIS OF SPECIFICATION IS THE XT1 RATCHET STRAINER BY STRAINRITE FENCING SYSTEMS, PROVIDE ONE STRAINER FOR EACH HORIZONTAL WIRE AT EACH H-FRAME BRACE WHICH ARE LOCATED EVERY 1/4 MILE OR 1322'. SUSTITUTION REQUESTS FOR EQUAL OR GREATER PRODUCTS WILL BE REVIEWED BY OWNER AND ARCHITECT DURING THE BIDDING PROCESS.

4. CORNER FRAMES: ALL CORNERS, UNLESS OTHERWISE NOTED, TO RECEIVE DOUBLE H-BRACES CONSTRUCTED FROM 2-7/8° DRILL STEM PIPING WITH YERTICALS AT 10° O.C. AND A HORIZONTAL BRACE AT 5 ABOVE GRADE ALSO CONSTRUCTED FROM 2-7/8° DRILL STEM PIPE. SEE PLANS, ELEVATIONS AND 3D VIEWS ON SHEET 2-1 FOR MORE INFORMATION.

5. H-FRAME IN-LINE BRACES: ALL IN-LINE BRACES, UNLESS OTHERWISE NOTED, TO SINGLE H-BRACES CONSTRUCTED FROM 2-7/8" DRILL STEM PIPING WITH VERTICALS AT 10".0.C. AND A HORIZONTAL BRACE AT 5" ABOVE GRADE ALSO CONSTRUCTED FROM 2-7/8" POILL STEM PIPE. SEE PLANS, ELEVATIONS AND 30 VIEWS ON SHEET A2-1 FOR MORE

6. GATE FRAME POSTS AND BRACES: HINGE SIDE OF ALL 18' GATES TO HAVE A 4-1/2" DIA. X 14' LONG GATE POST AND AN ADJACENT DOUBLE H-BRACE CONSTRUCTED FROM 2-7/8" DRILL STEM PIPING WITH VERTICALS AT 10' O.C. AND A HORIZONTAL BRACE AT 5' ABOVE GRADE ALSO CONSTRUCTED FROM 2-7/8" DRILL STEM PIPE. SEE PLANS, ELEVATIONS AND 3D VIEWS ON SHEET A2-2 & A2-3 FOR MORE INFORMATION.

7. CUSTOM FABRICATED METAL GATES: ALL GATE FRAMES TO BE FABRICATED FROM 2" DIA. 13 GAUGE STEEL PIPE AND INFILLED WITH 4x4x1/4" WELDED WIRE FABRIC AS INDICATED ON SHEET A3-1.

8. AGTE ACCESSORIES:
A LOCKS AND CHAINS. PROVIDE ONE MASTERLOCK PADLOCK AND ONE CHAIN HARDWARE PACKAGE FOR EACH SINGLE 16'
GATE AND EACH PAIR OF TWO 16' GATES. ALL PADLOCKS TO BE KEYED THE SAME SO THAT ONE KEY WILL OPEN ALL OF
THE GATE LOCKS. CHAIN HARDWARE PACKAGE SHALL BE MINIMUM OF 2*LONG FOR PAIRED GATES AND 30' LONG FOR
SINGLE GATES. SASIS OF PEPCIFICATIONS IS BEHLER OF A WARDWARE PACKAGE. SUSTITUD NECOLESTS FOR
SINGLE GATES. SASIS OF PEPCIFICATIONS IS BEHLER OF A WARDWARE PACKAGE. SUSTITUD NECOLESTS FOR
SINGLE GATES. ALL CATE HINGES TO BE REFLEVED OF A WARDWARE PACKAGE. SUSTITUD NECOLESTS FOR
SINGLE GATES HORE. ALL CATE HINGES TO BE HEAVY DIVINED ON JABOLT ADJUSTABLE BARREL HINGES TO BE HEAVY DIVINED ON JABOLT ADJUSTABLE BARREL HINGE MAY DE HEAVY DIVINED ON JABOLT AND MATTACHES TO THE GATE
POST AND JABOLT ARM ATTACHES TO GATE HINGE POYDTS ON A STEEL BALL BEARNEL AND SEARCH SERVED ON THE CATE ON THE CATE OF THE POWDER COAT FINISH. APPROVED ALTERNATE MANUFACTURERS INCLUDE KENCOVE, HUTCHINSON AND STAY TUFF FENCE. SUSTITUTION REQUESTS FOR EQUAL OR GREATER PRODUCTS WILL BE REVIEWED BY OWNER AND ARCHITECT

FENCE. SUSTITUTION REQUESTS FOR EQUAL OR GREATER PRODUCTS WILL BE NEVIEWED BY UWINER AND ANCAPILE OF DURING THE BIDDING PROCESS.

C. GATE WHEELS. PROVIDE EACH 18' GATE WITH ONE 6' DIAMETER TIRE GRADE SOLID RUBBER GATE WHEEL WITH CLAMP TO FIT? 2'D ACATE FRAME ALL WITH GALVANIZED FINISH ON ALL STEEL PARTS FOR RUST FREE FINISH. BASIS OF SPECIFICATION IS MOFFEZ GATE WHEEL FOR METAL SWING GATE WITH MAX. 2'D DA. FRAME. SUSTITUTION REDUESTS FOR EQUAL OR GREATER PROPUCTS WILL BE REVIEWED BY OWNER AND ARCHITECT DURING THE BIDDING PROCESS.

D. MAN GATE LATCHES. PROVIDE EACH 4" MAN GATE WITH ONE 2-WAY LOCKGABLE STEEL GATE LATCH FOR 2'D DA. ROUND TUBE GATE FRAME. BASIS OF SPECIFICATION IS SPEECO S16100100. APPROVED ALTERNATE MANUFACTURERS INCLUDE POWERFIELDS, KOCH INDUSTRIES AND IRONTON. SUSTITUTION REQUESTS FOR EQUAL OR GREATER PRODUCTS WILL BE REVIEWED BY OWNER AND ARCHITECT DURING THE BIDDING PROCESS.

8. DRILL STEM PIPE:
A 2-7/8" OWNER WILL PROVIDE 80 PIECES OF 2-7/8" DIA. DRILL STEM PIPE IN 30" LENGTHS, ALL FABRICATION, CUTTING, WELDING, SUPPLIES, EQUIPMENT, INSTALLATION AND FABRICATION LABOR, ACCESORIES AND ADDITIONAL PIPE AS REQUIRED TO COMPLETE THE PROJECT WILL BE PROVIDED SY FENCING CONTRACTOR.
B. 4-1/2" - OWNER WILL NOT PROVIDE ANY 4-1/2" DIA DRILL STEM PIPE. ALL FABRICATION, CUTTING, WELDING, SUPPLIES, EQUIPMENT, INSTALLATION AND FABRICATION LABOR, ACCESORIES AND ADDITIONAL PIPE AS REQUIRED TO COMPLETE THE PROJECT WILL BE PROVIDED BY CHICAGO FOR ACCESORIES AND ADDITIONAL PIPE AS REQUIRED TO COMPLETE C. ALL SIZES OF DRILL STEM PIPE PROVIDED BY THE FENCING CONTRACTOR SHALL BE FROM A SOURCE THAT GUARANTEES THE PIPE TO BE FREE FROM RADIATION AND OTHER TOXIC CHEMICALS.

10. WELDING: A. ALL WELD BACK UP BARS SHALL BE REMOVED AND GROUND SMOOTH AFTER WELD IS COMPLETED UNLESS NOTED

3. ALL WELDS INDICATED SHALL MEET THE MINIMUM SIDE SPECIFIED BY THE AISC MANUAL OF STEEL DESIGN (SINGLE

B. ALL WELDS INDICATED SHALL MEET 1 HE MINIMUM SIDE SPECIFIED BY THE ASSO MEMORY OF A COUNTRY OF ASS AS REQUIRED).

C. ALL WELDS SHALL BE PERFORMED BY QUALIFIED WELDERS IN ACCORDANCE WITH A. W. S. SPECIFICATIONS, LATEST EDITIONS, ALL WELDING ELECTRODES SHALL CONFORM TO A.W. S. AS. 1 GRADE E-70, BARE ELECTRODES AND GRANULAR FLUX SHALL CONFORM TO A.W. S. AS. 17, F70 A.W. S. FLUX CLASSIFICATION.

D. WELDING ELECTRODES WILL BE FOXX, WELDS 1/8" MIN ON GATES, POSTS AND BRACES, ALL WELDING AND TESTING OF WELDS WILL BE IN ACCORDANCE WITH AMERICAN WELDING SOCIETY OF CODES AND RECOMMENDATIONS. WELDERS SHALL HOLD CURRENT VALID CERTIFICATIONS.





MSU-CPDC

FENCE

WILDLIFE

FAX: 406.994.5665

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HIP & HUMBLE ARCHITECTURE, LLC 418 S. 5TH AVE. BOZEMAN MT 50745 406.581.3832

DRAWN BY: RM
REVIEWED BY: DB REV. DESCRIPTION DATE



PPA#21-0122 A/E#00-00-00 CONSULTANT#:

> SHEET TITLE **DETAILS &**

SPECIFICATIONS SHEET

A3-1























#3. STAGING AREA



#4. EXISTING FENCE / SHED





EXISTING CREEK / SILOS





































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LUTZ FARM WILDLIFE FENCE

FINAL CONSTRUCTION SET (100%) HIP & HUMBLE ARCHITECTURE, LLC 418 S. 5TH AVE. BOZEMAN MT 59715 406.581.3832

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CONSULTANT#: SHEET TITLE

EXISTING CONDITIONS SHEET

A4-1















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LUTZ FARM









PPA#21- 0122 A/E#00-00-00 CONSULTANT#:

SHEET TITLE EXISTING CONDITIONS

SHEET

DATE 08.15.23













#44. VIEW OF NORTH ELECTRICAL, DITCH & FENCE

#35. VIEW OF SW CULVERTS

#36. VIEW OF WEST FENCING

#39. VIEW OF NORTH HEADGATE

#40. VIEW OF WEST CREEK

#43. VIEW OF N FENCES







#45. VIEW OF NE HEADATE

#46. VIEW OF NE KIOSKS

#49. VIEW OF EAST CULVERT

#50. VIEW OF EAST CULVERT

#53. VIEW OF SE CULVERT / DRAINAGE

#54. VIEW OF SE CULVERT / DRAINAGE



#47. VIEW OF GAP IN VEGETATION FOR NEW CREEK FENCE BEHIND NORTH KIOSK



#48. VIEW OF NE CREEK, CULVER, GATE AND FENCES



#51. VIEW OF EAST SE CULVERT



#52. VIEW OF EAST SE DRAINAGE



#55. VIEW OF SE CORNER WELL HEAD AND PIT



#56. VIEW OF SE DRAINAGE



