PROJECT LOCATION 1ONTANA STATE UNIVERSITY 51 W. GRANT ST.

PROJECT SUMMARY

PROJECT SCHEDULE

08.03.2023 CONSTRUCTION STARTS

01.12.2024 FINAL COMPLETION

01.05.2024 SUBSTANTIAL COMPLETION

06.16.2023 SENT OUT FOR BID

UNIVERSITY FOOD SERVICES WITH SUPPORT OF VARIOUS CONSTITUENT

GROUPS INCLUDING ASMSU WOULD LIKE TO IMPROVE FOOD OPTIONS

WITHIN THE STRAND UNION BUILDING (SUB) TO BETTER SERVE STUDENTS

AND CAMPUS VISITORS. THE PROJECT WILL RENOVATE AND BUILD-OUT

A RESTAURANT CONCEPT FRANCHISED FROM A NATIONAL FOOD

VENDOR IN THE SUB UNION MARKET, AS WELL AS MAKE NECESSARY

INFRASTRUCTURE UPDATES TO SUPPORT THE NEW RESTAURANT. THE

TH , 2023. THE CONSTRUCTION WINDOW WILL BE END OF MAY TO

ARE NOT IN SCHOOL) TO ALLEVIATE ANY CONSTRUCTION AREA

MIDDLE OF OCTOBER (OVER THE SUMMER MONTHS WHEN STUDENTS

CONGESTION WITH THE ADDED STUDENT TRAFFIC THROUGH THE AREA

07.12.2023 PRE-BID WALK-THROUGH, MEET @ PLEW BUILDING, 2PM

07.19.2023 BIDS RECEIVED UNTIL 2PM, PLEW BUILDING

08.02.2023 CONTRACT IS FINALIZED WITH CONTRACTOR

RENOVATION WILL BE PUBLICLY BID DURING THE MONTHS OF APRIL &

MAY, WITH CONTRACTOR NOTICE TO PROCEED ANTICIPATED BY MAY 25

DRAWN BY:

plan one / architects

REVIEWED BY: REV. DESCRIPTION DATE

PPA#22-0056 A/E#00-00-00

Consultant #: SHEET TITLE

COVER SHEET

SHEET

16.06.2023



STANDARD ABBREVIATIONS

Cast Iron

Ceilina

Closet

Cleanout

Concrete

CONST.JT. Construction Joint

Coordinate

Ceramic Tile

Cold Mater

Detail

Diameter

Dimension

Dampproofing

Draftstopping

Downspout

Drawing

Each End

Cold Rolled Angle

Drinking Fountain

Dispenser/Disposal

Electrical Contractor

Expansion Joint Cover LOC

Exterior Insulation

and Finish System

Expansion Joint

Corridor

Continuous

Column

CONTR Contractor

C.M.U.

COORD

CORR

DMG

Control Joint

MASR'Y Masonry Block Elevation MAT/MAT'L Material Air Conditioning Electrical/Electric Acoustical Ceiling Tile ELEV Elevator/Elevation Ad iustable. Ad jacent MECH E/0 Equipment by Owner MEMB.W.P. Membrane Waterproofing Above Finish Floor E.P.D.M. Ethylene Propylene Air Infiltration Barrier Diene Monomer MFR/MFG Manufacturer/Manufacturing STD Expanded Polystyrene Alternate Aluminum APPROX Approximate FQUIP Equipment Architectural/Architect E.W.C. Electric Mater Cooler Exterior Wall System Aluminum Threshold EXIST/(E) Existing Expansion BLDG EXT Exterior Block Floor Drain BLKG Blocking Foundation Bench Mark F.E. Fire Extinguisher Bullnose B.O.F Bottom of Footing FLR/FL Floor BRG Bearing F.N.D. **BSMNT** Feminine Napkin Vendor Bottom F.O.B. Face of Brick F.O.F. BTMN Face of Foundation Betweer Built-up F.O.S. Face of Stud Borrowed Lite FR Frame Flushing Rim Sink F.S. Cabinet Floor Sink Cement

M.O. NEC'Y N.I.C. Feminine Napkin Disposal N.T.S. 0.C. 0.D. OPNG OPP.H. Feet/Foot FTG Footing FURR Construction Manager GALV Galvanized Concrete Masonry Unit G.B. Grab Bar P.LAM. General Galvanized Iron G.M.B. PREFAB Gypsum Mallboard

Hose Bibb

Handicapped

Hollow Core

Heavy Duty

Hardener

Hardware

Horizontal

Hair Dryer

Hot Mater

Inch/Inches

Information

Insulation

Interior

Invert

Joint

Location

Including

Inside Diameter

Long Leg Horizontal Long Leg Vertical

Hour

Heiaht

Hollow Metal

H.D.

HDM

H.M.

HDNR

HORZ

H.M.

I.D.

INCL

INFO

INSUL

INV

L.L.H.

L.L.Y.

PAIR Plate Plastic Laminate Plaster PLAS.LAM. Plastic Laminate Plywood Prefabricated P.T.D. Paper Towel Dispenser PTM Pressure Treated Mood QT Quarry Tile Remove Radius R.D. Roof Drain RECMND Reference REINF REQ'D Reauired

S.G.T.

Recommendation Reinforce/Reinforcing Retain/Retained REV Revisions Resilient Flooring RM R.O. Rough Opening Solid Core S.C. SCHED Schedule Solid Core Mood Soap Dispenser SECT Section Square Feet Special Floor Coating

Structural Glazed Tile

Shower

V.C.T. VENT VERT V.I.F. VISQ.I.B. Visqueen Vapor Barrier V.S.G. Y.T.R. **VMC** M.C.

NOTE: NOT ALL

Mechanical

Mezzanine

Manhole

Minimum

Miscellaneous

Metal Liner Panel

Metal Toilet Partition

Masonry Openina

Metal Threshold

Necessary

Not To Scale

On Center

Overhead

Openina

OVER

Opposite

Nominal

Not in Contract

Overall Frame

Opposite Hand

Outside Diameter

ABBREVIATIONS ARE USED

Sheathing

Specifications

Stainless Steel

Similar

Sauare

Steel

Storage

Standard

Structural

Suspended

Tempered

Top of Beam

Top of Joist

Top of Steel

Underground

Unexcavated

Unfinished

Underside

Vertical

Treated

Typical

Top of Concrete

Top of Footing

Top of Masonru

Toilet Paper Dispenser

Underwriters Laboratory

Unless Noted Otherwise

Vinyl Composition Tile

∨entilation/∨entilator

Verify in Field

Vinyl Sheet Goods

Vent Thru Roof

Vinyl Mallcovering

Special Mall Coating

SHTG

SPECS

STOR

STRUCT

S.M.C.

TEMP

T.O.C.

TOIL T.O.J.

T.O.M.

T.O.S.

T.P.D.

TYP

TRTD

UNEXC

UNFIN

U.S.

U.N.O.

T.O.F.

T.O.BM.

SQ

Mith Mater Closet Mood MDM/MDO Mindow Mithout Waterproof Mater Receptacle Melded Mire Fabric

- SHEET DRAWN ON INDICATES CENTER LINE

NOTE: NOT ALL SYMBOLS ARE USED

KEY TO SYMBOLS

NUMBER

NUMBER

ROOMNAME

(XXX)

DOOR OR GATE

ROOMNAME & NUMBER

KEYED NOTE NUMBER

WALL TYPE LETTER

TOILET ACCESSORY

- INTERIOR ELEV. NUMBER

- CEILING TYPE

- CEILING HEIGHT

EXTERIOR WINDOW LETTER

BORROWED LITE SYMBOLS

SIM BUILDING SECTION LETTER OWNER: MONTANA STATE UNIVERSITY UNIVERSITY FACILITIES MANAGEMENT SHEET DRAWN ON PLANNING, DESIGN, AND CONSTRUCTION PO BOX 172760 - MALL SECTION NUMBER BOZEMAN, MT 59717 PHONE: (406) 994-5413

CONTACT: ASHNA PETERS - SHEET DRAWN ON DESIGN ARCHITECT (CFA) - DETAIL NUMBER MAYSE AND ASSOCIATES DALLAS, TX 75254 - SHEET DRAWN ON

- EXTERIOR ELEVATION ARCHITECT: PLAN ONE/ARCHITECTS - SHEET DRAWN ON BOZEMAN, MT. 59718 INTERIOR & EXTERIOR PHONE: (406) 219-5992

> STRUCTURAL ENGINEER: PLAN ONE/ARCHITECTS BOZEMAN, MT. 59718 PHONE: (406) 219-5992

> > CONTACT: KIP WEEDA

CONTACT: DARIN VAN OOSTERHOUT

INDEX A1.0 CAMPUS MAP

CR1.1 CODE REVIEW PLAN

DEMO PHOTOS

A2.2 CFA FINISH SCHEDULE

3D VIEWS

A4.1

ROOF PLAN

A10.1 DOOR SCHEDULE

K8.4 KITCHEN DETAILS

K8.5 KITCHEN DETAILS

K8.6 KITCHEN DETAILS

MALL SECTIONS

D2.1 DEMO PHOTOS

DEMO FLOOR PLAN

D11.1 DEMO REFLECTED CEILING PLAN

OVERALL FLOOR PLAN

ROOM FINISH SCHEDULE

ACCESSIBILITY DETAILS

INTERIOR ELEVATIONS

BRANDING PLAN AND SCHEDULE

KITCHEN EQUIPMENT SCHEDULE

ELECTRICAL ROUGH IN ELEVATION

KITCHEN EQUIPMENT PLAN

K2.2 KITCHEN EQUIPMENT SCHEDULE

K8.2 ELECTRICAL ROUGH IN ELEVATION

K8.3 PLUMBING ROUGH IN ELEVATION

CASEMORK DETAILS

A11.1 REFLECTED CEILING PLAN

AD1.1 DIMENSION FLOOR PLAN

ARCHITECTURAL

14881 QUORUM DR., SUITE 800 PHONE: (972) 386-0338

PROJECT TEAM

CONTACT: JOHNNY WENCES 1174 STONERIDGE DR. SUITE 213

CONTACT: MICK DUFF, AIA, PROJECT ARCHITECT 1174 STONERIDGE DR. SUITE 213

MECHANICAL ENGINEER: ACE, INC. 12 N. BROADWAY BELGRADE, MT. 59714 PHONE: (406) 388-3320

CONTACT: JEFF WENKE, P.E.

ELECTRICAL ENGINEER ACE, INC. 12 N. BROADWAY BELGRADE, MT. 59714 PHONE: (406) 388-3320

ELECTRICAL

E1.0 ELECTRICAL COVER SHEET E2.0 PANEL SCHEDULES ED3.0 ELECTRICAL DEMOLITION PLAN E3.0 FIRST FLOOR POWER AND DATA PLAN

E4.0 ROOF POWER PLAN E5.0 FIRST FLOOR LIGHTING PLAN E6.0 ELECTRICAL DETAILS

MECHANICAL

M1.0 MECHANICAL COVER SHEET AND SCHEDULES M2.1 FIRST FLOOR MECHANICAL DEMO PLAN M2.2 ROOF MECHANICAL DEMO PLAN M3.1 FIRST FLOOR MECHANICAL REMODEL PLAN

M4.0 MECHANICAL DETAILS

<u>PLUMBING</u> P1.0 PLUMBING COVER SHEET

M3.2 ROOF MECHANICAL REMODEL PLAN


P1.1 PLUMBING SCHEDULES P2.0 BASEMENT PLUMBING DEMO PLAN P2.1 FIRST FLOOR PLUMBING DEMOLITION PLAN

P2.2 ROOF PLUMBING DEMO PLAN P3.0 BASEMENT PLUMBING REMODEL PLAN P3.1 FIRST FLOOR PLUMBING REMODEL PLAN P3.2 ROOF PLUMBING REMODEL PLAN

PRODUCT	VENDOR	CONTACT	PHONE	EXT	EMAIL	REMARKS
BRAND MESSAGING & INTERIOR SEATING	FCC	MICHELLE GANSKO	800-322-7328	EXT 235	MICHELLE.GANSKO@FCCFURN.COM	WEST REGION
BRAND STEEL WALL FABRICATION	FCC	MICHELLE GANSKO	800-322-7328	EXT 235	MICHELLE.GANSKO@FCCFURN.COM	WEST REGION
DIGITAL MENU BOARDS (LCV LOCATIONS ONLY)	CINEPLEX DIGITAL MEDIA (CDM)	PETE FLETCHER	519-584-1816		CFA-ACCOUNT@CINEPLEX.COM	WWW.CDMEXPERIENCES.COM
EQUIPMENT (KITCHEN)	STRATEGIC / TRIMARK	CFA LICENSING TEAM	800-304-0849	OPTION 3	CFALICENSING@STRATEGICEQUIPMENT.COM	
FRP PANELS (KITCHEN)	MARLITE	MIKE FREW	330-260-7623		MFREW@MARLITE.COM	GC TO ORDER FROM LOCAL DISTRIBUTOR
GROUT	DAL TILE	TERRIE MILLER	216-409-3153		TERRIE.MILLER@DALTILE.COM	
LIGHTING	VILLA LIGHTING	DAVE CHRISTANELL	800-325-0963		DAVE.CHRISTANELL@VILLALIGHTING.COM	MIDWEST, NORTHEAST, SOUTHWEST, & WEST REGIONS
METAL FINISH	ALPHA COATINGS TECHNOLOGIES	JENO MUTHIAH	630-268-8787		JENO@ALPHACOATINGTECH.COM	
PAINT (INTERIOR)	SHERWIN WILLIAMS	MATTHEW HEALD	404-323-2263		MATTHEW.J.HEALD@SHERWIN.COM	GC TO ORDER FROM LOCAL DISTRIBUTOR
SIGNAGE	CLAYTON SIGN	SAM FLEET	404-361-3800		SAMFLEET@CLAYTONSIGNS.COM	SIGNAGE MUST BE ORDERED THROUGH TRIMARK STRATEGIC
STAINLESS STEEL DOOR	ELIASON	LAUREN WILLIAMS	269-492-3922		LAURENW@ELIASONCOPR.COM	
TILE (FLOOR) T-3, T-4, KT-2A, KT-2B	DAL TILE	TERRIE MILLER	216-409-3153		TERRIE.MILLER@DALTILE.COM	
TILE (WALL) T-1 SERIES, T-2, T-6	DAL TILE	TERRIE MILLER	216-409-3153		TERRIE.MILLER@DALTILE.COM	
WOOD (DECORATIVE)	SKYLAR MORGAN	KRISTA LITTLE	404-565-0537	EXT. 115	KRISTA@SKYLARMORGANFURNITURE.COM	
WOOD (WAINSCOTING)	FCC	MICHELLE	800-322-7328	EXT 235	MICHELLE.GANSKO@FCCFURN.COM	WEST, SOUTHWEST, AND MIDWEST REGIONS

P4.0 PLUMBING DETAILS

CHICK EIL A MATIONAL ACCOUNTS

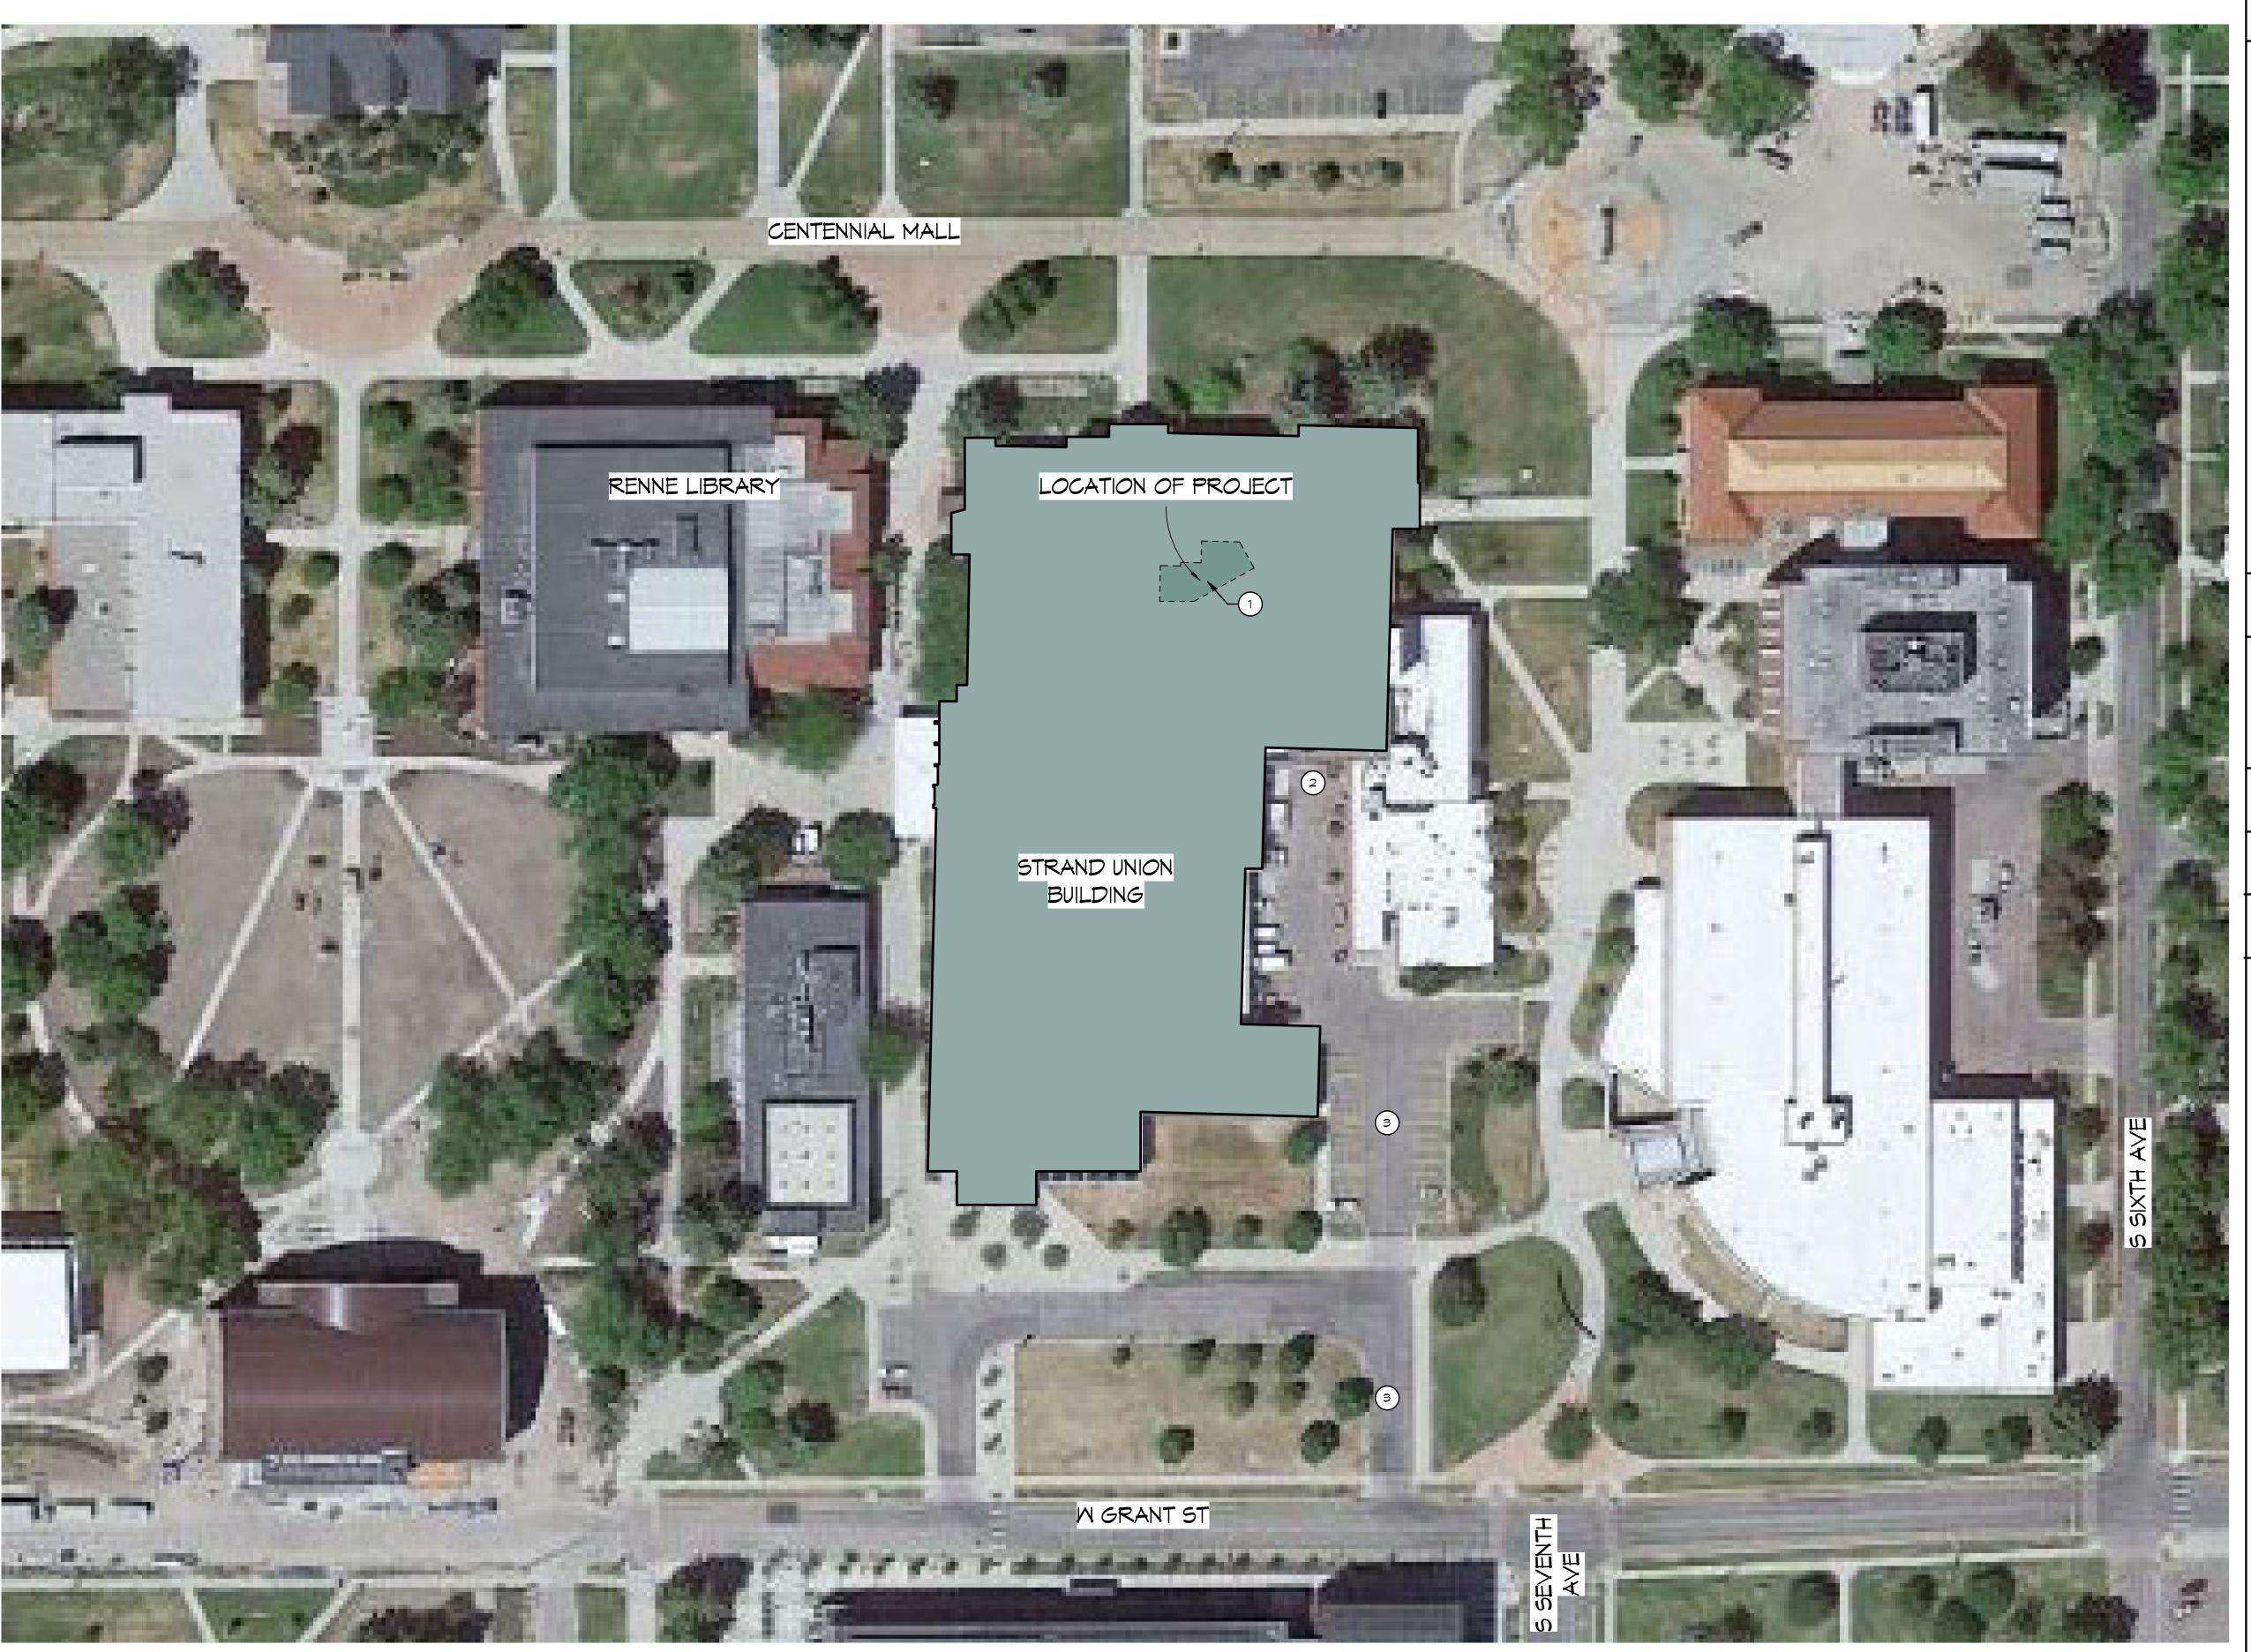

2 ENLARGED CAMPUS AERIAL MAP

1/4" = 1'-0"

GENERAL NOTES

- PARTITION DIMENSIONS ARE TYPICALLY FACE OF STUD.
- SEE ARCHITECTURAL DIMENSION PLANS AD1.X SERIES FOR DIMENSIONS AND WALL TYPES.
- SEE CODE REVIEW PLAN CR1.1 FOR FIRE RATED WALL LOCATIONS.
- SEE A2.1 DRAWING FOR ROOM FINISH SCHEDULE AND DETAILS.
- SEE A4.X SERIES DRAWINGS FOR ROOF PLANS.
- 6. SEE A8.X FOR ENLARGED FLOOR PLANS, INTERIOR ELEVATIONS AND
- SEE A10.X SERIES DRAWINGS FOR DOOR INFORMATION.
- SEE A11.X SERIES DRAWINGS FOR REFLECTED CEILING PLANS.
- PROVIDE TEMPORARY BARRICADE DURING CONSTRUCTION AS NECESSARY BY LOCAL ORDINANCES; COORDINATE WITH PROJECT AND FACILITIES MANAGERS.
- 2. SOFFITS AND SUSPENDED CEILINGS SHALL BE SECURED TO STRUCTURAL FRAMING ONLY; SEE DETAILS.
- FLOOR DRAINS REQUIRED IN ALL KITCHENS, FOOD PREPARATION AREAS, ANY OTHER LOCATIONS WHERE WATER IS USED.
- 12. PROTECT AND MAINTAIN ACCESS TO ANY EXISTING HVAC, ELECTRICAL AND PLUMBING SYSTEMS INCLUDING, BUT NOT LIMITED TO, CLEANOUTS, VALVES, DAMPERS, JUNCTION BOXES, SMOKE DETECTORS, ETC.
- 13. ALL TRANSITIONS BETWEEN DISSIMILAR FLOOR MATERIALS MUST BE FLUSH AND LEVEL.
- 14. CONTRACTORS IS REQUIRED TO PURCHASE CAMPUS PARKING PERMITS THROUGH THE UNIVERSITY POLICE.

ARCHITECTURAL STAGING NOTES

NOTED THUS: $\stackrel{(\times)}{}$

- 1) STAND UNION BUILDING (SUB) CONTRACTOR CONSTRUCTION ZONE IN UNION MARKET (RM 253).
- 2 LOCATION OF ELEVATED LOADING DOCK FOR CONTRACTOR USE
- 3) CONTRACTOR ACCESS VEHICULAR ROUTING TO PROJECT SITE

MECHANICAL STAGING NOTES

1. AUTOMATIC FIRE SPRINKLER SYSTEM SHALL BE OPERATIONAL THROUGH THE ENTIRE PROJECT.

CONTRACTOR STAGING GENERAL NOTES

- 1. THE CONTRACTOR SHALL MINIMIZE INTERFERENCE WITH ADJOINING STREETS, SIDEWALKS, PARKING AREAS, AND OTHER ADJACENT OCCUPIED OR USED FACILITIES DURING CONSTRUCTION OPERATIONS. THE CONTRACTOR SHALL NOT BLOCK STREETS, SIDEWALKS, OR ACCESS TO DUMPSTER LOCATIONS AT ANY TIME.
- 2. THE CONTRACTOR SHALL PROTECT EXISTING SITE IMPROVEMENTS AND LANDSCAPING FROM DAMAGE CAUSED BY CONSTRUCTION OPERATIONS TO CURRENT MSU STANDARDS OR AS DIRECTED BY THE OWNER PRIOR TO SUBSTANTIAL COMPLETION.
- 3. THE CONTRACTOR SHALL PROTECT EXISTING BUILDINGS FROM DAMAGE, CONTAMINATION, AND SOIING CAUSED BY CONSTRUCTION OPERATIONS. THE CONTRACTOR SHALL KEEP BUILDING ENTRANCES, CORRIDORS, AND STAIRWELLS CLEAR OF CONSTRUCTION MATERIAL, TOOLS, AND EQUIPMENT AT ALL TIMES. CONTRACTOR SHALL RESTORE EXISTING BUILDINGS DAMAGED BY CONSTRUCTION OPERATIONS AS DIRECTED BY THE OWNER PRIOR TO SUBSTANTIAL COMPLETION.
- 4. THE CONTRACTOR SHALL ACCESS THE SITE FROM WEST GRANT STREET.
- 5. ALL CONTRACTOR VEHICLES PARKED ON CAMPUS, INCLUDING VEHICLES OWNED BY EMPLOYEES AND CONTRACTOR, SHALL BE PARKED IN DESIGNATED PARKING AREAS ONLY.
- 6. CONSTRUCTION STAGING AREA: SHOULD THE CONTRACTOR REQUIRE ON SITE CONSTRUCTION STAGING, AN AREA FOR THIS PURPOSE WILL BE PROVIDED. THE CONTRACTOR SHALL RESTORE AREAS USED FOR CONSTRUCTION STAGING THAT ARE DAMAGED DURING THE COURSE OF CONSTRUCTION OPERATIONS TO CURRENT MSU STANDARDS OR AS DIRECTED BY THE OWNER PRIOR TO SUBSTANTIAL COMPLETION.
- CONTRACTOS SHALL VERIFY ALL DIMENSIONS AND JOB SITE CONDITIONS BEFORE COMMENCING MORK AND SHALL REPORT ANY DISCREPANCIES TO THE OWNER.
- THE OWNER WILL OCCUPY ADJACENT ROOMS UNTIL CONSTRUCTION IS COMPLETE IN THE AREA. CONTRACTOR TO SEQUENCE WORK IN COORDINATION WITH OWNERS OCCUPANCY.



MSU-

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UNIVERSITY

BOZEMAN, MONTANA

PHONE: 406.994.5413

DRAWN BY:

REVIEWED BY:

REV. DESCRIPTION DATE

plan one / architects




PPA#22-0056
A/E#00-00-00
Consultant #:

SHEET TITLE CAMPUS MAP

SHEET

A1.0

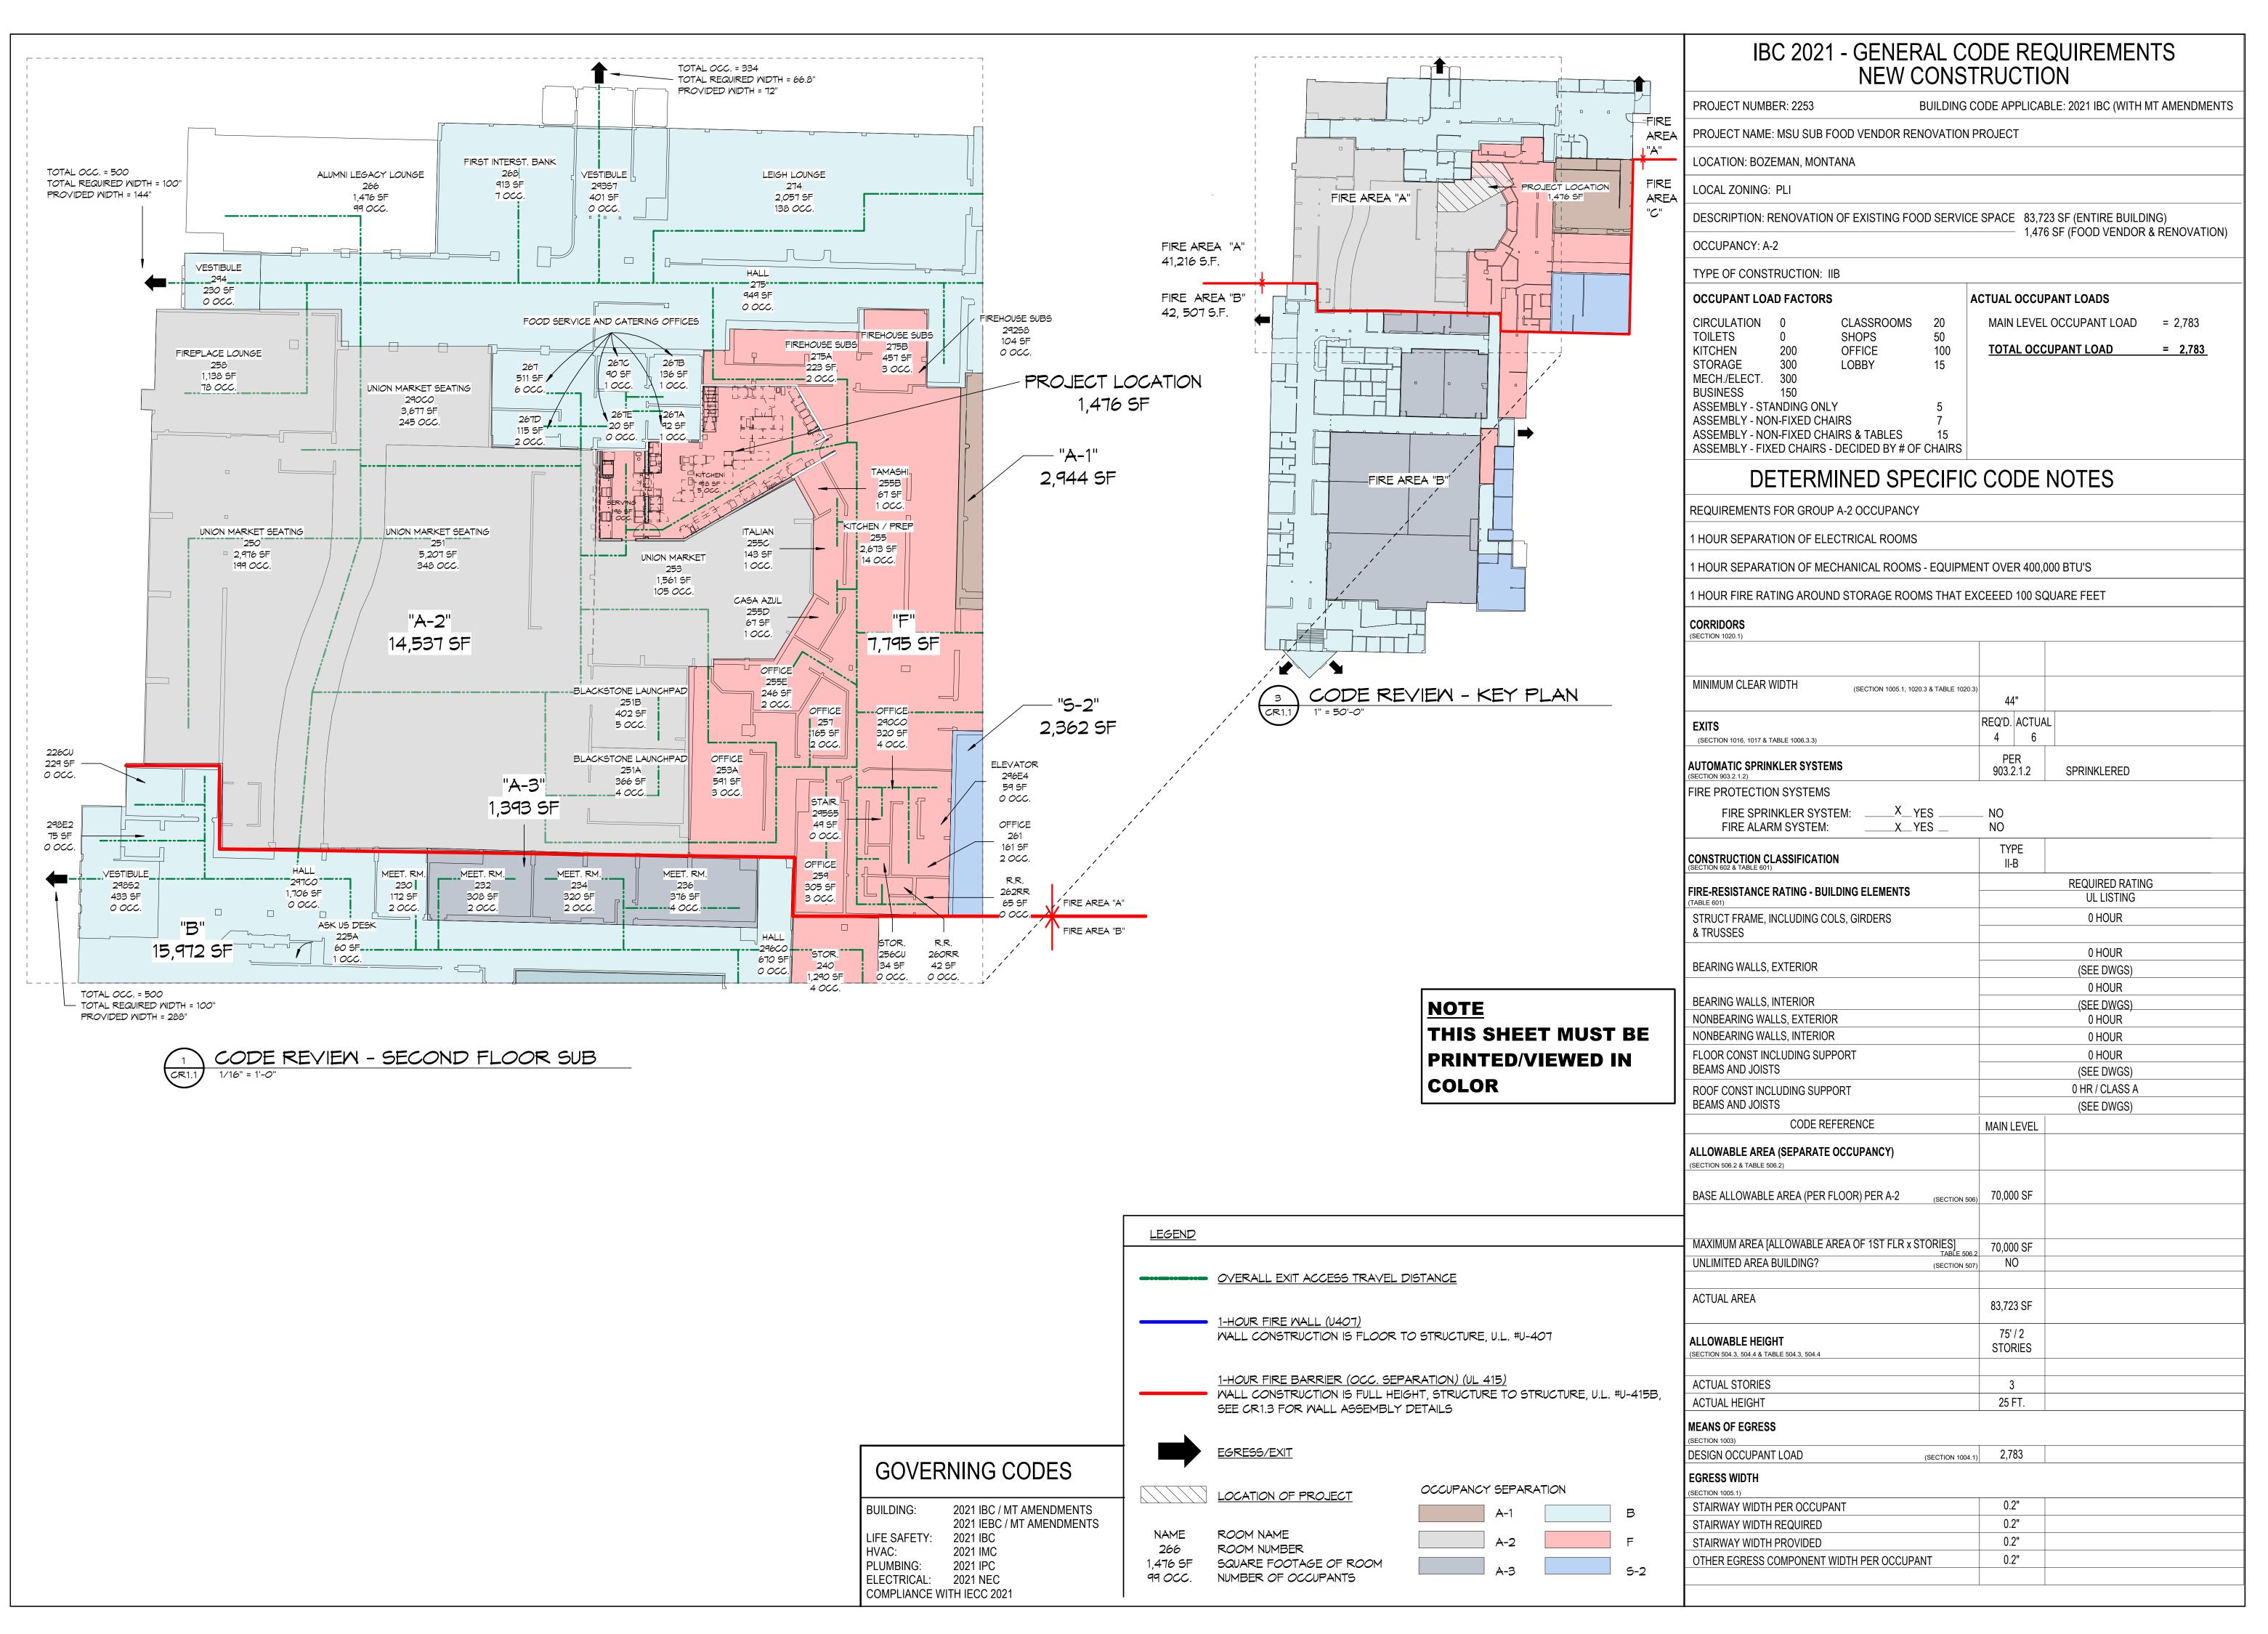




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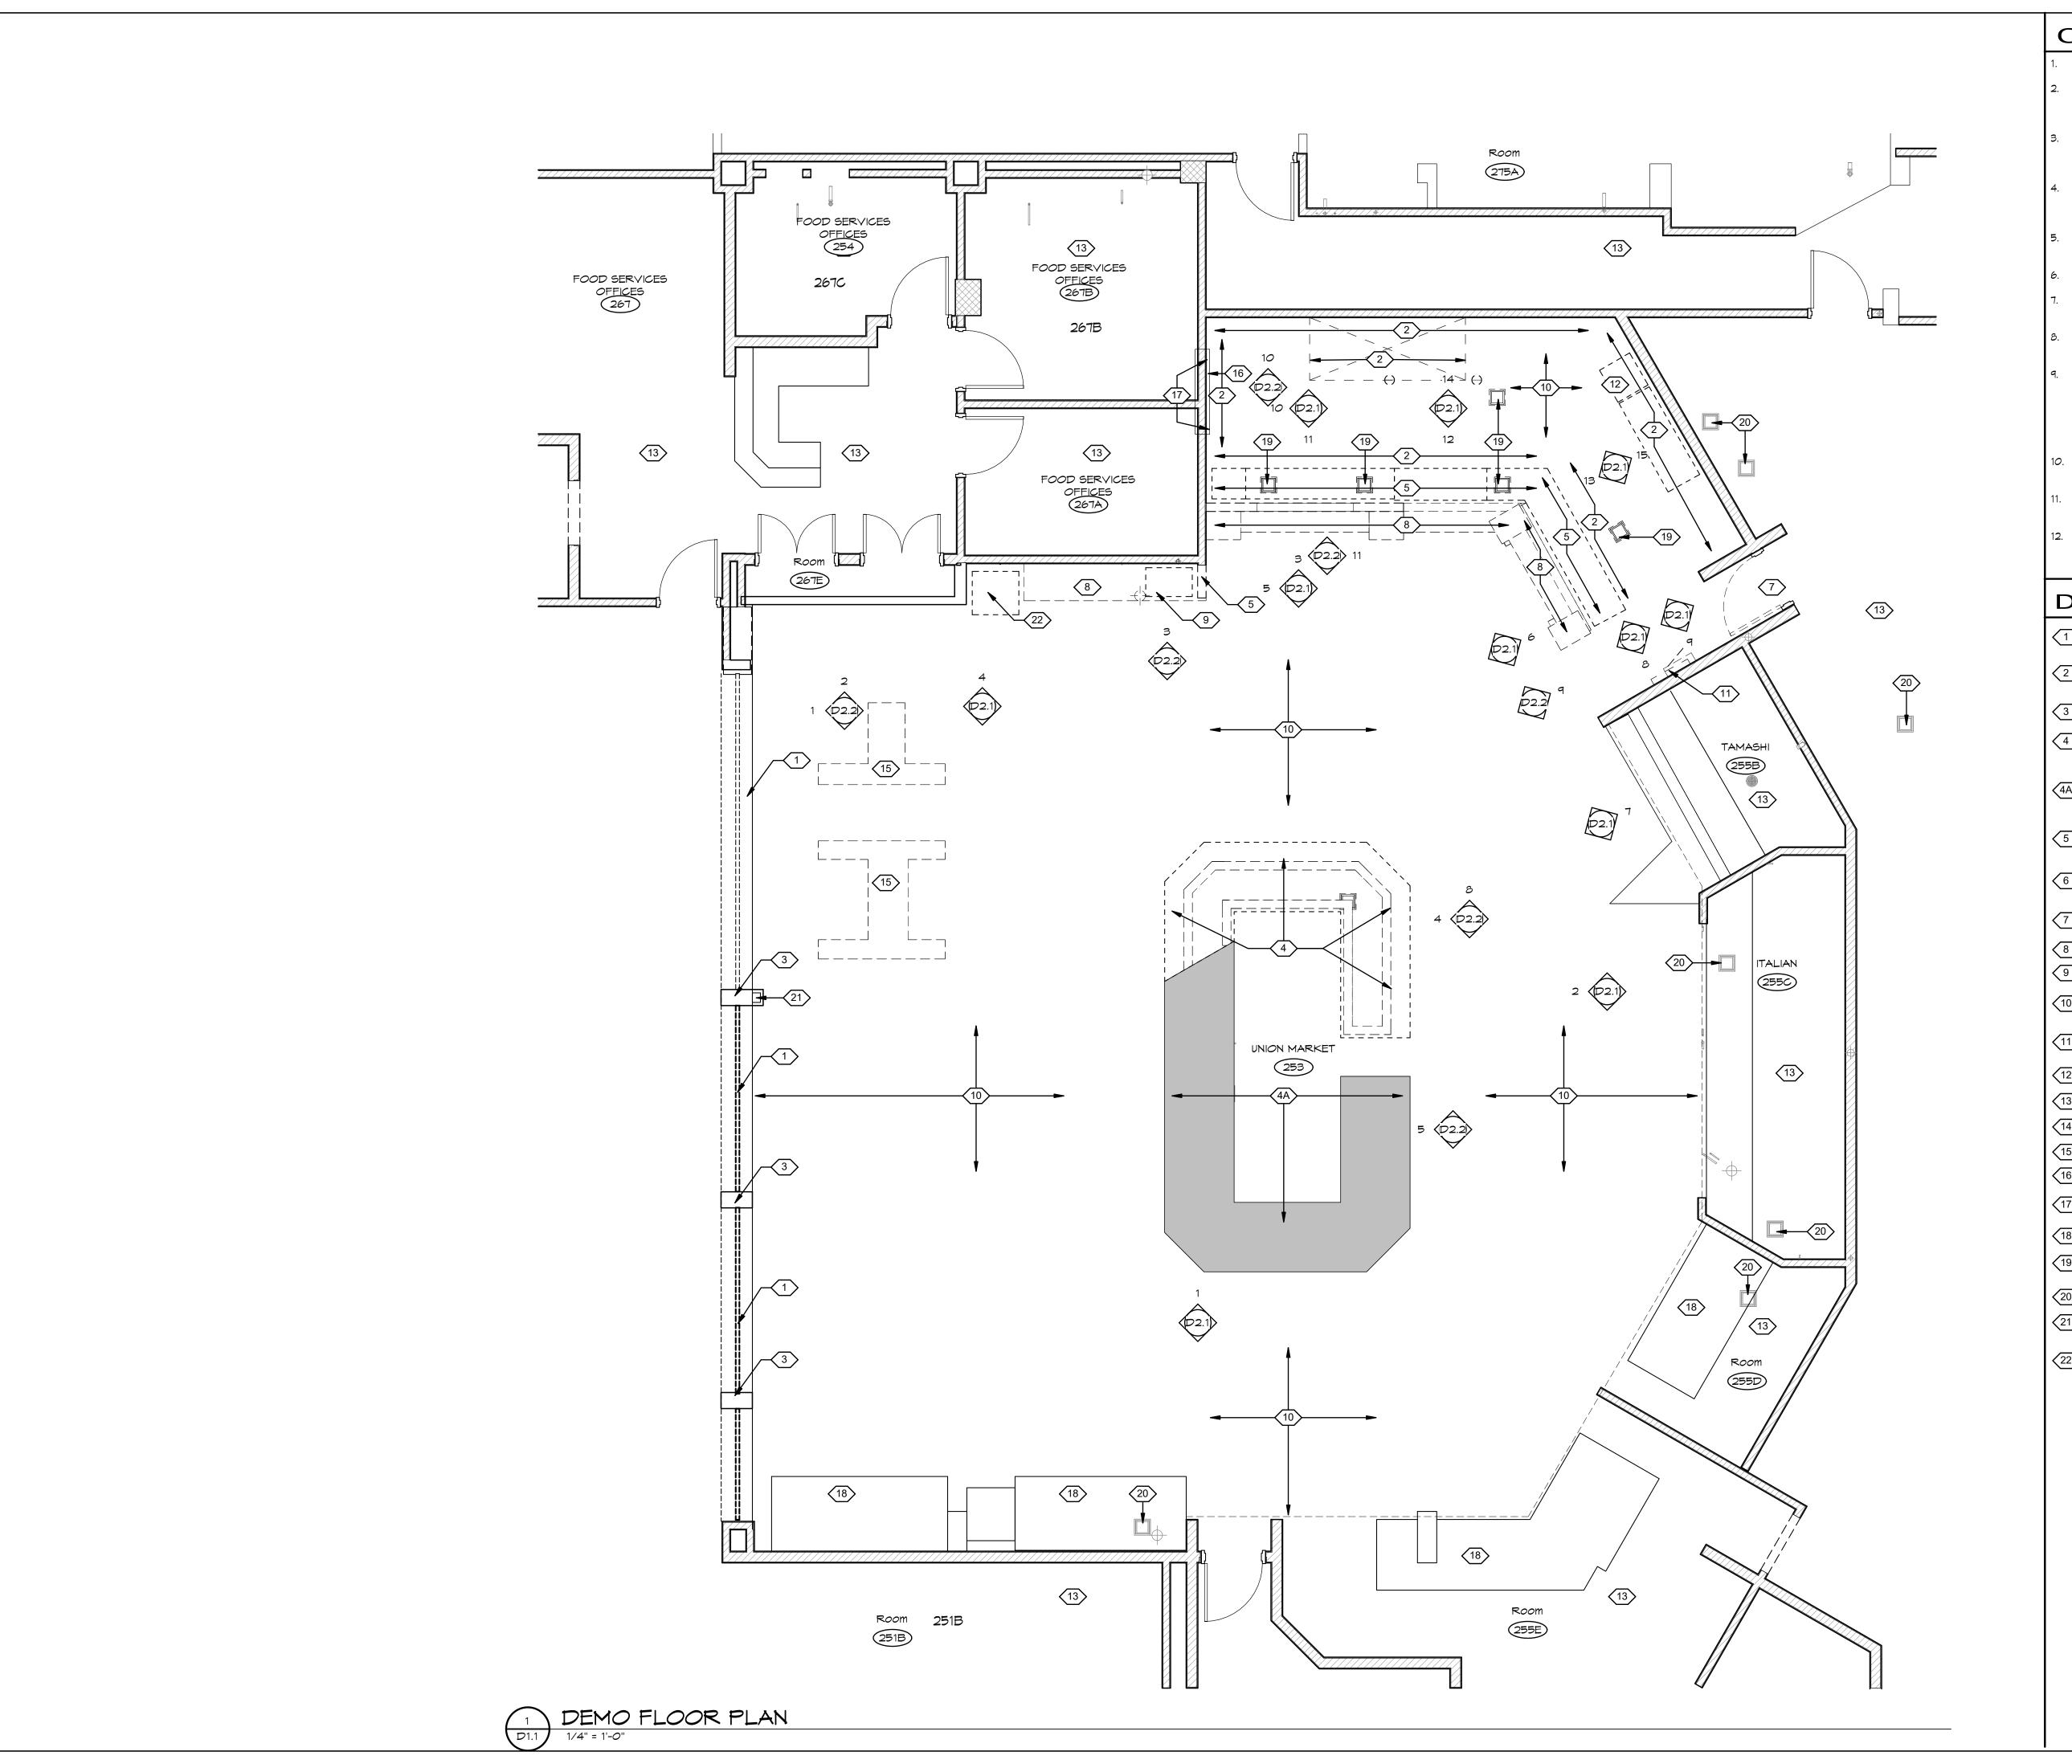


PPA#22-0056 A/E#00-00-00 **Consultant #:**

SHEET TITLE **CODE REVIEW**

PLAN

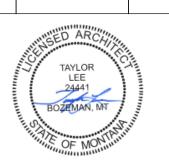SHEET





- ALL DIMENSIONS TO BE FIELD VERIFIED
- REMOVE ALL DEMOLISHED MATERIALS NOT TO BE REUSED FROM THE PROJECT SITE AND DISPOSE OF IT IN A SAFE AND LAWFUL MANNER -
- OWNER RETAINS FIRST RIGHT TO SALVAGEABLE ITEMS REMOVED.

 COORDINATE DEMOLITION WORK WITH ALL NEW WORK TO BE DONE.

 ADDITIONAL DEMOLITION, OTHER THAN THAT SHOWN ON THESE DRAWINGS
- MAY BE REQUIRED FOR COMPLETION OF NEW WORK.

 EXISTING MATERIALS TO REMAIN ARE TO BE PROTECTED DURING CONSTRUCTION. REPAIR ANY MATERIALS TO REMAIN DAMAGED BY CONSTRUCTION ACTIVITIES.
- SEE MECHANICAL AND ELECTRICAL DRAWINGS FOR ADDITIONAL DEMOLITION REQUIREMENTS.
- MOST AREAS OF THE PROJECT RECEIVE NEW CEILINGS
- ALL ABANDONED ELECTRICAL AND MECHANICAL SYSTEMS AND COMPONENTS ARE TO BE REMOVED.
- PATCH ALL HOLES IN FLOORS, WALLS, AND CEILINGS TO MATCH ADJACENT SURFACE FINISH.
- SEPARATE FIRE ALARM, FIRE SPRINKLER, & HOOD SUPPRESSION SYSTEM PLANS / SHOP DRAWINGS SHALL BE DESIGNED & SUBMITTED FOR REVIEW WITHIN 30 DAYS AFTER BUILDING PERMIT HAS BEEN ISSUED. THE DESIGN SHALL MEET 2021 IBC CHAPTER 9 & 2019 NFPA 13/13R, NFPA 72 STANDARDS. THESE ARE TO BE PERMITTED PRIOR TO FRAMING / MEP ROUGH-IN INSPECTIONS.
- O. FIRE SPRINKLER MODIFICATIONS ARE EXPECTED IN THIS PROJECT. SEE G.N. #9 ABOVE FOR DESIGN & SUBMITTAL REQUIREMENTS.
- 1. SEE MECHANICAL & ELECTRICAL DRAWINGS FOR ADDITIONAL M/E/P DEMOLITION SCOPE.
- (E) O.H. SECURITY GRILL WALL MOUNTED HAND CRANK WILL BE REMOVED BY OWNER PRIOR TO CONSTRUCTION

DEMOLITION NOTES



- (E) SECURITY GRILL TO REMAIN, PROTECT FROM DAMAGE.
- (E) KITCHEN EQUIPMENT TO BE REMOVED, COORDINATE WITH M/E/P SUBCONTRACTORS SEE M/E/P DRAWINGS FOR ADDITIONAL DEMO SCOPE
- (E) STRUCTURAL COLUMN TO REMAIN, PROTECT FROM DAMAGE
- PORTION OF (E) SALAD BAR CASEMORK, EQUIPMENT, PLUMBING FIXTURES & ELECTRICAL TO BE REMOVED.
- PORTION OF (E) SALAD BAR CASEWORK, COUNTERTOPS,
 EQUIPMENT, PLUMBING FIXTURES & ELECTRICAL TO REMAIN MAINTAIN UTILITIES TO ALL PLUMBING & ELECTRICAL ITEMS THAT
- (E) WALL TO BE REMOVED, PREP FLOOR FOR NEW FINISH SEE FINISH SCHEDULE ON A2.2
- REMOVE (E) SOFFIT/BULKHEAD, CONFIRM WITH MEP. EXISTING UTILITIES TO REMAIN
- (E) DOOR & FRAME / HARDWARE TO BE REMOVED PREP HEAD &
- 7 JAMB TO RECEIVE NEW DOOR

 8 REMOVE (E) COUTNERTOPS & CASEMORK IN ITS ENTIRETY
- 9 REMOVE (E) BEVERAGE TOWER IN ITS ENTIRETY
- (E) FLOORING TO BE REMOVED PREP FLOOR SLAB WILL
 RECEIVE NEW FLOORING SEE FINISH SCHEDULE ON A2.2
- REPLACE (E) ELECTRICAL WALL MOUNTED PANEL SEE ELECTRICAL DRAWINGS
- 12 REMOVE (E) PLUMBING FIXTURE SEE PLUMBING DRAWINGS
- 13 NO WORK IN THIS ROOM

 14 MOVE OR REPLACE (E) SIGN, REFINISH WALL
- (E) MOVEABLE FURNITURE TO BE REMOVED BY OWNER
- (E) INLIMALL OLD ANGUL SYSTEM EOIDMENT IS TO BE DEMONE
- (E) IN-WALL OLD ANSUL SYSTEM EQIPMENT IS TO BE REMOVED

 REPAIR (E) WALL & FINISH AFTER OLD EQUIP REMOVED WALL

 FINISH TO MATCH ADJACENT WALL SURFACE FINISH
- (E) CASEWORK TO REMAIN PROTECT FROM DAMAGE
- (E) CASEMORK TO REMAIN PROTECT FROM DAMAGE

 (E) FLOOR DRAINS / SINKS TO BE REMOVED PATCH FLOOR & PREP FOR NEW FLOORING
- (E) FLOOR DRAINS / SINKS TO REMAIN PROTECT IN PLACE
- (E) O.H. SECURITY GRILL WALL MOUNTED HAND CRANK TO BE REMOVED BY OWNER PRIOR TO CONSTRUCTION
- (E) VENDING MACHINE TO BE REMOVED BY OWNER



REV. DESCRIPTION DATE

MSU-

MONTANA STATE


UNIVERSITY

BOZEMAN, MONTANA

PHONE: 406.994.5413

DRAWN BY: REVIEWED BY:

TAYLOR
LEE
24441

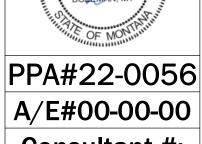

Consultant #:
SHEET TITLE
DEMO FLOOR

PLAN SHEET

D1.1

GENERAL NOTES

ALL DIMENSIONS TO BE FIELD VERIFIED

CONSTRUCTION ACTIVITIES.

- REMOVE ALL DEMOLISHED MATERIALS NOT TO BE REUSED FROM THE PROJECT SITE AND DISPOSE OF IT IN A SAFE AND LAWFUL MANNER -OWNER RETAINS FIRST RIGHT TO SALVAGEABLE ITEMS REMOVED.
- COORDINATE DEMOLITION WORK WITH ALL NEW WORK TO BE DONE. ADDITIONAL DEMOLITION, OTHER THAN THAT SHOWN ON THESE DRAWINGS MAY BE REQUIRED FOR COMPLETION OF NEW WORK.
- EXISTING MATERIALS TO REMAIN ARE TO BE PROTECTED DURING CONSTRUCTION. REPAIR ANY MATERIALS TO REMAIN DAMAGED BY
- SEE MECHANICAL AND ELECTRICAL DRAWINGS FOR ADDITIONAL DEMOLITION REQUIREMENTS.
- MOST AREAS OF THE PROJECT RECEIVE NEW CEILINGS
- ALL ABANDONED ELECTRICAL AND MECHANICAL SYSTEMS AND COMPONENTS ARE TO BE REMOVED.
- PATCH ALL HOLES IN FLOORS, WALLS, AND CEILINGS TO MATCH ADJACENT SURFACE FINISH.
- SEPARATE FIRE ALARM, FIRE SPRINKLER, & HOOD SUPPRESSION SYSTEM PLANS / SHOP DRAWINGS SHALL BE DESIGNED & SUBMITTED FOR REVIEW WITHIN 30 DAYS AFTER BUILDING PERMIT HAS BEEN ISSUED. THE DESIGN SHALL MEET 2021 IBC CHAPTER 9 & 2019 NFPA 13/13R, NFPA 72 STANDARDS. THESE ARE TO BE PERMITTED PRIOR TO FRAMING / MEP
- FIRE SPRINKLER MODIFICATIONS ARE EXPECTED IN THIS PROJECT. SEE G.N. #9 ABOVE FOR DESIGN & SUBMITTAL REQUIREMENTS.
- SEE MECHANICAL & ELECTRICAL DRAWINGS FOR ADDITIONAL M/E/P
- (E) O.H. SECURITY GRILL WALL MOUNTED HAND CRANK WILL BE REMOVED

DEMOLITION NOTES

 $\langle x \rangle$

- 1 (E) SECURITY GRILL TO REMAIN, PROTECT FROM DAMAGE.
- (E) COLUMN TO REMAIN, PROTECT FROM DAMAGE
- 4 (E) STOREFRONT TO REMAIN, PROTECT FROM DAMAGE


- 7 REMOVE (E) DOOR
- 8 REMOVE (E) CASEMORK
- 9 REMOVE (E) BEVERAGE TOWER
- (E) FLOORING & WALL BASE TO BE REMOVED, SEE ROOM FINISH

- 12 REMOVE (E) PLUMBING FIXTURE & ASSOCIATED PLUMBING LINES PROVIDE FLOOR INFILL TO MATCH ADJACENT FLOOR STRUCTURE
- 13 NO WORK IN THIS ROOM

- REMOVE (E) AIR DEVICES SEE MECH. DWGS. FOR ADDITIONAL INFORMATION AND SCOPE
- (E) CEILING TO BE REMOVED, SEE DEMO CEILING PLAN ON SHEET D11.1
- REFINISH WALL SURFACE SEE ROOM FINISH SCHEDULE ON A2.1 & INTERIOR ELEVATIONS ON $\delta.X$ SHEETS

- REMOVE (E) OLD ANSUL HOOD FIRE SUPPRESSION SYSTEM EQUIPMENT IN ENTIRETY SEE MECH. DRAWINGS


- (E) SALAD BAR CASEWORK, EQUIPMENT, PLUMBING FIXTURES & ELECTRICAL TO REMAIN. SEE FLOOR PLANS ON SHEET A1.1
- (E) FIRE SPRINKLER HEADS TO REMAIN SOME MINOR
 ADJUSTMENTS MAY BE REQIRED FOR PROPER PLACEMENT INTO
 NEW CEILING TILE CEILING SEE SHEET A11.1 & MECH. DWGS
- 26 REMOVE (E) STAINLESS STEEL CORNER GUARD
- 27) REMOVE (E) WOOD CHAIR RAIL

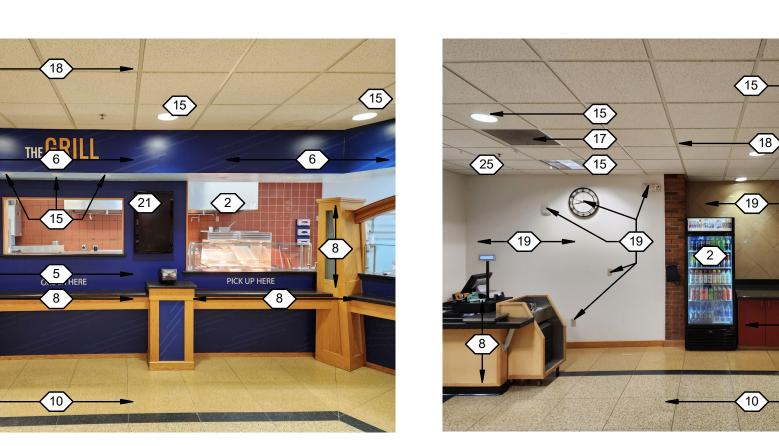




7 ADJACENT FOOD STAND - NORTHEAST



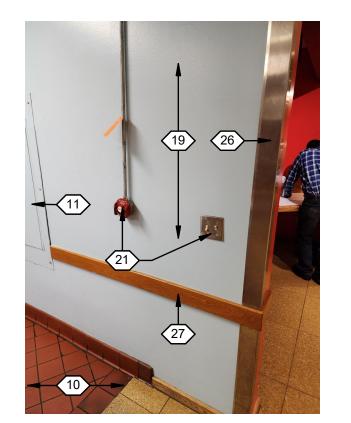



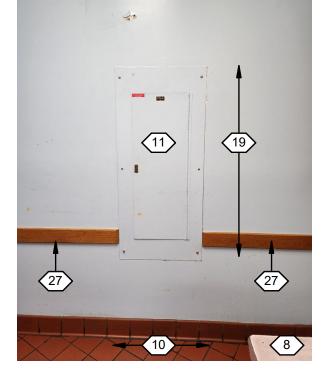

4 SODA STATION - NORTH D2.1 NOT TO SCALE

9 ELECTRICAL PANEL D2.1 NOT TO SCALE





11 THE GRILL - SOUTH D2.1 NOT TO SCALE







THE GRILL - CEILING D2.1 NOT TO SCALE




THE GRILL - NORTH
D2.1) NOT TO SCALE

1 SALAD BAR - NORTH D2.1 NOT TO SCALE

5 THE GRILL - WEST D2.1 NOT TO SCALE



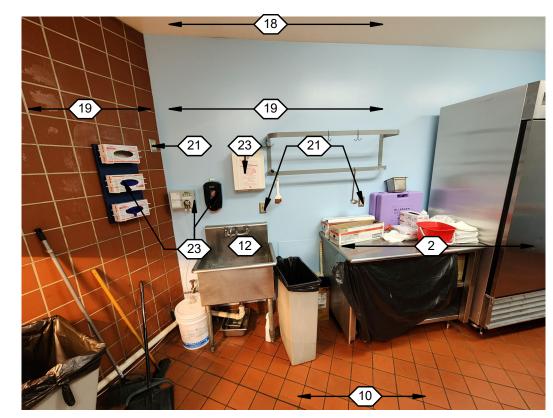



16 THE GRILL - CEILING D2.1 NOT TO SCALE







6 THE GRILL - NORTHEAST



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ROUGH-IN INSPECTIONS.

DEMOLITION SCOPE.

BY OWNER PRIOR TO CONSTRUCTION

- (E) KITCHEN EQUIPMENT TO BE REMOVED, COORDINATE WITH FOOD SERVICE.


- (E) WALL TO BE REMOVED, PREP FLOOR FOR NEW FINISH
- 6 REMOVE (E) SOFFIT/BULKHEAD, COORDINATE WITH M.E.P. EXISTING UTILITIES TO REMAIN

- 11) DEMO PANEL NF & ASSOCIATED FEEDERS SEE ELECTRICAL

- 14 MOVE OR REPLACE (E) SIGN, REFINISH WALL
- REMOVE (E) RECESSED LIGHT FIXTURE SEE ELECT. DWGS. FOR ADDITIONAL INFORMATION AND SCOPE
- REMOVE (E) SURFACE MOUNTED LIGHT FIXTURE SEE ELECT.

 DWGS. FOR ADDITIONAL INFORMATION AND SCOPE

- REMOVE (E) TILE WALL FINISH PREP WALL FOR NEW FINISH SEE INTERIOR ELEVATIONS & SHEET A2.1 FOR FINISH INFORMATION
- REMOVE (E) WALL MOUNTED ELECTRICAL DEVICES SEE ELECTRICAL DWGS
- REMOVE (E) WALL MOUNTED ACCESSORIES & SUPPORTS AS REQUIRED
- (E) SALAD BAR CASEMORK, EQUIPMENT, PLUMBING FIXTURES & ELECTRICAL TO BE REMOVED

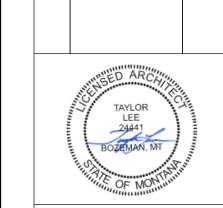

plan one / architects

REV. DESCRIPTION DATE

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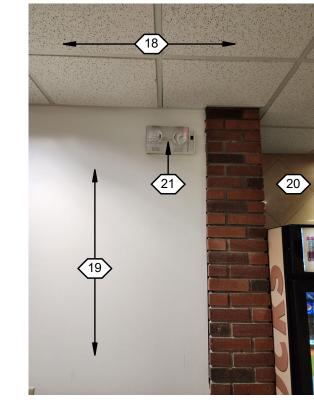
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PPA#22-0056 A/E#00-00-00 **Consultant #:** SHEET TITLE **DEMO PHOTOS**

> SHEET **D2.1**




1 ENTRANCE - WEST D2.2 NOT TO SCALE



2 ENTRANCE - NORTH D2.2 NOT TO SCALE



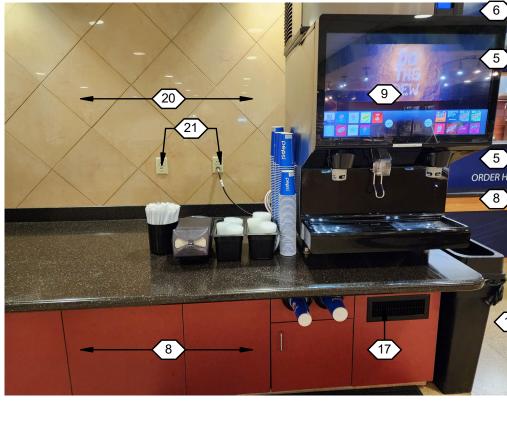


3 SODA STATION - NORTH D2.2 NOT TO SCALE






5 SALAD BAR CEILING - WEST D2.2 NOT TO SCALE

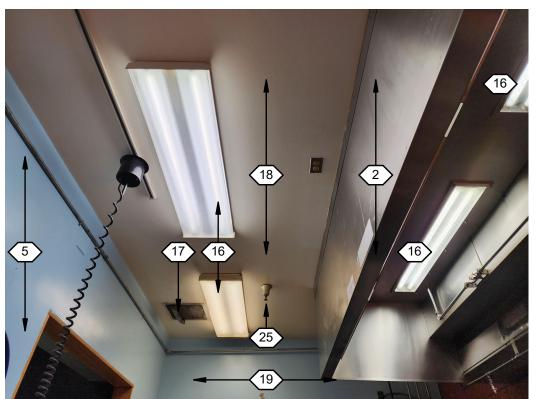






D2.2 NOT TO SCALE

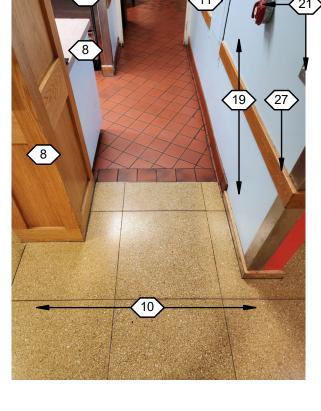

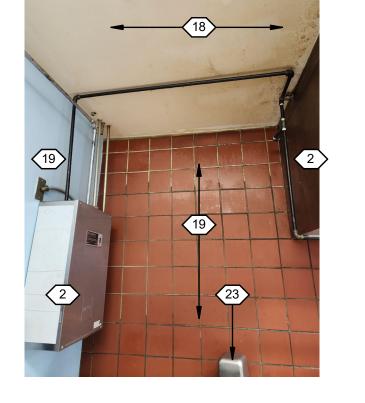


9 FLOORING TRANSITION - NORTHEAST D2.2 NOT TO SCALE


THE GRILL - NORTH
D2.2 NOT TO SCALE



11 THE GRILL - ILLUMINATED COLUMNS
D2.2 NOT TO SCALE



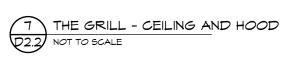

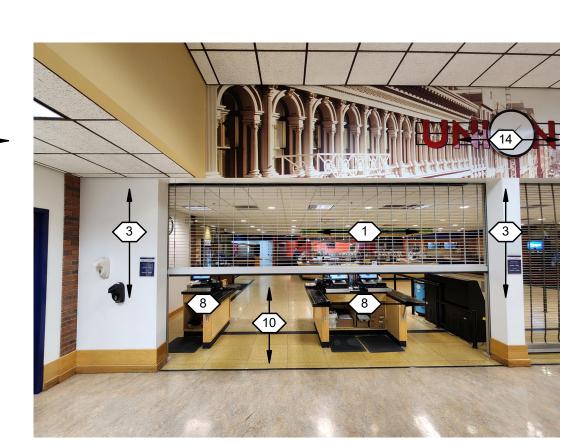

11 SECURITY GRILL - EAST D2.2 NOT TO SCALE

GENERAL NOTES


- ALL DIMENSIONS TO BE FIELD VERIFIED
- REMOVE ALL DEMOLISHED MATERIALS NOT TO BE REUSED FROM THE PROJECT SITE AND DISPOSE OF IT IN A SAFE AND LAWFUL MANNER -OWNER RETAINS FIRST RIGHT TO SALVAGEABLE ITEMS REMOVED.
- COORDINATE DEMOLITION WORK WITH ALL NEW WORK TO BE DONE. ADDITIONAL DEMOLITION, OTHER THAN THAT SHOWN ON THESE DRAWINGS MAY BE REQUIRED FOR COMPLETION OF NEW WORK.
- EXISTING MATERIALS TO REMAIN ARE TO BE PROTECTED DURING CONSTRUCTION. REPAIR ANY MATERIALS TO REMAIN DAMAGED BY CONSTRUCTION ACTIVITIES.
- SEE MECHANICAL AND ELECTRICAL DRAWINGS FOR ADDITIONAL DEMOLITION REQUIREMENTS.
- MOST AREAS OF THE PROJECT RECEIVE NEW CEILINGS
- ALL ABANDONED ELECTRICAL AND MECHANICAL SYSTEMS AND COMPONENTS ARE TO BE REMOVED.
- PATCH ALL HOLES IN FLOORS, WALLS, AND CEILINGS TO MATCH ADJACENT SURFACE FINISH.
- SEPARATE FIRE ALARM, FIRE SPRINKLER, & HOOD SUPPRESSION SYSTEM PLANS / SHOP DRAWINGS SHALL BE DESIGNED & SUBMITTED FOR REVIEW WITHIN 30 DAYS AFTER BUILDING PERMIT HAS BEEN ISSUED. THE DESIGN SHALL MEET 2021 IBC CHAPTER 9 & 2019 NFPA 13/13R, NFPA 72 STANDARDS. THESE ARE TO BE PERMITTED PRIOR TO FRAMING / MEP ROUGH-IN INSPECTIONS.
- FIRE SPRINKLER MODIFICATIONS ARE EXPECTED IN THIS PROJECT. SEE G.N. #9 ABOVE FOR DESIGN & SUBMITTAL REQUIREMENTS.
- SEE MECHANICAL & ELECTRICAL DRAWINGS FOR ADDITIONAL M/E/P DEMOLITION SCOPE.
- (E) O.H. SECURITY GRILL WALL MOUNTED HAND CRANK WILL BE REMOVED BY OWNER PRIOR TO CONSTRUCTION

DEMOLITION NOTES

 $\langle x \rangle$

- \bigcirc (E) SECURITY GRILL TO REMAIN, PROTECT FROM DAMAGE.
- (E) KITCHEN EQUIPMENT TO BE REMOVED, COORDINATE WITH FOOD SERVICE.
- (E) COLUMN TO REMAIN, PROTECT FROM DAMAGE
- (E) STOREFRONT TO REMAIN, PROTECT FROM DAMAGE
- (E) WALL TO BE REMOVED, PREP FLOOR FOR NEW FINISH
- 6 REMOVE (E) SOFFIT/BULKHEAD, COORDINATE WITH M.E.P. EXISTING UTILITIES TO REMAIN
- 7 REMOVE (E) DOOR
- 8 REMOVE (E) CASEMORK
- 9 REMOVE (E) BEVERAGE TOWER
- 10 (E) FLOORING & WALL BASE TO BE REMOVED, SEE ROOM FINISH
- 11) DEMO PANEL NF & ASSOCIATED FEEDERS SEE ELECTRICAL
- 12) REMOVE (E) PLUMBING FIXTURE & ASSOCIATED PLUMBING LINES -PROVIDE FLOOR INFILL TO MATCH ADJACENT FLOOR STRUCTURE
- $\overline{13}$ NO WORK IN THIS ROOM
- 14 MOVE OR REPLACE (E) SIGN, REFINISH WALL
- REMOVE (E) RECESSED LIGHT FIXTURE SEE ELECT. DWGS. FOR ADDITIONAL INFORMATION AND SCOPE
- REMOVE (E) SURFACE MOUNTED LIGHT FIXTURE SEE ELECT. 16) DMGS. FOR ADDITIONAL INFORMATION AND SCOPE
- REMOVE (E) AIR DEVICES SEE MECH. DWGS. FOR ADDITIONAL INFORMATION AND SCOPE
- (E) CEILING TO BE REMOVED, SEE DEMO CEILING PLAN ON SHEET D11.1
- REFINISH WALL SURFACE SEE ROOM FINISH SCHEDULE ON A2.1 & INTERIOR ELEVATIONS ON 8.X SHEETS
- REMOVE (E) TILE WALL FINISH PREP WALL FOR NEW FINISH SEE INTERIOR ELEVATIONS & SHEET A2.1 FOR FINISH INFORMATION
- REMOVE (E) WALL MOUNTED ELECTRICAL DEVICES SEE ELECTRICAL DWGS
- REMOVE (E) OLD ANSUL HOOD FIRE SUPPRESSION SYSTEM EQUIPMENT IN ENTIRETY SEE MECH. DRAWINGS
- REMOVE (E) WALL MOUNTED ACCESSORIES & SUPPORTS AS REQUIRED
- (E) SALAD BAR CASEMORK, EQUIPMENT, PLUMBING FIXTURES & ELECTRICAL TO BE REMOVED
- (E) SALAD BAR CASEMORK, EQUIPMENT, PLUMBING FIXTURES & ELECTRICAL TO REMAIN. SEE FLOOR PLANS ON SHEET A1.1
- (E) FIRE SPRINKLER HEADS TO REMAIN SOME MINOR

 ADJUSTMENTS MAY BE REQIRED FOR PROPER PLACEMENT INTO NEW CEILING TILE CEILING - SEE SHEET A11.1 & MECH. DWGS
- 26 REMOVE (E) STAINLESS STEEL CORNER GUARD
- 27) REMOVE (E) WOOD CHAIR RAIL

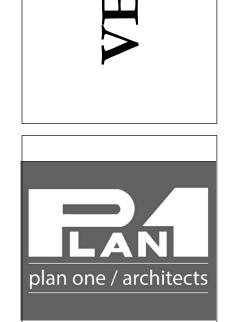

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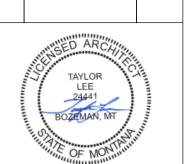
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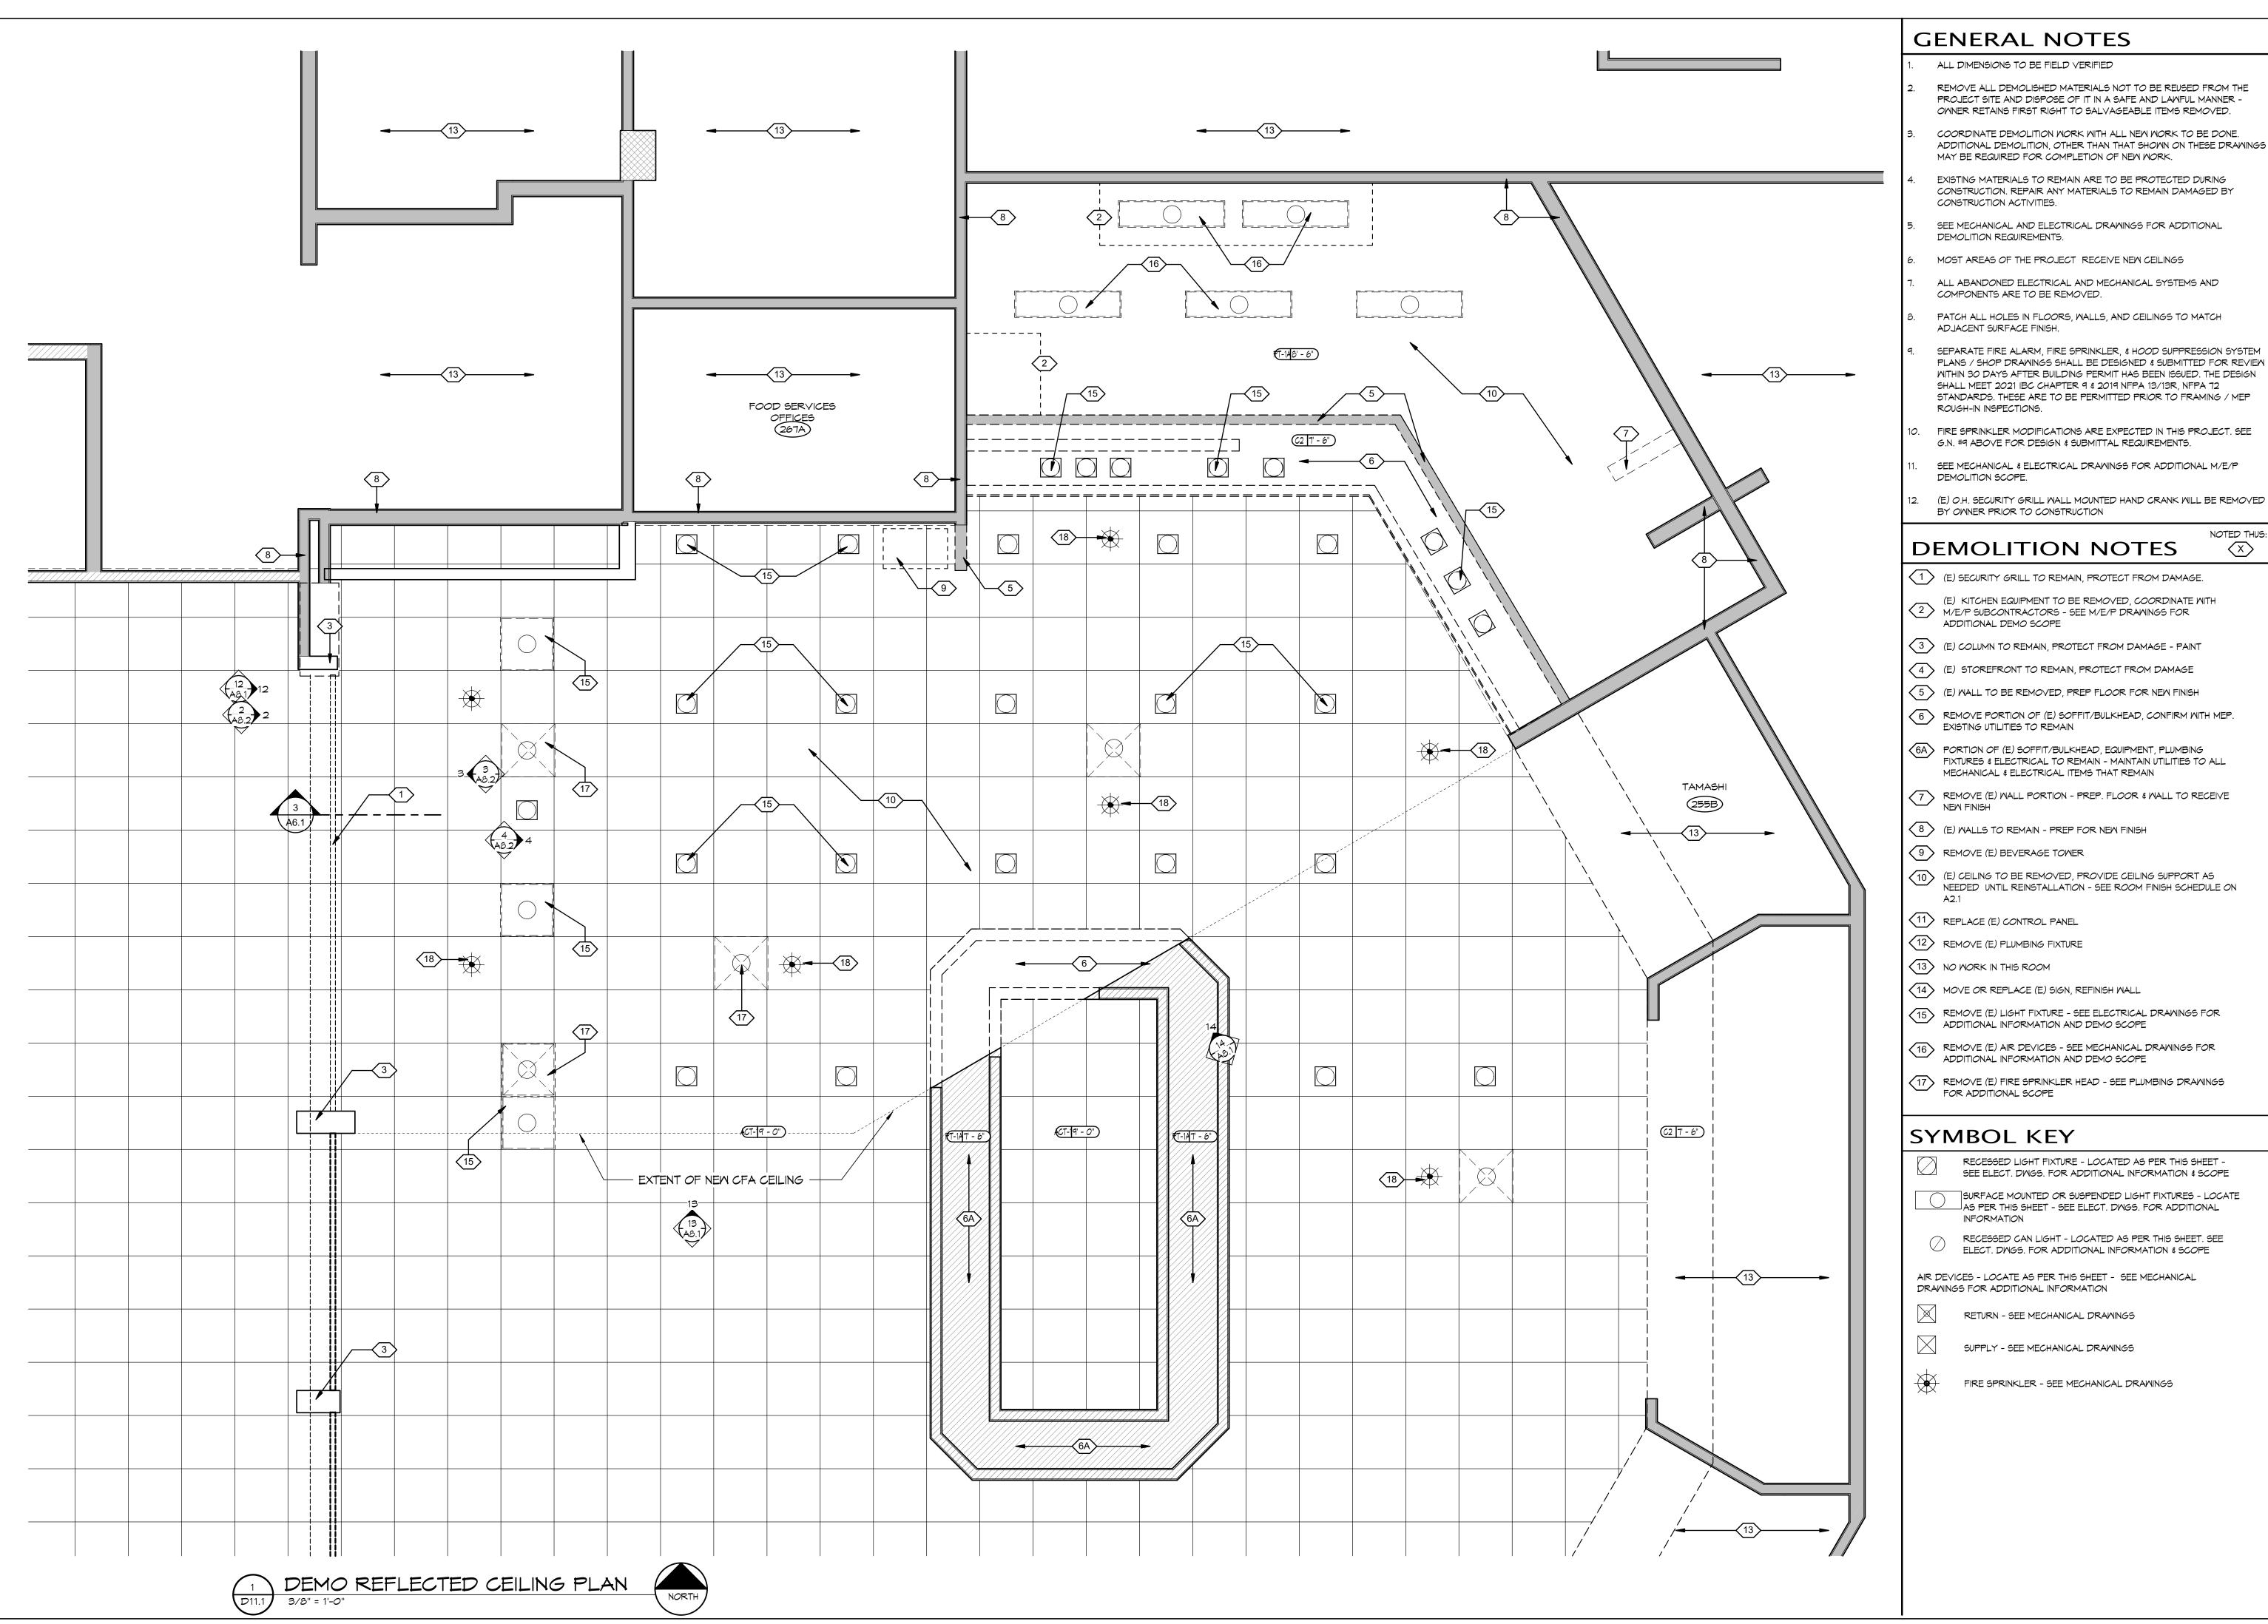
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PPA#22-0056 A/E#00-00-00 **Consultant #:**

SHEET TITLE **DEMO PHOTOS**

SHEET





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SEPARATE FIRE ALARM, FIRE SPRINKLER, & HOOD SUPPRESSION SYSTEM PLANS / SHOP DRAWINGS SHALL BE DESIGNED & SUBMITTED FOR REVIEW WITHIN 30 DAYS AFTER BUILDING PERMIT HAS BEEN ISSUED. THE DESIGN SHALL MEET 2021 IBC CHAPTER 9 & 2019 NFPA 13/13R, NFPA 72 STANDARDS. THESE ARE TO BE PERMITTED PRIOR TO FRAMING / MEP

G.N. #9 ABOVE FOR DESIGN & SUBMITTAL REQUIREMENTS.

(E) O.H. SECURITY GRILL WALL MOUNTED HAND CRANK WILL BE REMOVED BY OWNER PRIOR TO CONSTRUCTION

NOTED THUS

 $\langle X \rangle$

DEMOLITION NOTES

1 (E) SECURITY GRILL TO REMAIN, PROTECT FROM DAMAGE.

(E) KITCHEN EQUIPMENT TO BE REMOVED, COORDINATE WITH M/E/P SUBCONTRACTORS - SEE M/E/P DRAWINGS FOR

(E) COLUMN TO REMAIN, PROTECT FROM DAMAGE - PAINT

(E) STOREFRONT TO REMAIN, PROTECT FROM DAMAGE

(5) (E) WALL TO BE REMOVED, PREP FLOOR FOR NEW FINISH

6 REMOVE PORTION OF (E) SOFFIT/BULKHEAD, CONFIRM WITH MEP.

6A) PORTION OF (E) SOFFIT/BULKHEAD, EQUIPMENT, PLUMBING FIXTURES & ELECTRICAL TO REMAIN - MAINTAIN UTILITIES TO ALL

7 REMOVE (E) WALL PORTION - PREP. FLOOR & WALL TO RECEIVE

(E) CEILING TO BE REMOVED, PROVIDE CEILING SUPPORT AS NEEDED UNTIL REINSTALLATION - SEE ROOM FINISH SCHEDULE ON

ADDITIONAL INFORMATION AND DEMO SCOPE

RECESSED LIGHT FIXTURE - LOCATED AS PER THIS SHEET -

SURFACE MOUNTED OR SUSPENDED LIGHT FIXTURES - LOCATE \sqcup AS PER THIS SHEET - SEE ELECT. DWGS. FOR ADDITIONAL


RECESSED CAN LIGHT - LOCATED AS PER THIS SHEET. SEE

FIRE SPRINKLER - SEE MECHANICAL DRAWINGS



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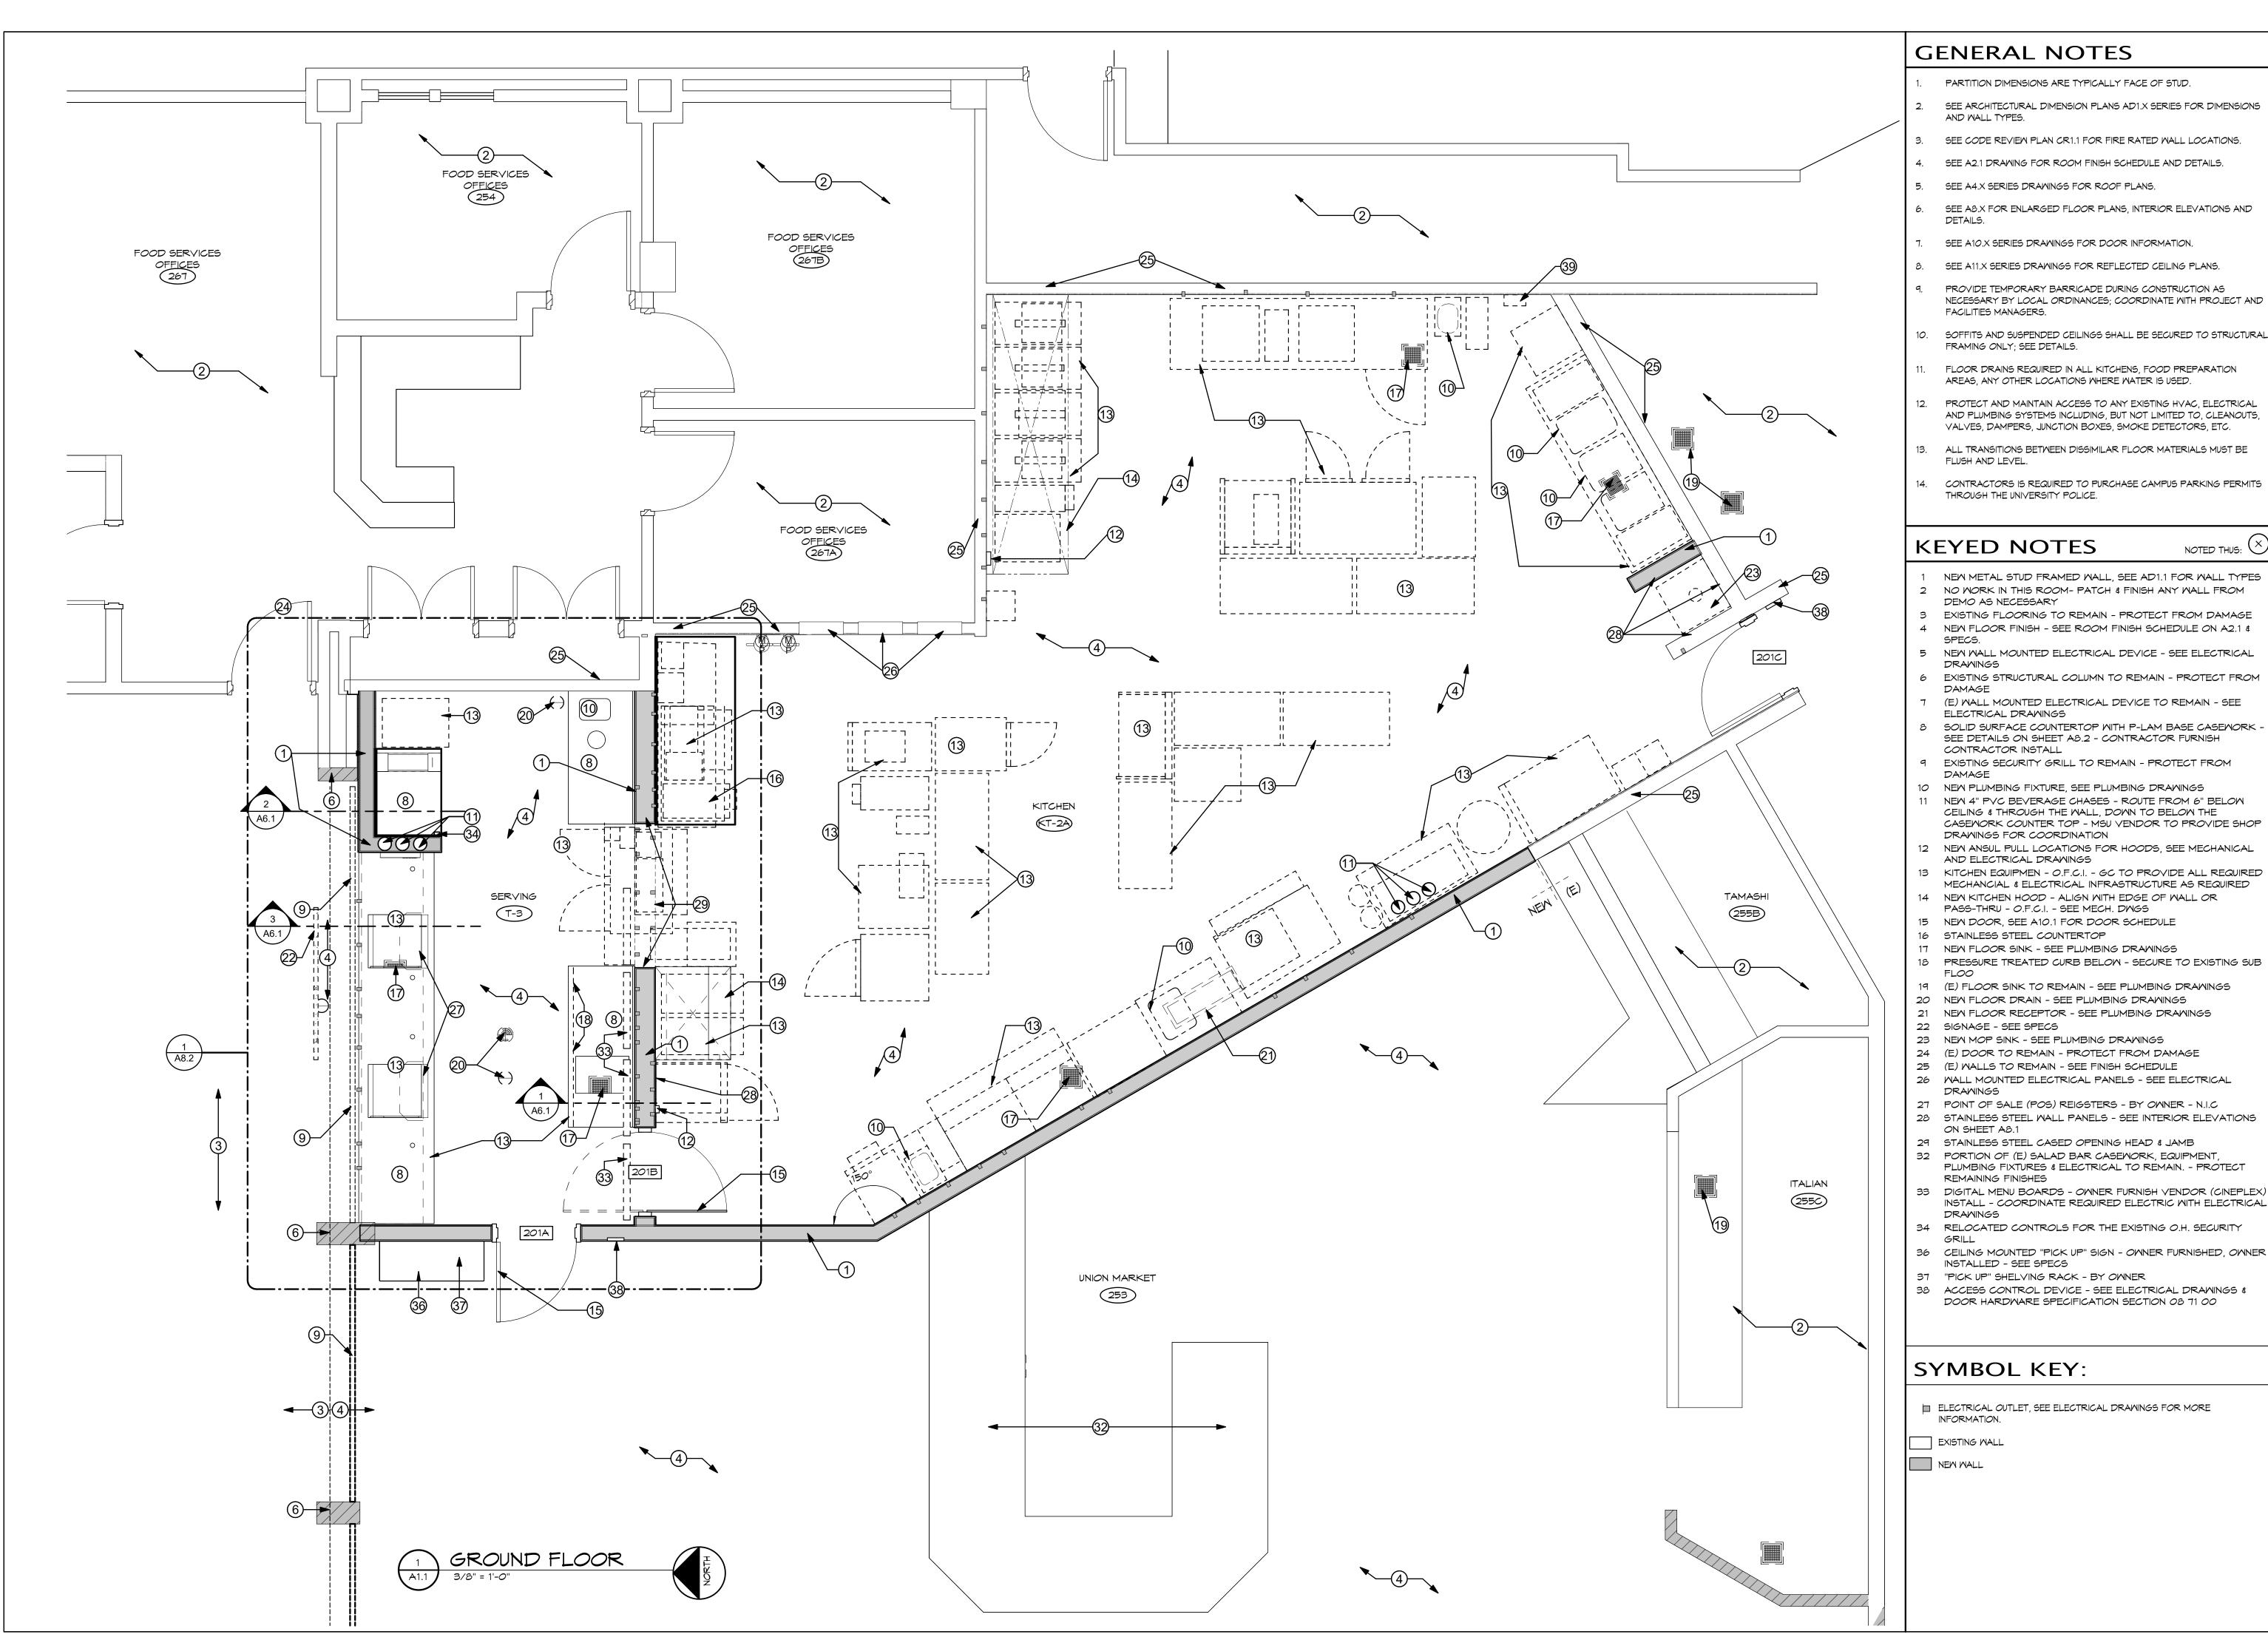


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SHEET TITLE **DEMO REF.**

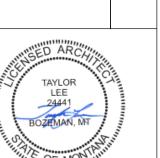CEILING PLAN

SHEET



GENERAL NOTES

- PARTITION DIMENSIONS ARE TYPICALLY FACE OF STUD.
- SEE ARCHITECTURAL DIMENSION PLANS AD1.X SERIES FOR DIMENSIONS AND WALL TYPES.
- SEE CODE REVIEW PLAN CR1.1 FOR FIRE RATED WALL LOCATIONS.
- SEE A2.1 DRAWING FOR ROOM FINISH SCHEDULE AND DETAILS.
- SEE A4.X SERIES DRAWINGS FOR ROOF PLANS.
- SEE A8.X FOR ENLARGED FLOOR PLANS, INTERIOR ELEVATIONS AND DETAILS.
- SEE A10.X SERIES DRAWINGS FOR DOOR INFORMATION.
- SEE A11.X SERIES DRAWINGS FOR REFLECTED CEILING PLANS.
- PROVIDE TEMPORARY BARRICADE DURING CONSTRUCTION AS NECESSARY BY LOCAL ORDINANCES; COORDINATE WITH PROJECT AND FACILITIES MANAGERS.
- SOFFITS AND SUSPENDED CEILINGS SHALL BE SECURED TO STRUCTURAL FRAMING ONLY; SEE DETAILS.
- FLOOR DRAINS REQUIRED IN ALL KITCHENS, FOOD PREPARATION AREAS, ANY OTHER LOCATIONS WHERE WATER IS USED.
- 12. PROTECT AND MAINTAIN ACCESS TO ANY EXISTING HVAC, ELECTRICAL AND PLUMBING SYSTEMS INCLUDING, BUT NOT LIMITED TO, CLEANOUTS, VALVES, DAMPERS, JUNCTION BOXES, SMOKE DETECTORS, ETC.
- 13. ALL TRANSITIONS BETWEEN DISSIMILAR FLOOR MATERIALS MUST BE FLUSH AND LEVEL.
- 14. CONTRACTORS IS REQUIRED TO PURCHASE CAMPUS PARKING PERMITS THROUGH THE UNIVERSITY POLICE.

KEYED NOTES

NOTED THUS: (X

- NEW METAL STUD FRAMED WALL, SEE AD1.1 FOR WALL TYPES 2 NO WORK IN THIS ROOM- PATCH & FINISH ANY WALL FROM DEMO AS NECESSARY
- 3 EXISTING FLOORING TO REMAIN PROTECT FROM DAMAGE 4 NEW FLOOR FINISH - SEE ROOM FINISH SCHEDULE ON A2.1 &
- 5 NEW WALL MOUNTED ELECTRICAL DEVICE SEE ELECTRICAL DRAWINGS
- 6 EXISTING STRUCTURAL COLUMN TO REMAIN PROTECT FROM
- 7 (E) WALL MOUNTED ELECTRICAL DEVICE TO REMAIN SEE ELECTRICAL DRAWINGS
- 8 SOLID SURFACE COUNTERTOP WITH P-LAM BASE CASEMORK -SEE DETAILS ON SHEET A8.2 - CONTRACTOR FURNISH CONTRACTOR INSTALL
- 9 EXISTING SECURITY GRILL TO REMAIN PROTECT FROM DAMAGE
- 10 NEW PLUMBING FIXTURE, SEE PLUMBING DRAWINGS 11 NEW 4" PVC BEVERAGE CHASES - ROUTE FROM 6" BELOW CEILING & THROUGH THE WALL, DOWN TO BELOW THE CASEMORK COUNTER TOP - MSU VENDOR TO PROVIDE SHOP
- DRAWINGS FOR COORDINATION 12 NEW ANSUL PULL LOCATIONS FOR HOODS, SEE MECHANICAL
- AND ELECTRICAL DRAWINGS 13 KITCHEN EQUIPMEN - O.F.C.I. - GC TO PROVIDE ALL REQUIRED
- MECHANCIAL & ELECTRICAL INFRASTRUCTURE AS REQUIRED 14 NEW KITCHEN HOOD - ALIGN WITH EDGE OF WALL OR
- PASS-THRU O.F.C.I. SEE MECH. DWGS
- 15 NEW DOOR, SEE A10.1 FOR DOOR SCHEDULE
- 16 STAINLESS STEEL COUNTERTOP
- 17 NEW FLOOR SINK SEE PLUMBING DRAWINGS 18 PRESSURE TREATED CURB BELOW - SECURE TO EXISTING SUB
- 19 (E) FLOOR SINK TO REMAIN SEE PLUMBING DRAWINGS
- 20 NEW FLOOR DRAIN SEE PLUMBING DRAWINGS
- 21 NEW FLOOR RECEPTOR SEE PLUMBING DRAWINGS
- 22 SIGNAGE SEE SPECS
- 23 NEW MOP SINK SEE PLUMBING DRAWINGS 24 (E) DOOR TO REMAIN - PROTECT FROM DAMAGE
- 25 (E) WALLS TO REMAIN SEE FINISH SCHEDULE
- 26 WALL MOUNTED ELECTRICAL PANELS SEE ELECTRICAL DRAWINGS 27 POINT OF SALE (POS) REIGSTERS - BY OWNER - N.I.C
- 28 STAINLESS STEEL WALL PANELS SEE INTERIOR ELEVATIONS ON SHEET A8.1 29 STAINLESS STEEL CASED OPENING HEAD & JAMB
- 32 PORTION OF (E) SALAD BAR CASEMORK, EQUIPMENT, PLUMBING FIXTURES & ELECTRICAL TO REMAIN. - PROTECT REMAINING FINISHES
- INSTALL COORDINATE REQUIRED ELECTRIC WITH ELECTRICAL DRAWINGS 34 RELOCATED CONTROLS FOR THE EXISTING O.H. SECURITY
- 36 CEILING MOUNTED "PICK UP" SIGN OWNER FURNISHED, OWNER
- INSTALLED SEE SPECS
- 37 "PICK UP" SHELVING RACK BY OWNER
- 38 ACCESS CONTROL DEVICE SEE ELECTRICAL DRAWINGS & DOOR HARDWARE SPECIFICATION SECTION 08 71 00

SYMBOL KEY:

- ☐ ELECTRICAL OUTLET, SEE ELECTRICAL DRAWINGS FOR MORE
- INFORMATION.
- EXISTING WALL



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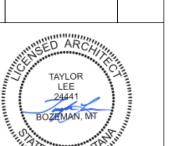
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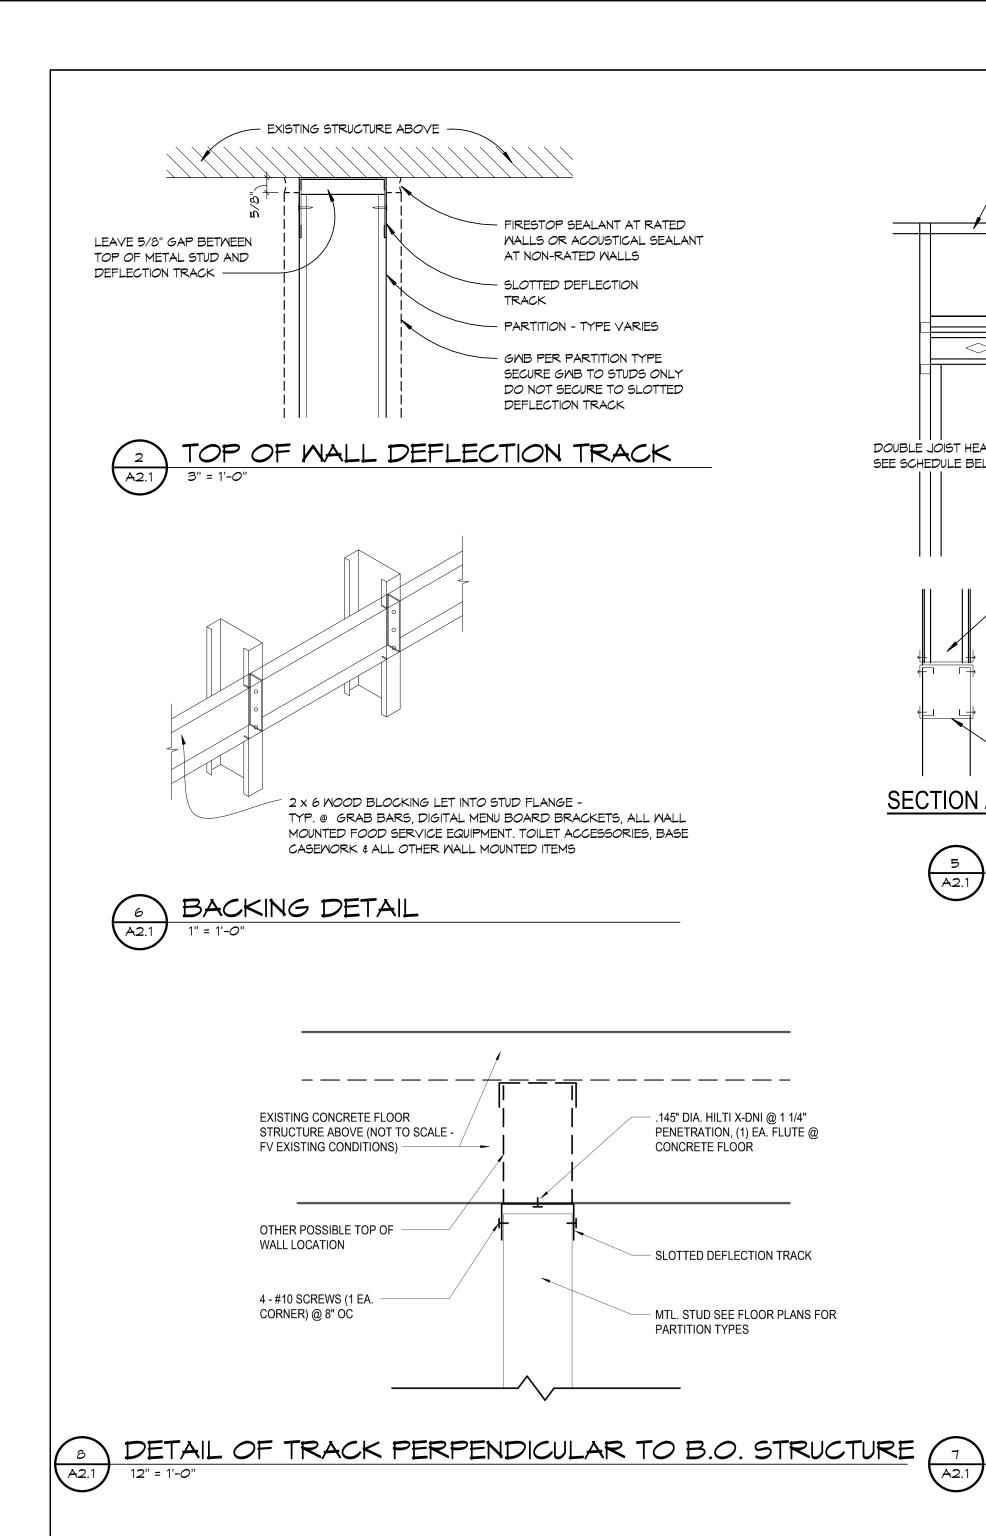
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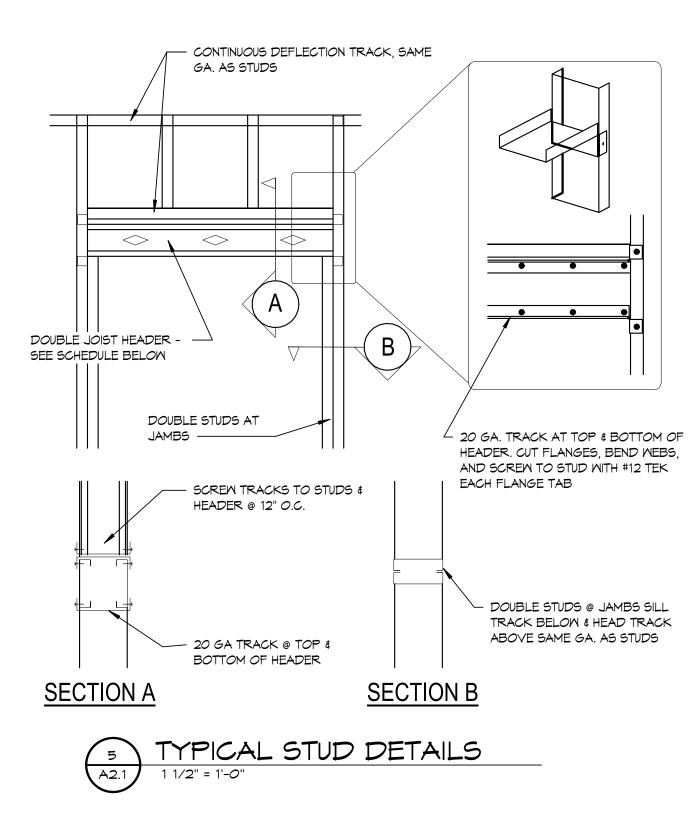


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SHEET TITLE **OVERALL FLOOR**

> **PLAN** SHEET





6 MIL. FIRE RETARDANT PVC CLOSURE


BETWEEN THE FLOOR AND CEILING OR

W/ DUCT TAPE TO EXISTING STRUCTURE,

CEILING PENETRATIONS, ETC.

STRUCTURE ABOVE. SECURE AND SEAL TIGHT

DUST PARTITION - PROTECTION

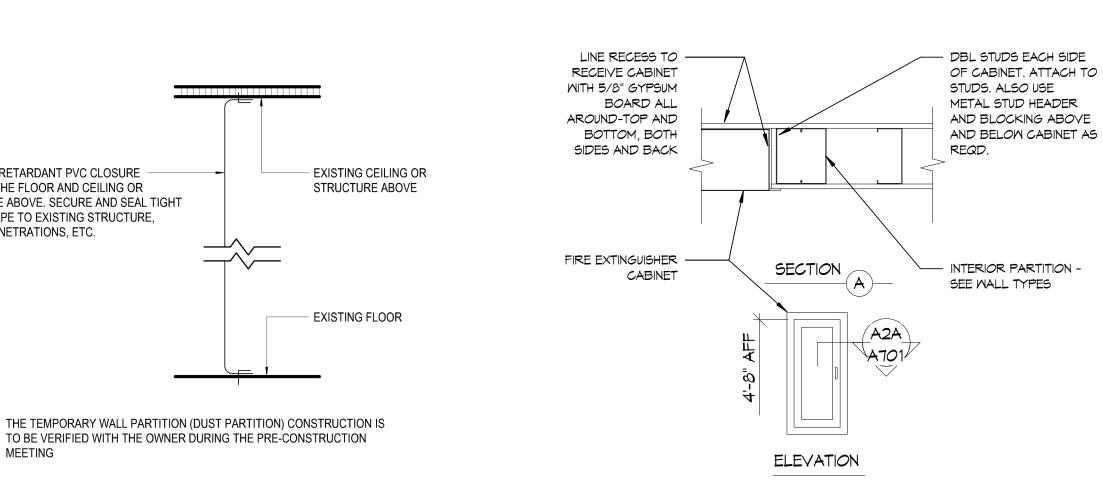

METAL STUDS @ 16" O.C. W/

STEEL COLUMN WHERE

OCCURS - SEE STRUCTURAL

VERTICAL OR HORIZONTAL

DRYMALL CONTROL JOINT

PROVIDE GYP. BOARD CONTROL

JOINTS AT ALL STRAIGHT WALLS


JOINTS WITH ADDITIONAL WALL

OVER 30'-0" LONG. - COORDINATE

"V" GROOVE

5/8" TYPE 'X' GYP. BD

FULL FIBERGLASS INSULATION

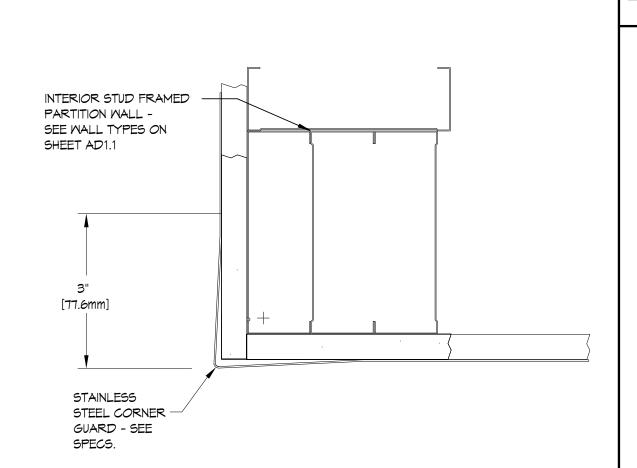

FIRE EXTINGUISHER & CABINET



		MAI	N FLO	OR ROOM	1 FINISH SC	HEDULE			
ROOM #	ROOM NAME	FLOOR	BASE	NORTH	EAST	SOUTH	MEST	CEILING	REMARKS
KT-2A	KITCHEN	KT-2A	KT-2	5-1/FR	5-1/FRP-2	FRP-2	S-1/FRP-2	ACT-1	
			В	P-2					
T-3	SERVING	T-3	T-4	T-1A	T-2/MD-1	T-1A	T-1A	ACT-1/	
								PT-1A	

GENERAL WALL & FINISH NOTES

- PROVIDE IN-WALL BLOCKING/BACKING AND 16 GAUGE STUDS FOR WALL MOUNTED ITEMS SEE DETAIL 6/A2.1.
- PROVIDE CASING BEAD & CAULK WHERE G.W.B. BUTTS AGAINST DISSIMILAR MATERIAL. ADDITIONAL FRAMING AND BLOCKING IS REQUIRED FOR THE INSTALLATION OF VARIOUS MECHANICAL, & ELECTRICAL ITEMS,
- PROVIDE DESIGNATED BASE AROUND BOTTOM OF CABINETS, UNLESS NOTED OTHERWISE.
- SEE A11.1 SERIES FOR REFLECTED CEILING PLANS, CEILING TYPES, AND SPECIAL CEILING FEATURES.
- SEE A8.X SERIES FOR ENLARGED FLOOR PLANS AND INTERIOR ELEVATIONS. PROVIDE FLOOR FILLER AS REQUIRED TO PREPARE SLABS FOR SCHEDULED FINISH FLOORING.
- BRACE ALL SOFFIT WALLS WITH 4" METAL STUDS, 45 DEGREE DIAGONAL TO STRUCTURE @ 48" O.C. MAX (ALT. DIRECTIONS).
- PROVIDE MOISTURE RESISTANT G.W.B. @ ALL WET AREAS. PROVIDE BACKER BOARD BEHIND ALL TILE WALL FINISHES - DELETE G.W.B.
- PROVIDE FLOORING TRANSITIONS BENEATH CENTER OF DOOR IN CLOSED POSITION AND AT ALL FLOOR TRANSITION LOCATIONS. SEE INTERIOR ELEVATIONS FOR LOCATIONS OF WALL TILE.
- FIRE SEAL ALL PENETRATIONS THROUGH NEW/EXISTING FIRE RATED WALLS, SEE SPECIFICATION SECTION 07 84 13. AT ACOUSTIC PARTITIONS (THOSE WITH SOUND BATTS) APPLY ACOUSTIC SEALANT AT ALL PENETRATIONS AND SET WALL G.W.B. IN SEALANT AT FLOOR/WALL & STRUCTURE JUNCTION.
- 14. ALL INTERIOR PARTITIONS GO FULL HEIGHT TO BOTTOM OF STRUCTURE, SEE TYPICAL PARTITION DETAIL 2\$8/A2.1. 15. ALL OPENINGS IN PARTITIONS (DOORS, WINDOWS, DUCTS, GRILLES, ETC.) ARE TO RECEIVE BOXED HEADERS PER DETAIL 5/A2.1 &
- PROVIDE BOXED HEADERS AND FULL PERIMETER FRAMING FOR MECHANICAL GRILLES IN WALLS, SEE MECHANICAL DRAWINGS
- FOR LOCATIONS, SEE DETAIL 5/A2.1.
- PROVIDE IN-WALL BLOCKING/BACKING AND 16 GUAGE STUDS FOR WALL MOUNTED ITEMS SEE DETAIL 6/A2.1
- ALL CASEMORK TO RECEIVE THE SAME WALL BASE MATERIAL AS SCHEDULED FOR ROOM. ALL EXPOSED CONDUIT AND PIPE TO BE PAINTED TO MATCH ADJACENT WALL OR CEILING SURFACE.
- 20. ALL EXPOSED STRUCTURE AND WALL SURFACES ARE TO BE CLEANED AND PREPPED PRIOR TO RECEIVING NEW FINISH.
- PROVIDE SLOPE IN SLAB (2%) MAX (WHERE POSSIBLE) TO FLOOR DRAINS. START WOOD INSTALLATION AT BOTTOM OF SOFFIT OR TOP OF BASE TILE AS APPLICABLE.
- TILE SETTING METHODS TO BE PER THE LATEST PRINTED EDITION OF "HANDBOOK FOR CERAMIC TILE INSTALLATION" AS PUBLISHED BY THE TILE COUNCIL OF AMERICA, INC.
- START TILE INSTALLATION AT TOP OF BASE TILE. WHERE BASE TILE IS UNDER MILLWORK OR HAS TILE INSTALLED ABOVE; BULLNOSE IS TO BE REMOVED SO THAT TILE CAN BE
- INSTALLED WITH TOP OF CUT TILE AT 5 1/2" ABOVE FINISHED CONCRETE SLAB. TILE TO EXTEND BEHIND MILLWORK. INSTALL TILE (T-6) PRIOR TO ANY ADJACENT TILE
- GENERAL CONTRACTOR IS TO ENSURE THAT SHOP DRAWINGS ARE SUBMITTED TO ARCHITECT
- FOR REVIEW AND APPROVAL PRIOR TO THE COMMENCEMENT OF PRODUCTION FOR THE FOLLOWING ITEMS: ALLOW (5) BUSINESS DAYS FOR REVIEW.
 - MILLMORK
 - ELECTRICAL ITEMS ELECTRICAL DISCONNECT SMITCHES
 - TRANSFORMERS
 - PANELS AND SUB-PANELS
 - d. DISTRIBUTION C. KITCHEN EXHAUST SYSTEMS/HOODS

FINISH SCHEDULE LEGEND

FLOOR TILE GROUT FLOOR TILE GROUP G-3 KITCHEN QUARRY TILE PORCELAIN TILE

FRP WALL PANELS @ KITCHEN G-2 WALL TILE GROUT PT-1B MALL PAINT S-1

STAINLESS STEEL WALL PANEL SUBMAY MALL TILE T-1A STAINLESS STEEL MALL TILE PREFINISHED WHITE OAK WOOD BOARDS MATCH BUILDING STANDARD, PATCH AND

REPAIR TO LIKE NEW IF EXISTING

KT-2B KITCHEN QUARRY TILE COVE BASE T-4 PORCELAIN TILE COVE BASE ACOUSTICAL CEILING PANEL AND GRID INTERIOR CEILING PAINT


CG-3B

MISCELLANEOUS FINISHES PLASTIC LAMINATE PLASTIC LAMINATE STAINLESS STEEL WALL PANELS SOLID SURFACE SOLID SURFACE

CORNER GUARD (KITCHEN ONLY)

MALL END CAP

TOILET ACCESSORIES NOTED THUS: (X)

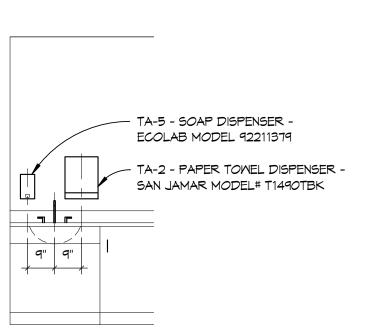

TYPICAL SOAP & PAPER TOWEL DISPENSERS @ SINKS



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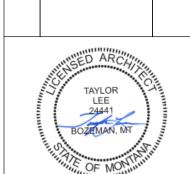
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PHONE: 406.994.5413

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PPA#22-0056 A/E#00-00-00 Consultant #:

SHEET TITLE ROOM FINISH

SCHEDULE SHEET




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PPA#22-0056 A/E#00-00-00 Consultant #:

SHEET TITLE **CFA FINISH**

SCHEDULE

SHEET

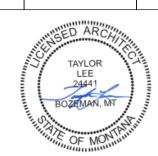DATE 16.06.2023

MATERIAL SCHEDULE COLOR MARK DESCRIPTION MANUFACTURER MODEL NAME MODEL NUMBER NOTE EXISTING FINISH EXISTING FINISH TO REMAIN; PROTECT DURING DEMOLITION AND CONSTRUCTION 01_CEILING FINISHES ACT-1 ACOUSTICAL CEILING PANEL AND GRID CERTAINTEED CEILINGS
PT-1A INTERIOR CEILING PAINT SHERWIN WILLIAMS PERFORMA VINYLROCK 24" x 24" x 1/2" GRID:STANDARD 15/16" SQUARE LAY-IN GRID, WHITE FINISH: FLAT (SEMI-GLOSS ON HORIZONTAL SURFACES) - FURR DOWN FOH NATURAL CHOICE PRO MAR 200 ZERO VOC PAINT SW-7011 02_FLOOR FINISHES USED WITH PORCELAIN TILE FLOOR TILE GROUT ULTRA COLOR GROUT FLOOR TILE GROUT KERAPOXY IEG CQ 47 / CHARCOAL USED WITH QUARRY TILE, GC TO INSTALL WITH STANDARD JOINT WIDTH: 3/8" W THINSET MORTAR; 6"X6" ACCEPTABLE SIZE DAL TILE KITCHEN QUARRY TILE ALTERNATE WHEN NECESSARY DAL TILE PORCELAIN TILE LAVA LIGHT GREY LAVA LIGHT GREY 12" X 12" JOINT WIDTH: 3/16"; INSTALL TILE AT 45 DEGREE OR 90 DEGREE; COORDINATE WITH FINISH PLAN 03_WALL BASE FINISHES JOINT WIDTH: 3/8" WITH THINSET MORTAR; WHEN TILE IS UNDER KT-2B KITCHEN QUARRY TILE COVE BASE DAL TILE 6 " x 8" MILLWORK CABINET OR BELOW TILE - REMOVE BULLNOSE LAVA LIGHT GREY PORCELAIN TILE COVE BASE LAVA LIGHT GREY 6" X 12" COVE JOINT WIDTH: 3/16" 04_WALL FINISHES
FRP-2 FRP WALL PANELS @ KITCHEN MARLITE STANDARD FRP BRIGHT WHITE .090" THICK X 4 X 10 PANELS PROVIDE MARLITE CORNER GUARDS AT ALL OUTSIDE CORNERS IN KITCHEN AREAS, U.N.O. KERACOLOR U WITH GROUT MAXIMIZER LATEX WALL TILE GROUT UNSANDED 09/GRAY PT-1B PRIMARY WALL PAINT PRO MAR 200 ZERO VOC PAINT NATURAL CHOICE FINISH: EGGSHELL SHERWIN WILLIAMS 18 GAUGE STAINLESS STEELWALL PANEL; STAINLESS STEEL WALL PANEL CUSTOM GRADE 304 SUBWAY WALL TILE CMC BONE 4-1/4" X 8-1/2" GROUT: G2, JOINT WIDTH: 1/8" STAINLESS STEEL WALL TILE OGUE STAINLESS STEEL 1" X 2" BRICK, 12 X 12 SHEET GROUT: G2 PREFINISHED WHITE OAK WOOD SKYLAR MORGAN 5" W NATURAL WHITE OAK BOARDS, CUSTOM FINISH: OILED OR WATERLOX WITH BLACK EPOXY FILLED KNOTHOLES CHARACTER GRADE 05_MISCELLANEOUS FINISHES PLASTIC LAMINATE
PLASTIC LAMINATE WILSONART CONTRACT COLLECTION FINISH: MATTE #60 WILSONART CONTRACT COLLECTION PEWTER MESH STAINLESS STEEL WALL PANELS 18 GAUGE STAINLESS STEEL PANELS, BRUSHED #4 GRADE 430 LOCATED BEHIND KITCHEN EXHAUST HOODS, PREP SINK, AND WASH SINK, RE: ELEVATIONS MATTE FINISH SOLID SURFACE FOUNDATIONS MINERALS COLLECTION SERVING COUNTERTOP, REFER TO DRAWINGS AVONITE ALTITUDE SOLID SURFACE AVONITE FOUNDATIONS MINERALS COLLECTION ARTICA BACK LINE COUNTERTOP, REFER TO DRAWINGS 05_TRIM

CG-3A CORNER GUARD (KITCHEN ONLY)

CG-3B WALL END CAP CUSTOM STAINLESS STEEL CORNER GUARD; 2" X 2" LEGS STAINLESS STEEL CUSTOM STAINLESS STEEL CORNER GUARD; WALL CAP WITH 2" STAINLESS STEEL LEG AT ADJACENT WALL FACES







PT-3B









FINISH TYPE: MILLWORK


04 WALL

06 MLLWORK







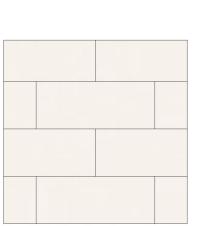

FINISH TYPE: WALL T-1A, T1-E



FINISH TYPE: WALL **T-2**



FINISH TYPE: WALL















FINISH TYPE: MILLWORK PL-3 FINISH TYPE: MILLWORK **S-1** NOTE: PRINTED REPRESENTATION OF FINISHES MAY DIFFER FROM ACTUAL FINISHES

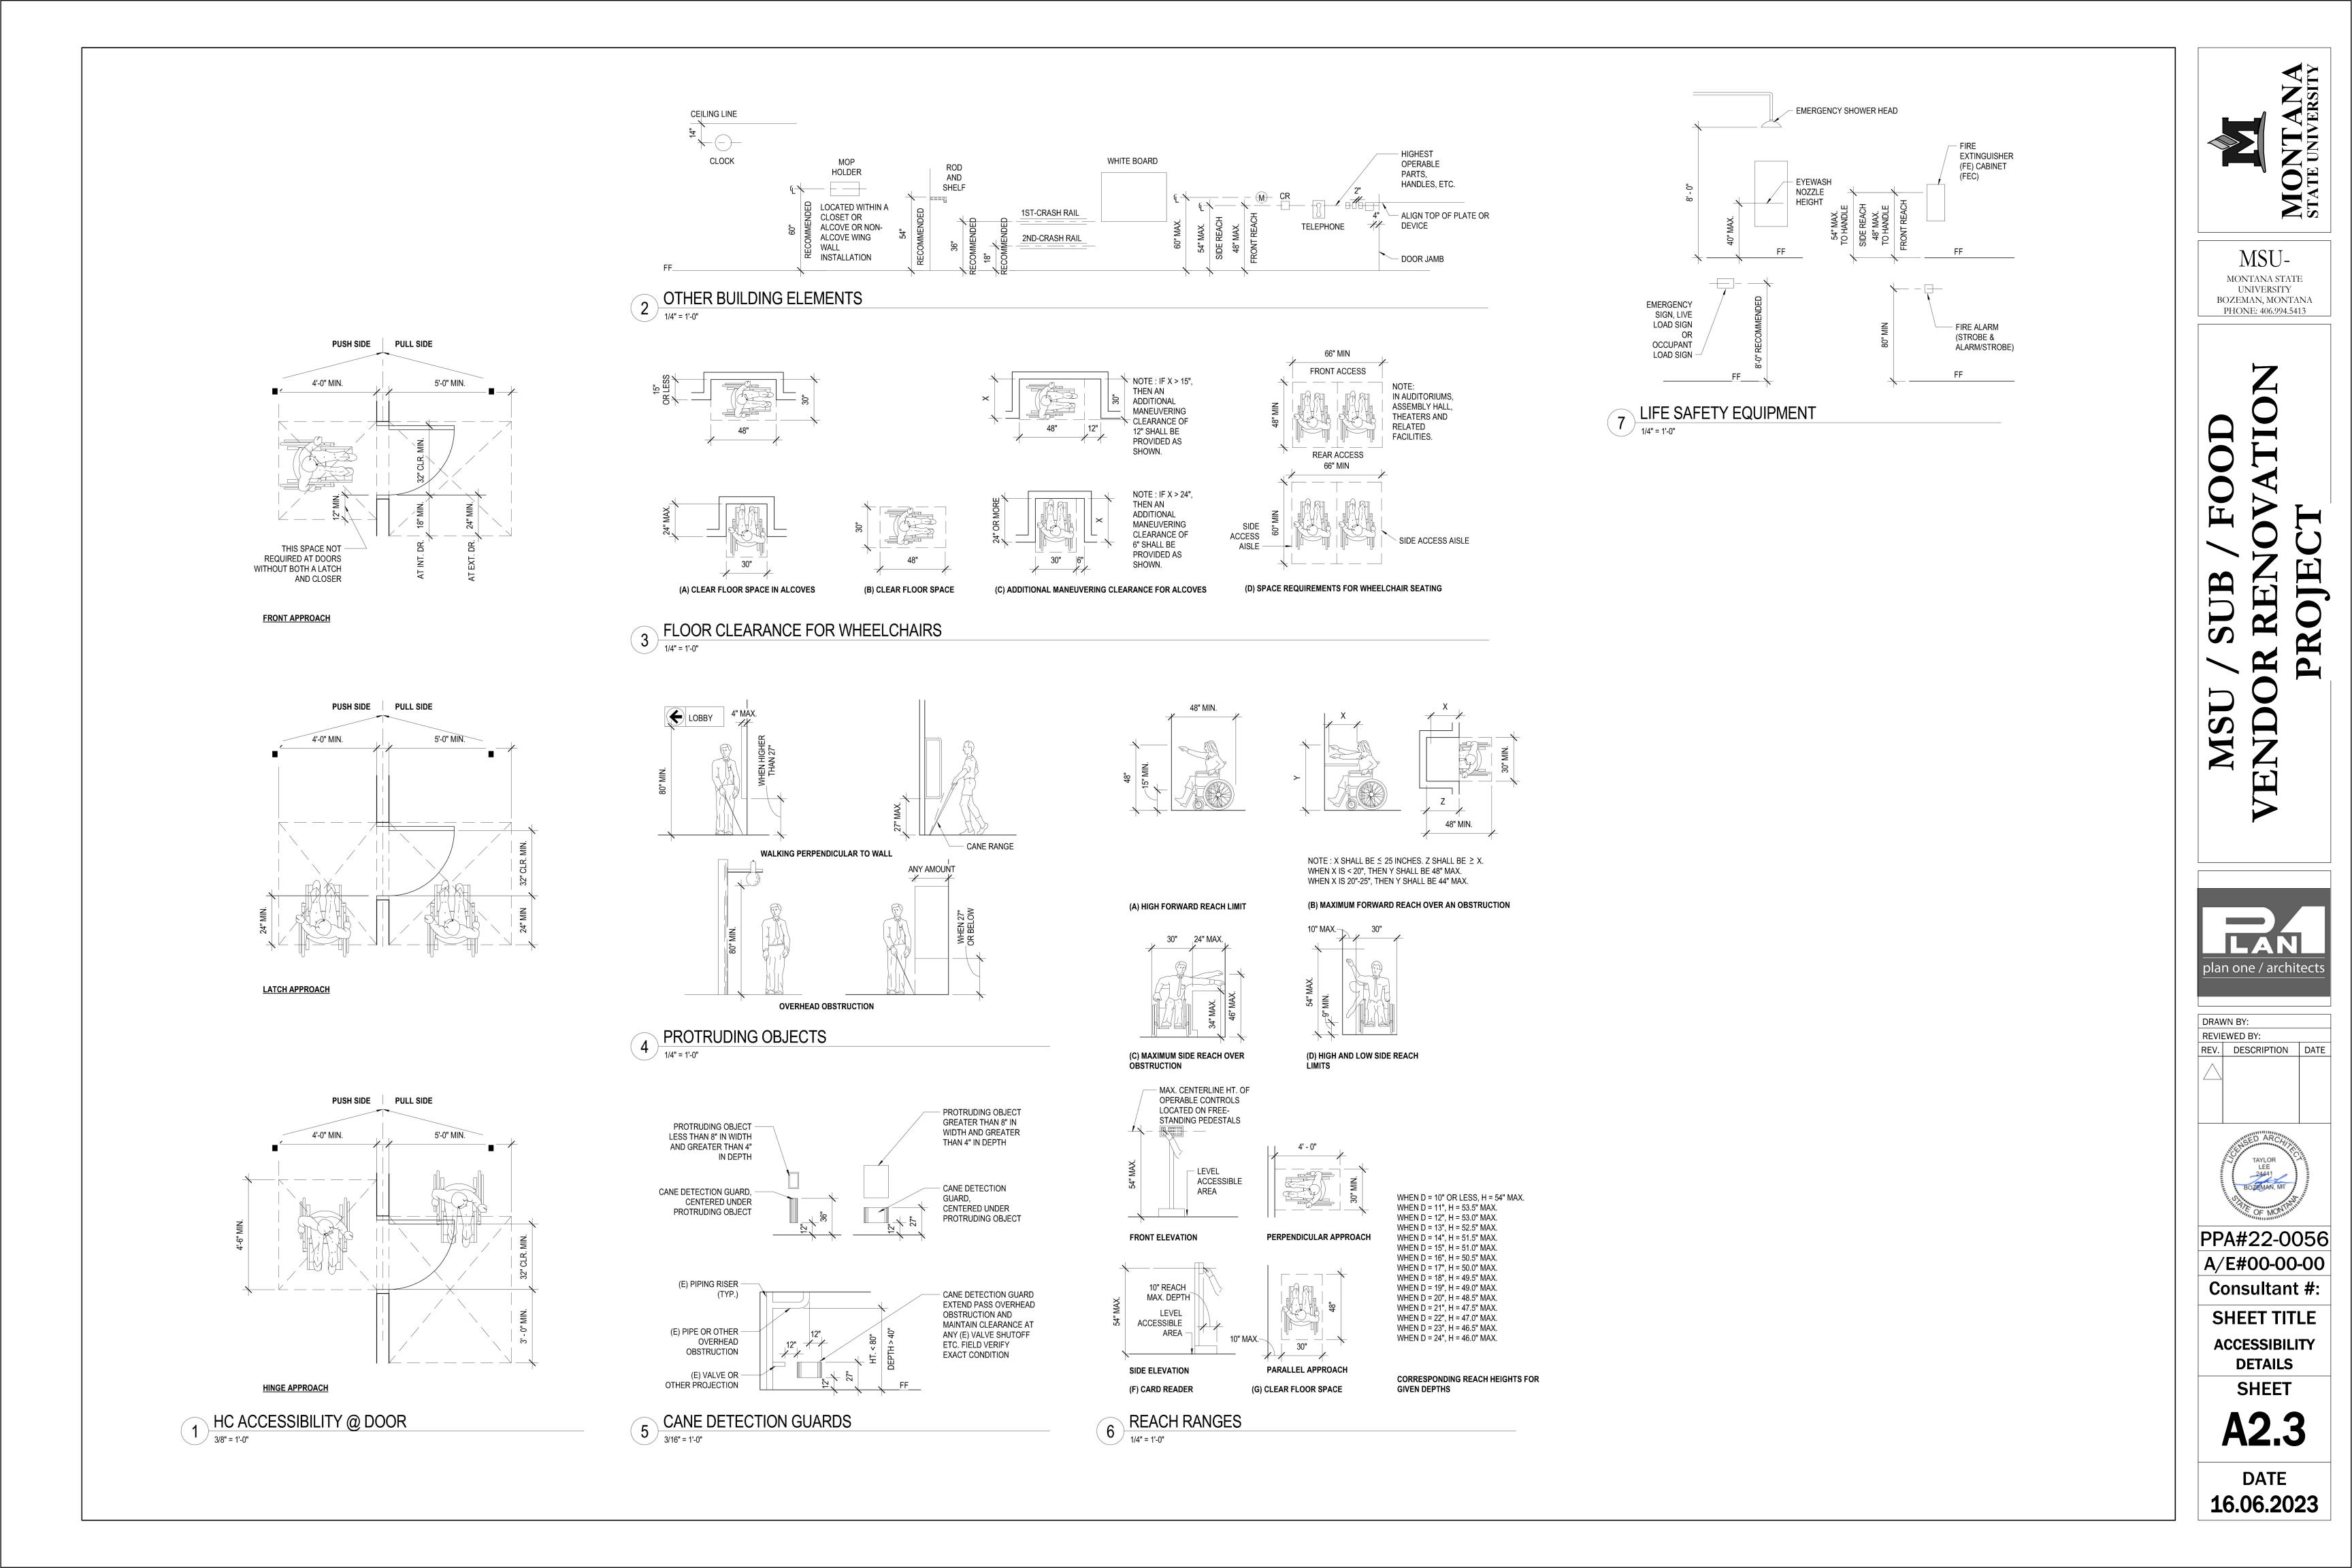

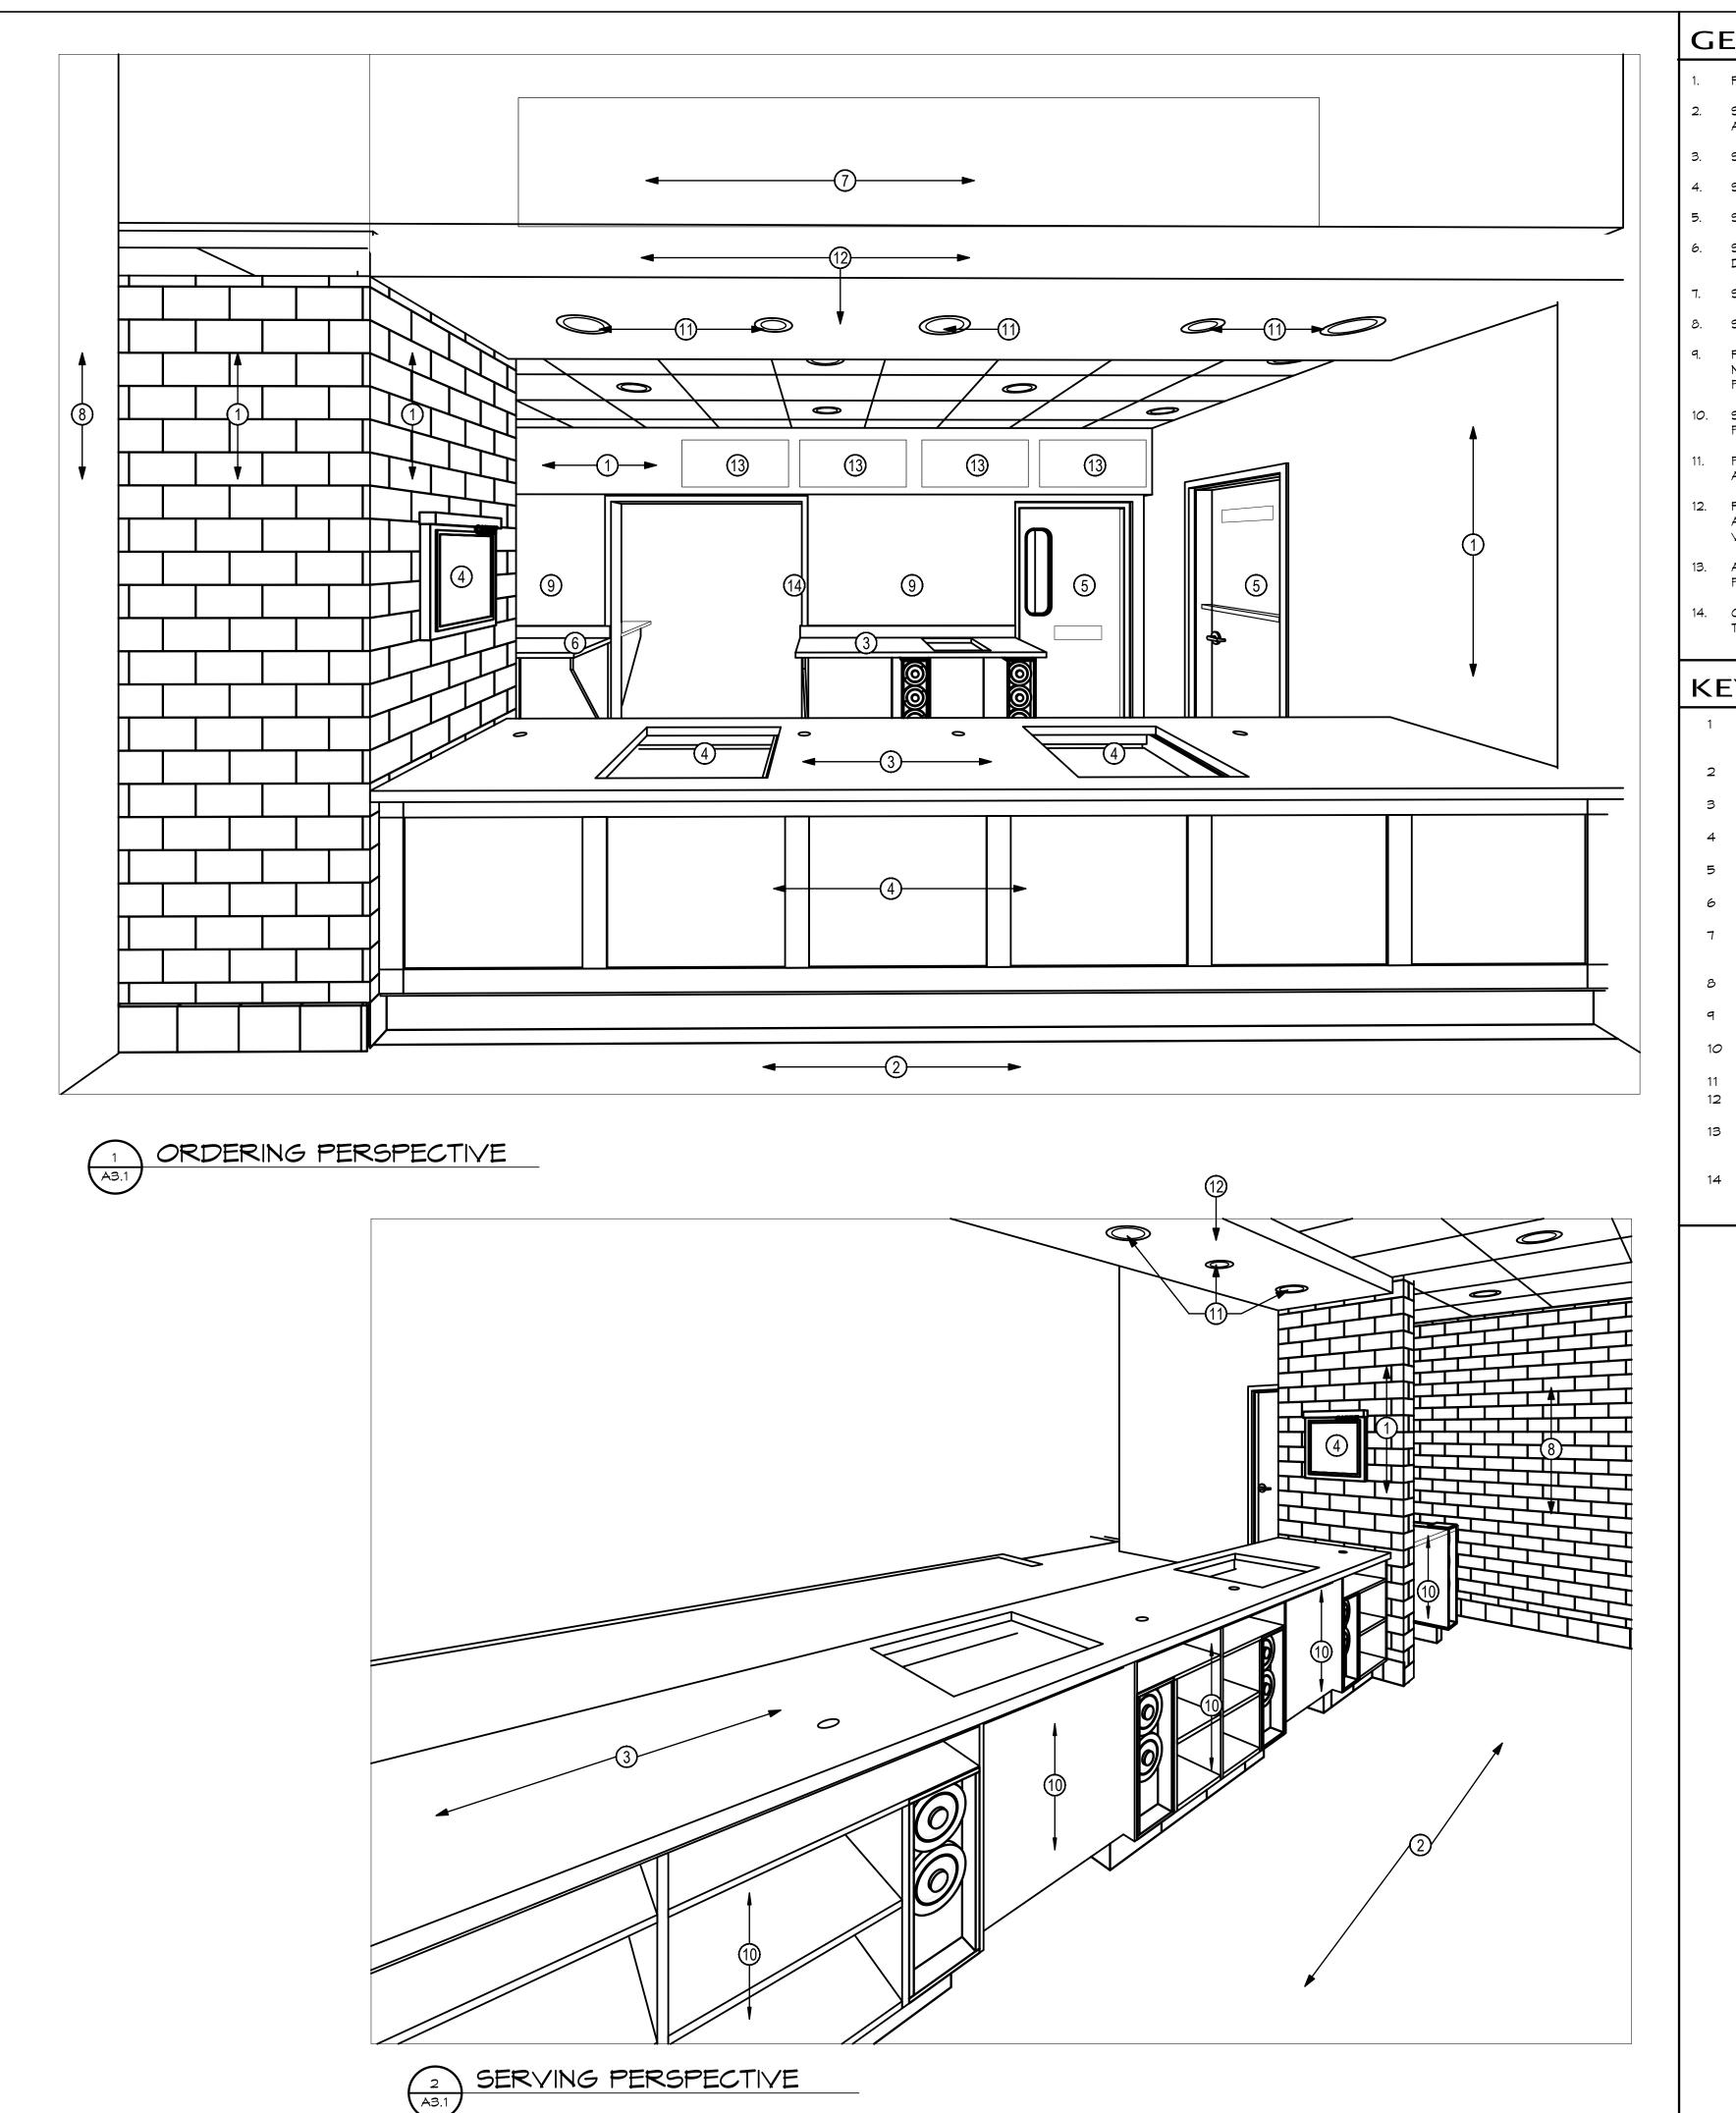

GENERAL NOTES

- PARTITION DIMENSIONS ARE TYPICALLY FACE OF STUD.
- 2. SEE ARCHITECTURAL DIMENSION PLANS AD1.X SERIES FOR DIMENSIONS AND WALL TYPES.
- 3. SEE CODE REVIEW PLAN CR1.1 FOR FIRE RATED WALL LOCATIONS.
- 4. SEE A2.1 DRAWING FOR ROOM FINISH SCHEDULE AND DETAILS.
- 5. SEE A4.X SERIES DRAWINGS FOR ROOF PLANS.
- SEE AS.X FOR ENLARGED FLOOR PLANS, INTERIOR ELEVATIONS AND
- 7. SEE A10.X SERIES DRAWINGS FOR DOOR INFORMATION.
- 8. SEE A11.X SERIES DRAWINGS FOR REFLECTED CEILING PLANS.
- PROVIDE TEMPORARY BARRICADE DURING CONSTRUCTION AS NECESSARY BY LOCAL ORDINANCES; COORDINATE WITH PROJECT AND FACILITIES MANAGERS.
- 10. SOFFITS AND SUSPENDED CEILINGS SHALL BE SECURED TO STRUCTURAL FRAMING ONLY; SEE DETAILS.
- 11. FLOOR DRAINS REQUIRED IN ALL KITCHENS, FOOD PREPARATION AREAS, ANY OTHER LOCATIONS WHERE WATER IS USED.
- 12. PROTECT AND MAINTAIN ACCESS TO ANY EXISTING HVAC, ELECTRICAL AND PLUMBING SYSTEMS INCLUDING, BUT NOT LIMITED TO, CLEANOUTS, VALVES, DAMPERS, JUNCTION BOXES, SMOKE DETECTORS, ETC.
- 13. ALL TRANSITIONS BETWEEN DISSIMILAR FLOOR MATERIALS MUST BE FLUSH AND LEVEL.
- 14. CONTRACTORS IS REQUIRED TO PURCHASE CAMPUS PARKING PERMITS THROUGH THE UNIVERSITY POLICE.

KEYED NOTES

NOTED THUS: X

- METAL STUD FRAMED WALL WITH PLASTIC LAMINATE PANEL FACE FINISH - SEE SHEET AD1.1 FOR WALL TYPES & INTERIOR ELEVATIONS ON SHEET A8.1
- NEW FLOOR FINISH SEE ROOM FINISH SCHEDULE ON A2.1 AND SPECS. SOLID SURFACE COUNTER TOP- SEE INTERIOR ELEVATIONS
- 4 KITCHEN EQUIPMENT SEE VENDOR EQIPMENT SCHEDULE ON K2.X SERIES AND SPECS.
- NEW DOOR, FRAME AND HARDWARE, SEE A10.1 FOR DOOR SCHEDULE AND DOOR HARDWARE SPECS.
- STAINLESS STEEL COUNTERTOP SEE VENDOR PROVIDED SCHEMATIC DRAWING PACKAGE
- LO-PRO SCRIPT WALL MOUNTED SIGNAGE MOUNTED ON FACE OF (E) SOFFIT ABOVE FRONT SERVING COUNTER, SEE INTERIOR ELEVATIONS ON AB.X SERIES DRAWINGS, O.F.C.I.

 (E) WALLS TO REMAIN SEE FINISH SCHEDULE ON SHEET A2.2
- FOR SCHEDULED FINISH & PAINTING SPECS.

 STAINLESS STEEL WALL TILE SEE FINISH SCHEDULE ON A2.2
- AND INTERIOR ELEVATIONS ON A8.X SERIES

 10 PLASTIC LAMINATE CASEMORK SEE A8.X SERIES DRAWINGS
 FOR INTEIROR ELEVATIONS & DETAILS
- NEW RECESSED CAN LIGHT FIXTURE SEE ELECTRICAL

 MENU BOARD SOFEIT SEE REELECTED CEILING PLAN ON
- MENU BOARD SOFFIT SEE REFLECTED CEILING PLAN ON SHEET A11.1
 DIGITIAL MENU BOARDS PROVIDED BY OWNER, INSTALLED BY CONTRACTOR (O.S.C.I.) COORDINATE WITH ELECTRICAL
- DRAWINGS
 STAINLESS STEEL CASED OPENING HEAD & JAMB SEE
 DETAILS & & 9 ON A10.1



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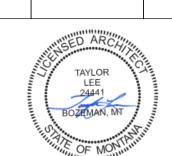
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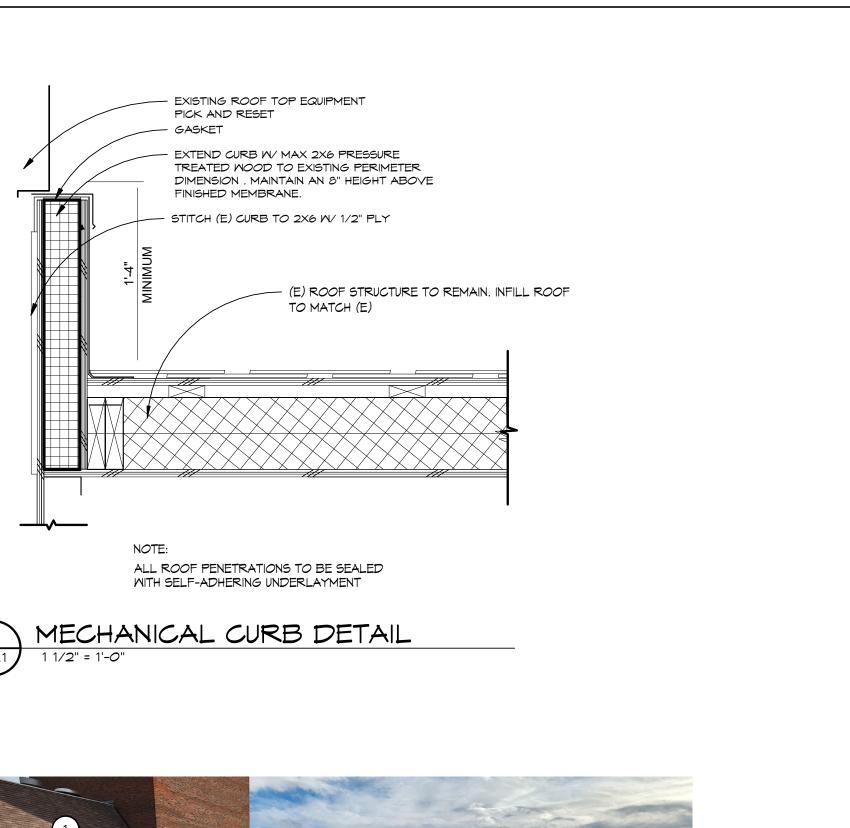


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SHEET TITLE
3D VIEWS

SHEET

A3.1








ROOF PHOTO
NOT TO SCALE


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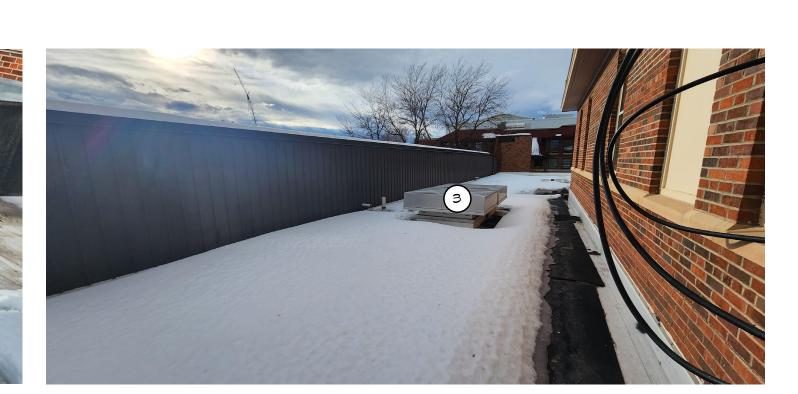







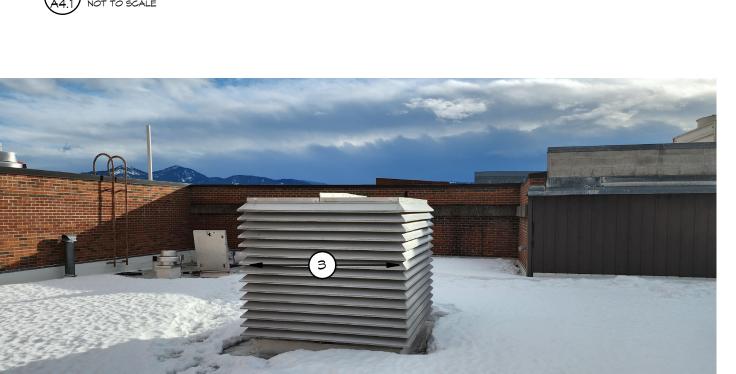

PARTIAL ROOF PLAN

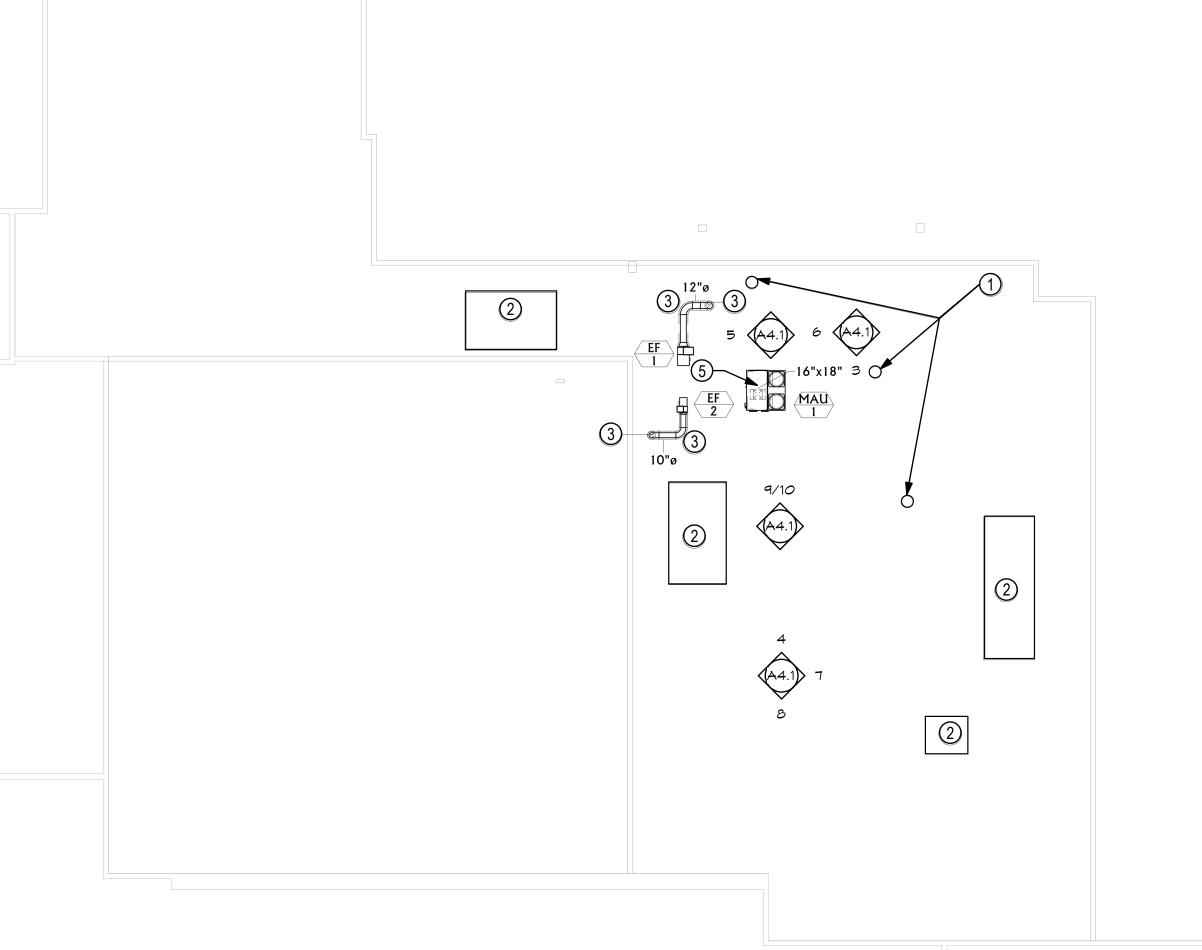



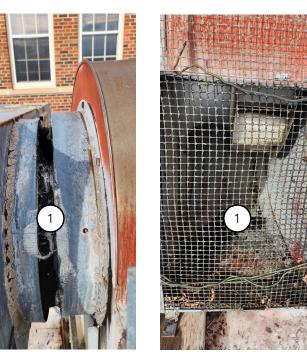



GENERAL NOTES

- REFER TO MECHANICAL DRAWINGS FOR NUMBER AND LOCATION OF VTR'S, EXHAUST VENTS, ROOF DRAINS, MISC. ROOF PENETRATIONS, AND ADDITIONAL INFORMATION. PROVIDE CRICKETS BEHIND CURBS ON SLOPED ROOFS.
- VERIFY EXACT NUMBER OF VTR'S AND OTHER EQUIPMENT WITH MECHANICAL DRAWINGS, NOT ALL ARE SHOWN ON THIS ROOF PLAN.
- COMPLY WITH MANF. STANDARD DETAILS @ V.T.R'S, MECH. CURBS, ETC. TO MAINTAIN WARRANTY.
- ROOFING CONTRACTOR TO USE APPROPRIATE MANF. DETAILS TO OBTAIN/MAINTAIN ROOF WARRANTIES. FOLLOW ROOFING MANUF.

SYSTEM REQUIREMENTS FOR ALL TERMINATIONS AND SEAMS.

- PROVIDE A 115 MPH WIND SPEED WARRANTY FOR ALL ROOF
- WHERE VAPOR BARRIER IS PENETRATED AND AT PERIMETERS OF
- VAPOR BARRIER, ENSURE VAPOR BARRIERS ARE SEALED TIGHT. REFER TO ELECTRICAL DRAWINGS FOR ALL CONDUIT PENETRATIONS REQUIRED AT ROOF.

KEYED NOTES

NOTED THUS: X

- 1 (E) PLUMBING VENT LOCATED AT APPROXIMATE LOCATION SEE MECHANICAL DRAWINGS
- 2 (E) ROOFTOP EQUIPMENT LOCATED AT APPROXIMATE LOCTION. - SEE MECHANICAL DRAWINGS
- 3 NEW ROOFTOP DUCTWORK SEE MECHANICAL DRAWINGS 5 NEW ROOFTOP AIR HANDLING UNIT - SEE MECHANICAL & ELECTRICAL DRAWINGS



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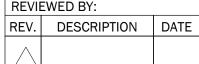
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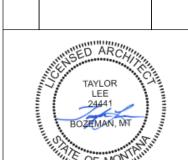
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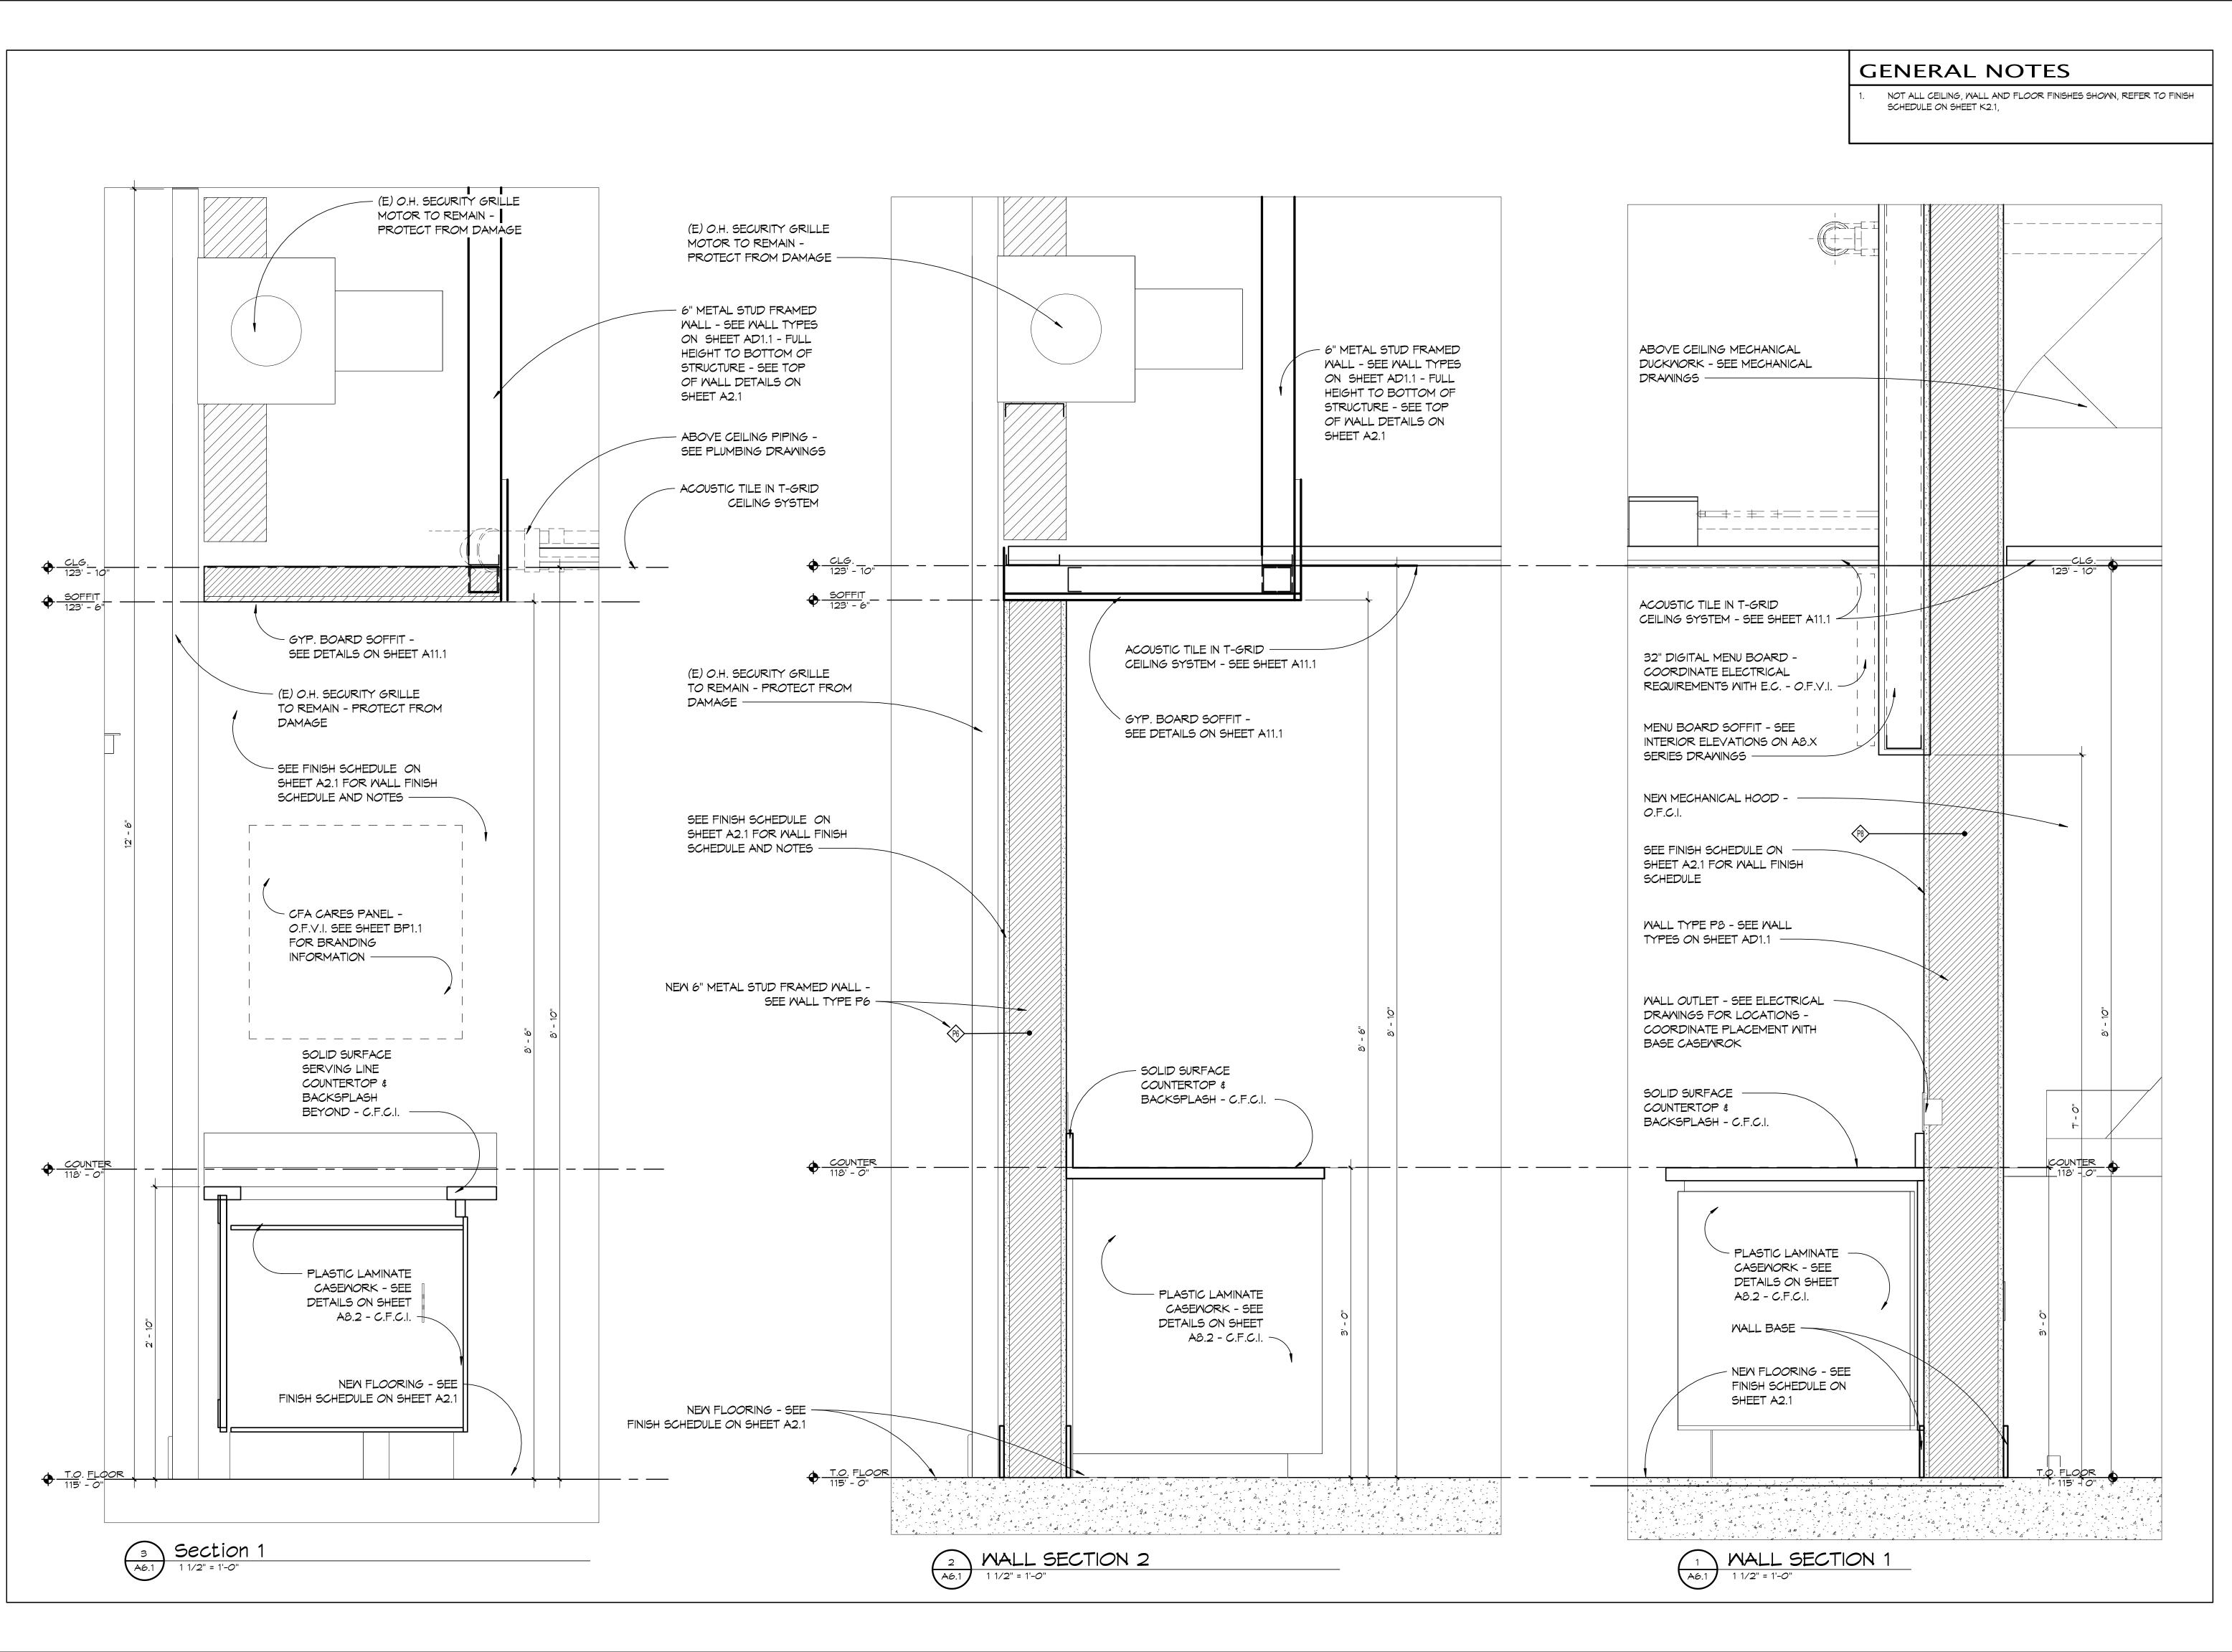


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SHEET TITLE **ROOF PLAN**

SHEET

A4.1





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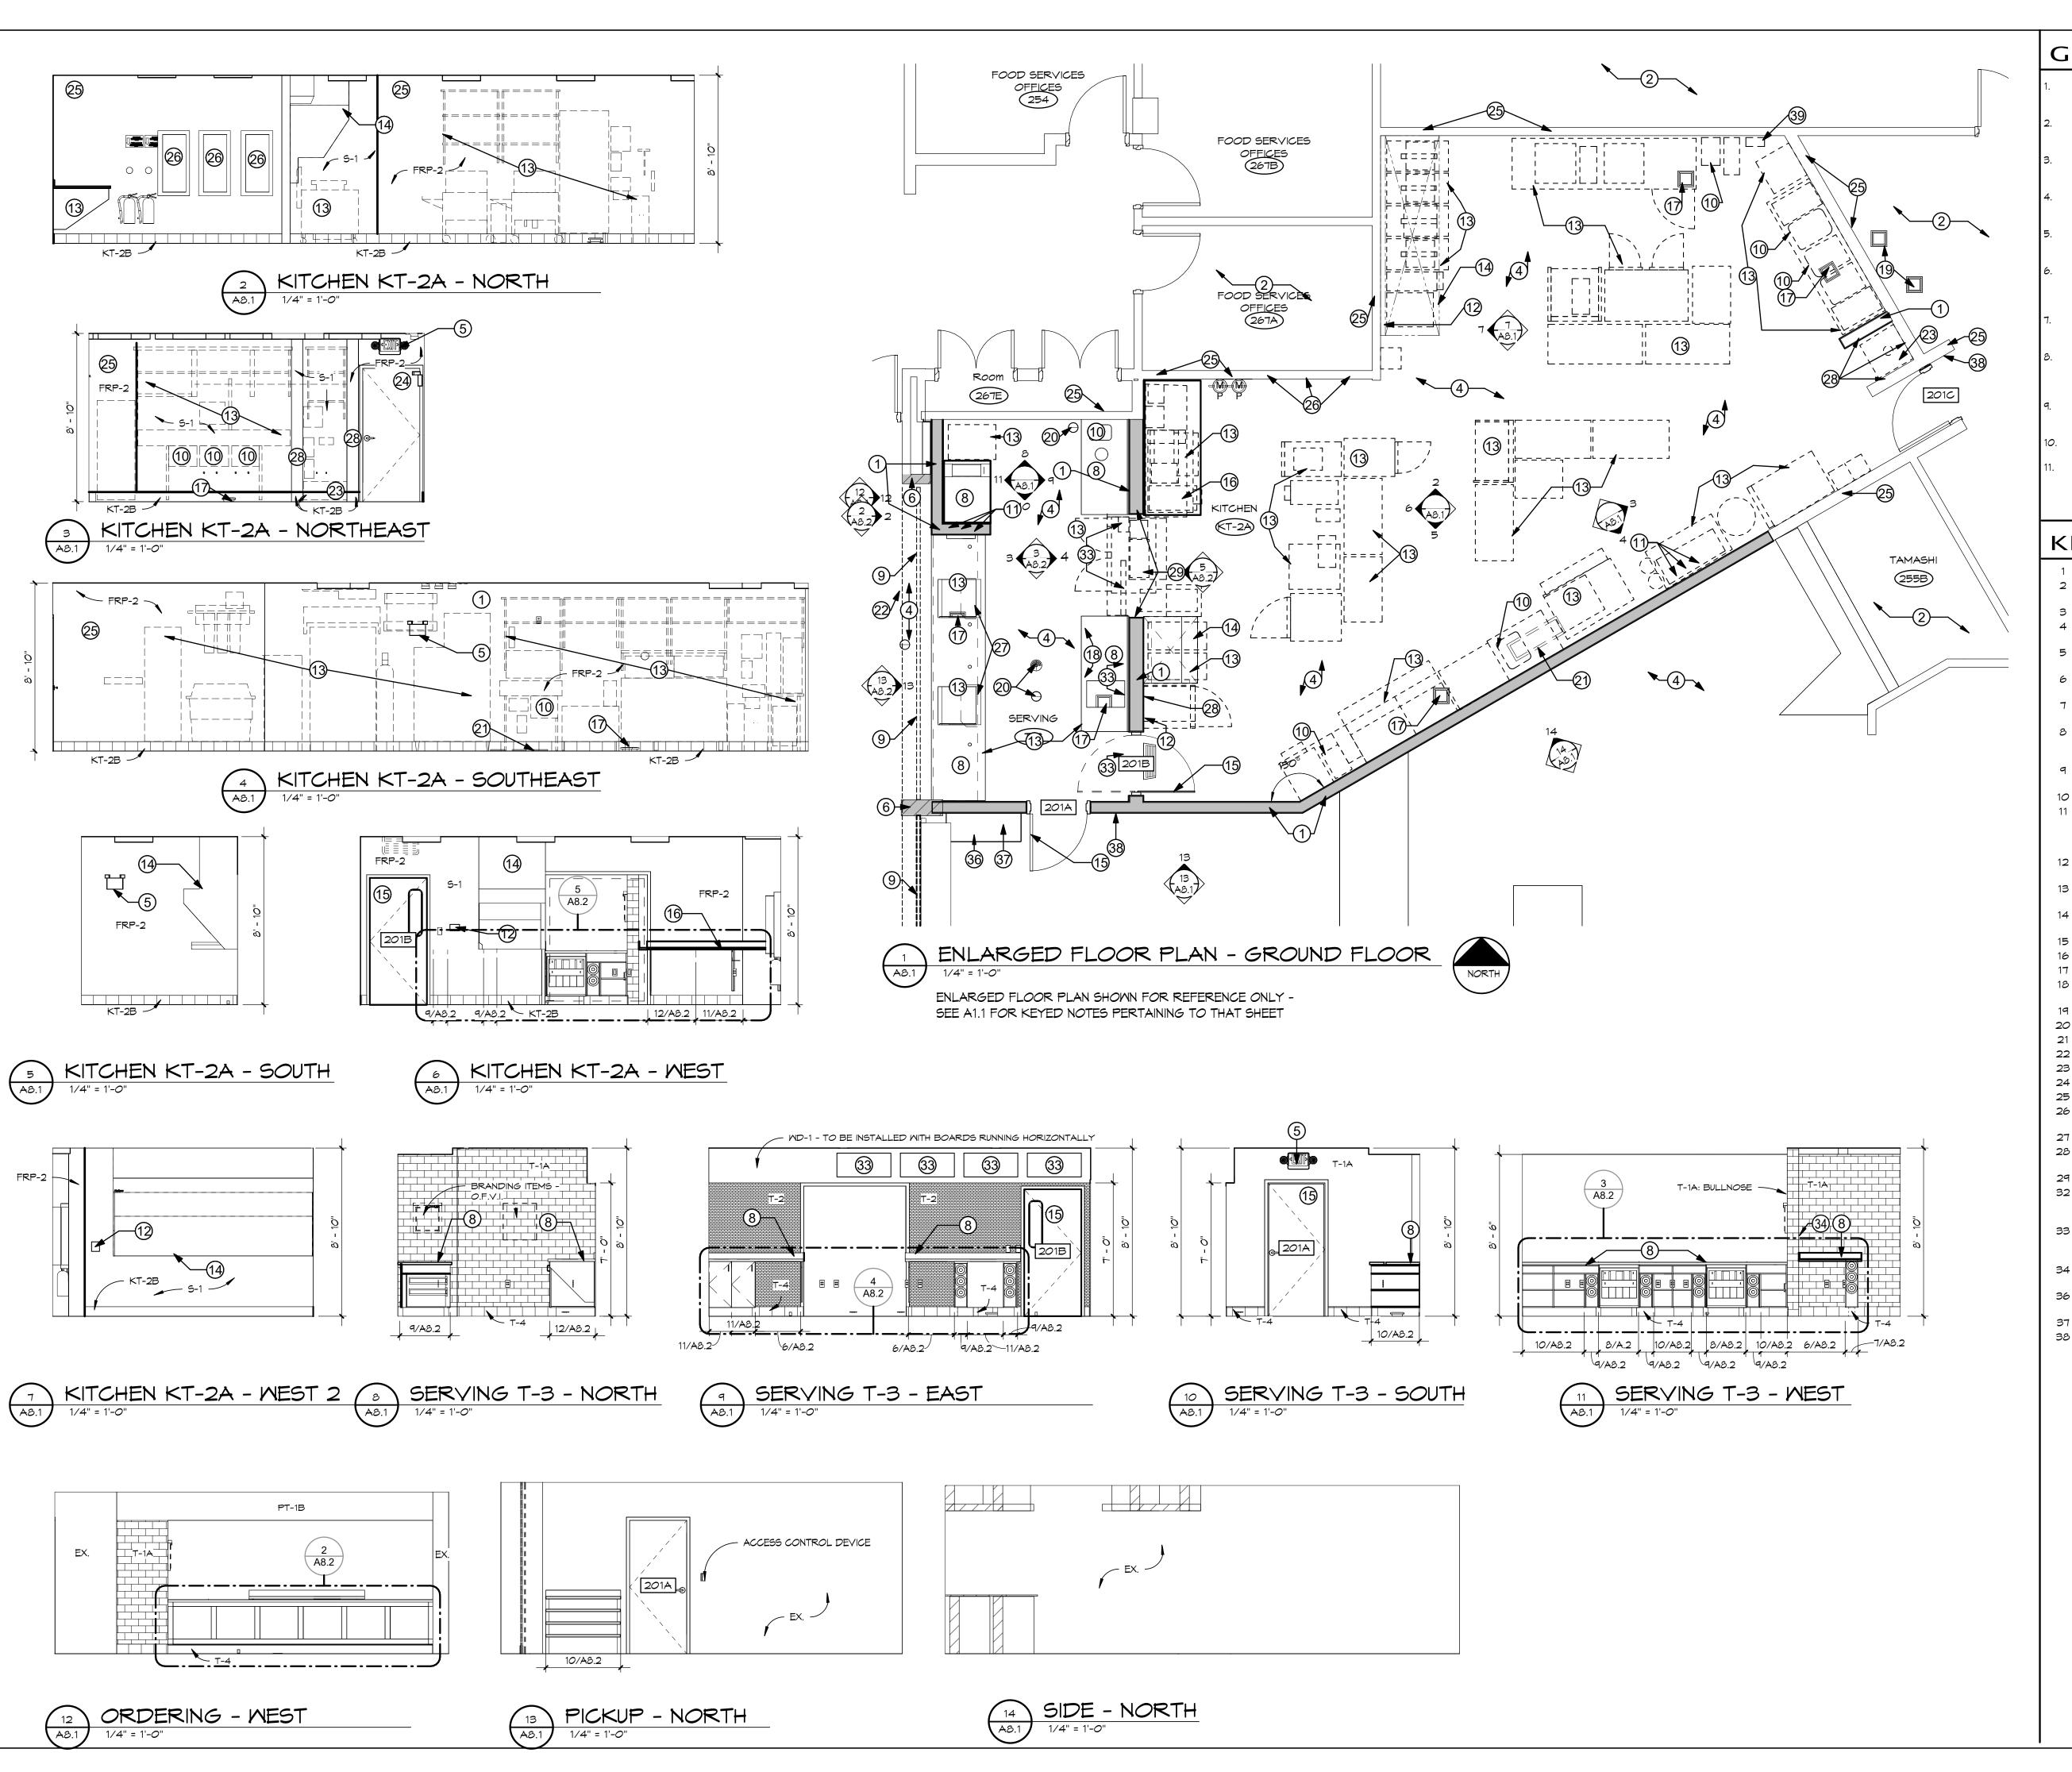


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SHEET

WALL SECTIONS

A6.1



GENERAL NOTES

- VERIFY ALL ROOM FINISH DIMENSIONS PRIOR TO FABRICATION OF
- SEE FINISH SCHEDULE ON SHEET A2.1 AND PROVIDE DESIGNATED BASE AT BOTTOM OF ALL BASE CABINETS.
- ALL INTERIOR ELEVATIONS ARE DRAWN AT 1/4" = 1'-0" UNLESS NOTED
- PROVIDE WALL BLOCKING FOR ALL CASEMORK, ACCESSORIES, AND
- EQUIPMENT AS REQUIRED SEE SHEET A2.1 SEE ELECTRICAL DRAWINGS FOR ALL OUTLET & DEVICE LOCATIONS, NOT
- ALL SHOWN ON THESE ELEVATIONS.
- HORIZONTAL DIMENSIONS SHOWN ON THESE ELEVATIONS ARE APPROXIMATE. DIMENSIONS SHOWN ON AD1.X SERIES FLOOR PLANS
- SEE A10.X SERIES DRAWINGS FOR ACTUAL DOOR AND WINDOW ELEVATIONS (TRIM, PANELED DOORS, ETC.).
- GENERAL CONTRACTOR IS TO CUT HOLES FOR INSTALLATION OF ELECTRICAL FIXTURES IN ALL COUNTERTOP TYPES - COORDINATE WITH ELECTRICAL.
- INTERIOR ELEVATIONS DO NOT SHOW ENTIRE DETAIL AT DOOR AND WINDOW SYSTEMS (BLINDS, SILLS, APRONS, TRIM, ETC.)
- SEE A2.1 FOR FINISH ABBREVIATIONS.
- COORDINATE ELECTRICAL WALL OUTLETS & THEIR PLACEMENT WITHIN OPEN CASEMORK BELOW COUNTERTOPS

KEYED NOTES

DEMO AS NECESSARY

- NOTED THUS: X
- NEW METAL STUD FRAMED WALL, SEE AD1.1 FOR WALL TYPES 2 NO WORK IN THIS ROOM- PATCH & FINISH ANY WALL FROM
- 3 EXISTING FLOORING TO REMAIN PROTECT FROM DAMAGE 4 NEW FLOOR FINISH - SEE ROOM FINISH SCHEDULE ON A2.1 &
- 5 NEW WALL MOUNTED ELECTRICAL DEVICE SEE ELECTRICAL
- DRAWINGS EXISTING STRUCTURAL COLUMN TO REMAIN - PROTECT FROM
- DAMAGE
- (E) WALL MOUNTED ELECTRICAL DEVICE TO REMAIN SEE ELECTRICAL DRAWINGS
- 8 SOLID SURFACE COUNTERTOP WITH P-LAM BASE CASEMORK SEE DETAILS ON SHEET A8.2 - CONTRACTOR FURNISH CONTRACTOR INSTALL
- 9 EXISTING SECURITY GRILL TO REMAIN PROTECT FROM DAMAGE
- 10 NEW PLUMBING FIXTURE, SEE PLUMBING DRAWINGS 11 NEW 4" PVC BEVERAGE CHASES - ROUTE FROM 6" BELOW CEILING & THROUGH THE WALL, DOWN TO BELOW THE CASEMORK COUNTER TOP - MSU VENDOR TO PROVIDE SHOP
- DRAWINGS FOR COORDINATION 12 NEW ANSUL PULL LOCATIONS FOR HOODS, SEE MECHANICAL
- AND ELECTRICAL DRAWINGS 13 KITCHEN EQUIPMEN - O.F.C.I. - GC TO PROVIDE ALL REQUIRED
- MECHANCIAL & ELECTRICAL INFRASTRUCTURE AS REQUIRED 14 NEW KITCHEN HOOD - ALIGN WITH EDGE OF WALL OR
- PASS-THRU O.F.C.I. SEE MECH. DWGS
- 15 NEW DOOR, SEE A10.1 FOR DOOR SCHEDULE
- 16 STAINLESS STEEL COUNTERTOP
- 17 NEW FLOOR SINK SEE PLUMBING DRAWINGS
- 18 PRESSURE TREATED CURB BELOW SECURE TO EXISTING SUB
- 19 (E) FLOOR SINK TO REMAIN SEE PLUMBING DRAWINGS
- 20 NEW FLOOR DRAIN SEE PLUMBING DRAWINGS 21 NEW FLOOR RECEPTOR - SEE PLUMBING DRAWINGS
- 22 SIGNAGE SEE SPECS
- 23 NEW MOP SINK SEE PLUMBING DRAWINGS 24 (E) DOOR TO REMAIN - PROTECT FROM DAMAGE
- 25 (E) WALLS TO REMAIN SEE FINISH SCHEDULE
- 26 WALL MOUNTED ELECTRICAL PANELS SEE ELECTRICAL DRAWINGS
- 27 POINT OF SALE (POS) REIGSTERS BY OWNER N.I.C 28 STAINLESS STEEL WALL PANELS - SEE INTERIOR ELEVATIONS
- ON SHEET A8.1
- 29 STAINLESS STEEL CASED OPENING HEAD & JAMB 32 PORTION OF (E) SALAD BAR CASEMORK, EQUIPMENT, PLUMBING FIXTURES & ELECTRICAL TO REMAIN. - PROTECT
- REMAINING FINISHES 33 DIGITAL MENU BOARDS - OWNER FURNISH VENDOR (CINEPLEX) INSTALL - COORDINATE REQUIRED ELECTRIC WITH ELECTRICAL
- 34 RELOCATED CONTROLS FOR THE EXISTING O.H. SECURITY
- 36 CEILING MOUNTED "PICK UP" SIGN OWNER FURNISHED, OWNER
- INSTALLED SEE SPECS 37 "PICK UP" SHELVING RACK - BY OWNER
- 38 ACCESS CONTROL DEVICE SEE ELECTRICAL DRAWINGS & DOOR HARDWARE SPECIFICATION SECTION 08 71 00



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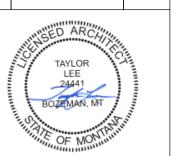
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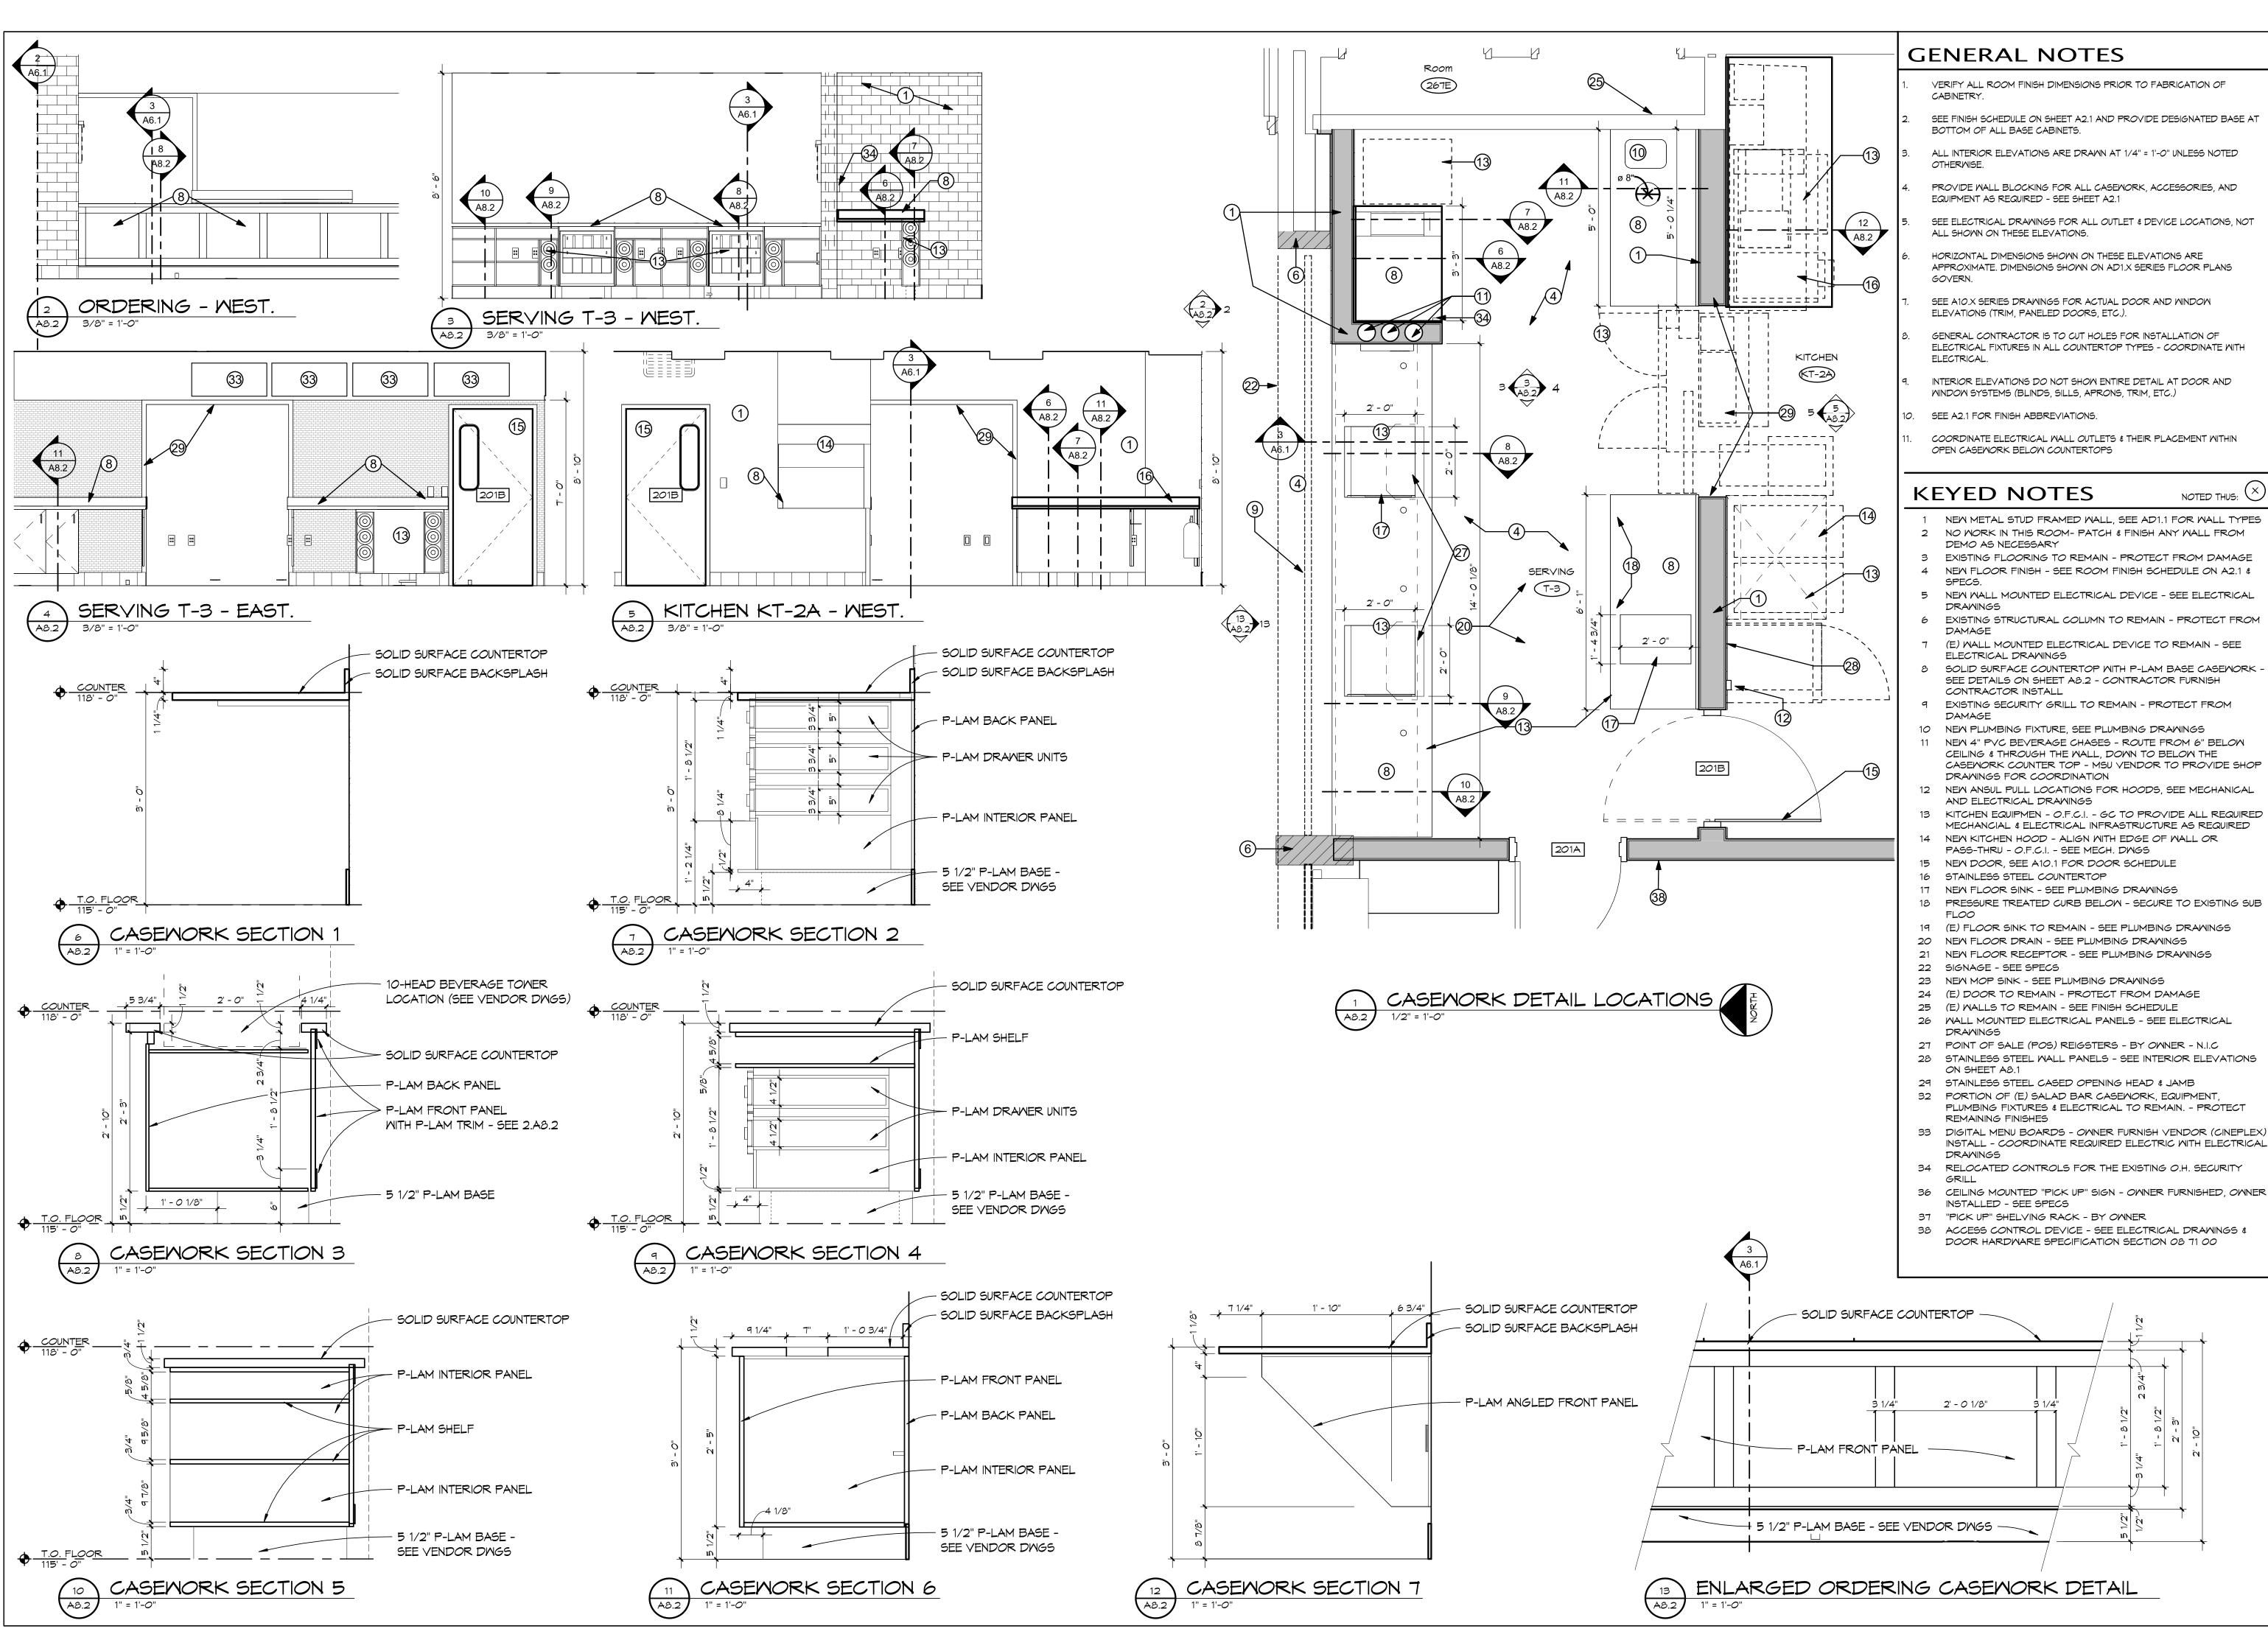



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SHEET TITLE INTERIOR **ELEVATIONS**

SHEET

A8.1






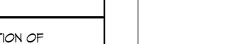

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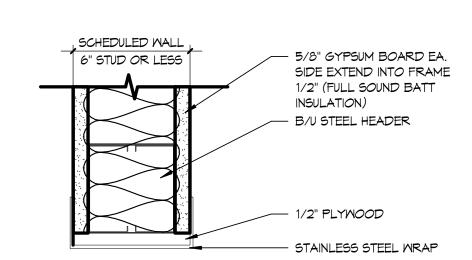
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SHEET TITLE **CASEWORK DETAILS**


SHEET

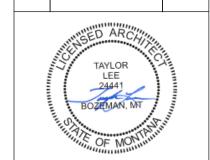A8.2

DOOR DETAILS







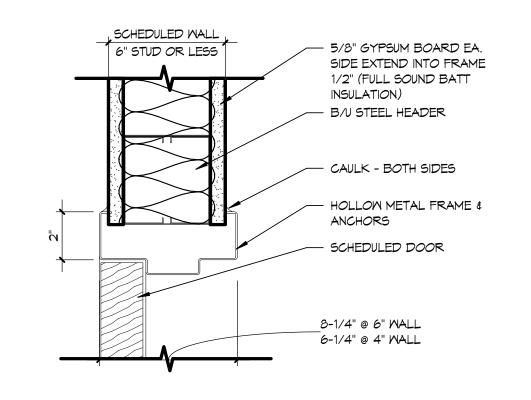




8-1/4" @ 6" WALL 6-1/4" @4" WALL

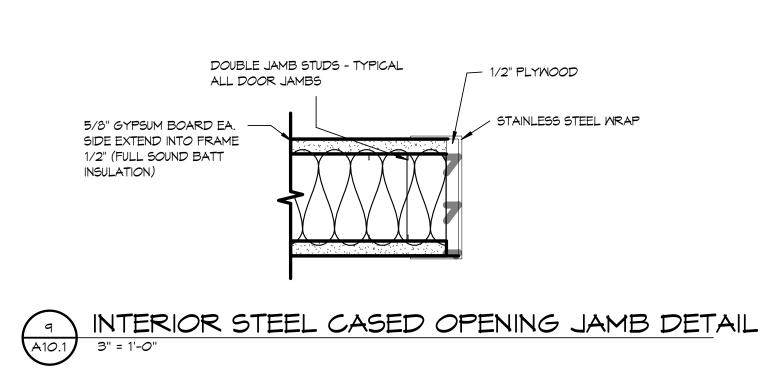

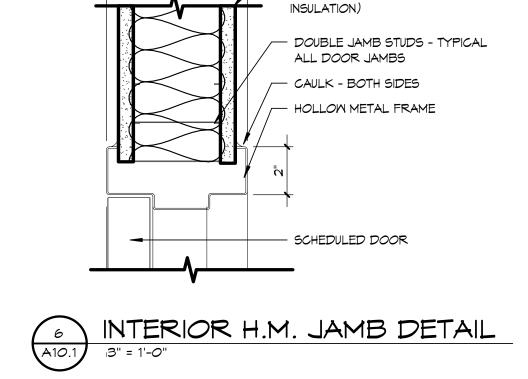

- 5/8" GYPSUM BOARD EA. SIDE EXTEND INTO FRAME 1/2" (FULL SOUND BATT

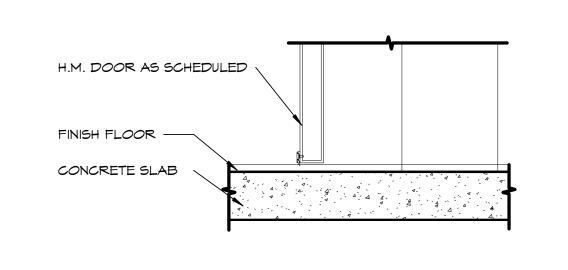


H.M. DOOR THRESHOLD - TYP

1 1/2" = 1'-0"


DOOR SCHEDULE

Ш	DOOR NUMBER	DOOR TYPE	DOOR SIZE	FRAME TYPE	HEAD DETAIL	JAMB DETAIL	HDMR	REMARKS
	201A	В	3' - 0" X 7' - 0 "	Α	5/A10.1	6/A10.1	1	
	201B	C	3' - 0" × 6' - 8"	Α	5/A10.1	6/A10.1	2	
	2010	A	3' - 0" X 6' - 8"	В	5/A10.1	6/A10.1	3	
OOR HEE			FOR ADDITIONAL SEE SPEC SECTIO		N DOOR HARDWA	RE GROUPS -		

DOOR TYPES

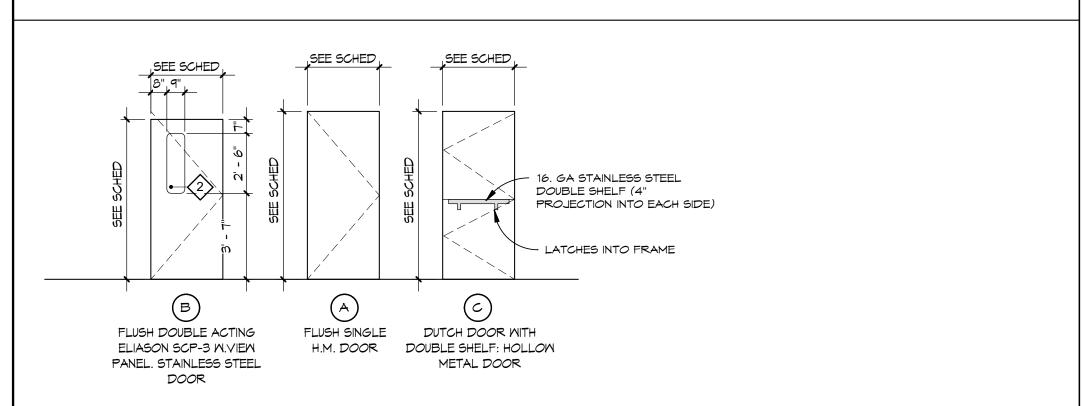

DOOR FRAMES

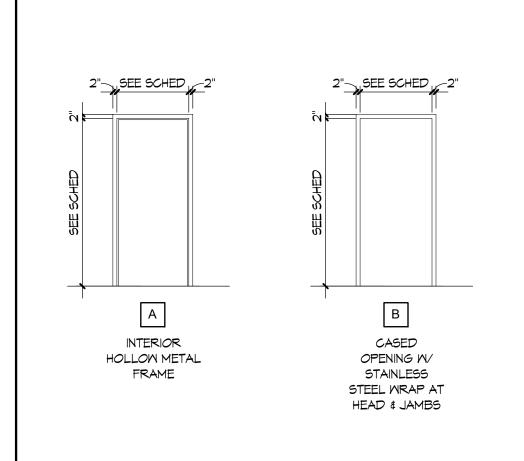

DOOR NOTES


- FIELD VERIFY ALL ROUGH OPENINGS PRIOR TO FABRICATION OF DOOR AND **WINDOW FRAMES.**
- PROVIDE SEALANT ENTIRE PERIMETER OF ALL DOOR AND WINDOW FRAMES -BOTH SIDES.
- PROVIDE ADEQUATE BARRIER AGAINST CORROSION BETWEEN DIFFERENT TYPES OF MATERIALS THAT MAY COME IN CONTACT.
- ALL HOLLOW METAL FRAME THROAT DIMENSIONS ARE TO BE FIELD VERIFIED PRIOR TO FRAME FABRICATION.
- REFER TO A1.X, AD1.X AND A3.X SERIES DRAWINGS FOR DOOR AND CASED
- OPENING LOCATIONS. 6. SEE SHEET A2.1 FOR ROOM FINISH SCHEDULE FOR WALL AND FLOOR FINISHES.
- ACCESS DOORS DO NOT APPEAR ON THE DOOR SCHEDULE. SEE FLOOR, CEILING, MECHANICAL AND PLUMBING PLANS FOR REQUIRED ACCESS DOORS.
- 8. COORDINATE HARDWARE WITH FACILITY STANDARDS, HANDLE STYLE & FINISH.
- ALL LOCKSETS TO BE KEYED TO MATCH FACILITY STANDARDS.
- 10. GROAT FULL ALL HOLLOW METAL DOOR FRAMES IN EXCESS OF 3'-0".






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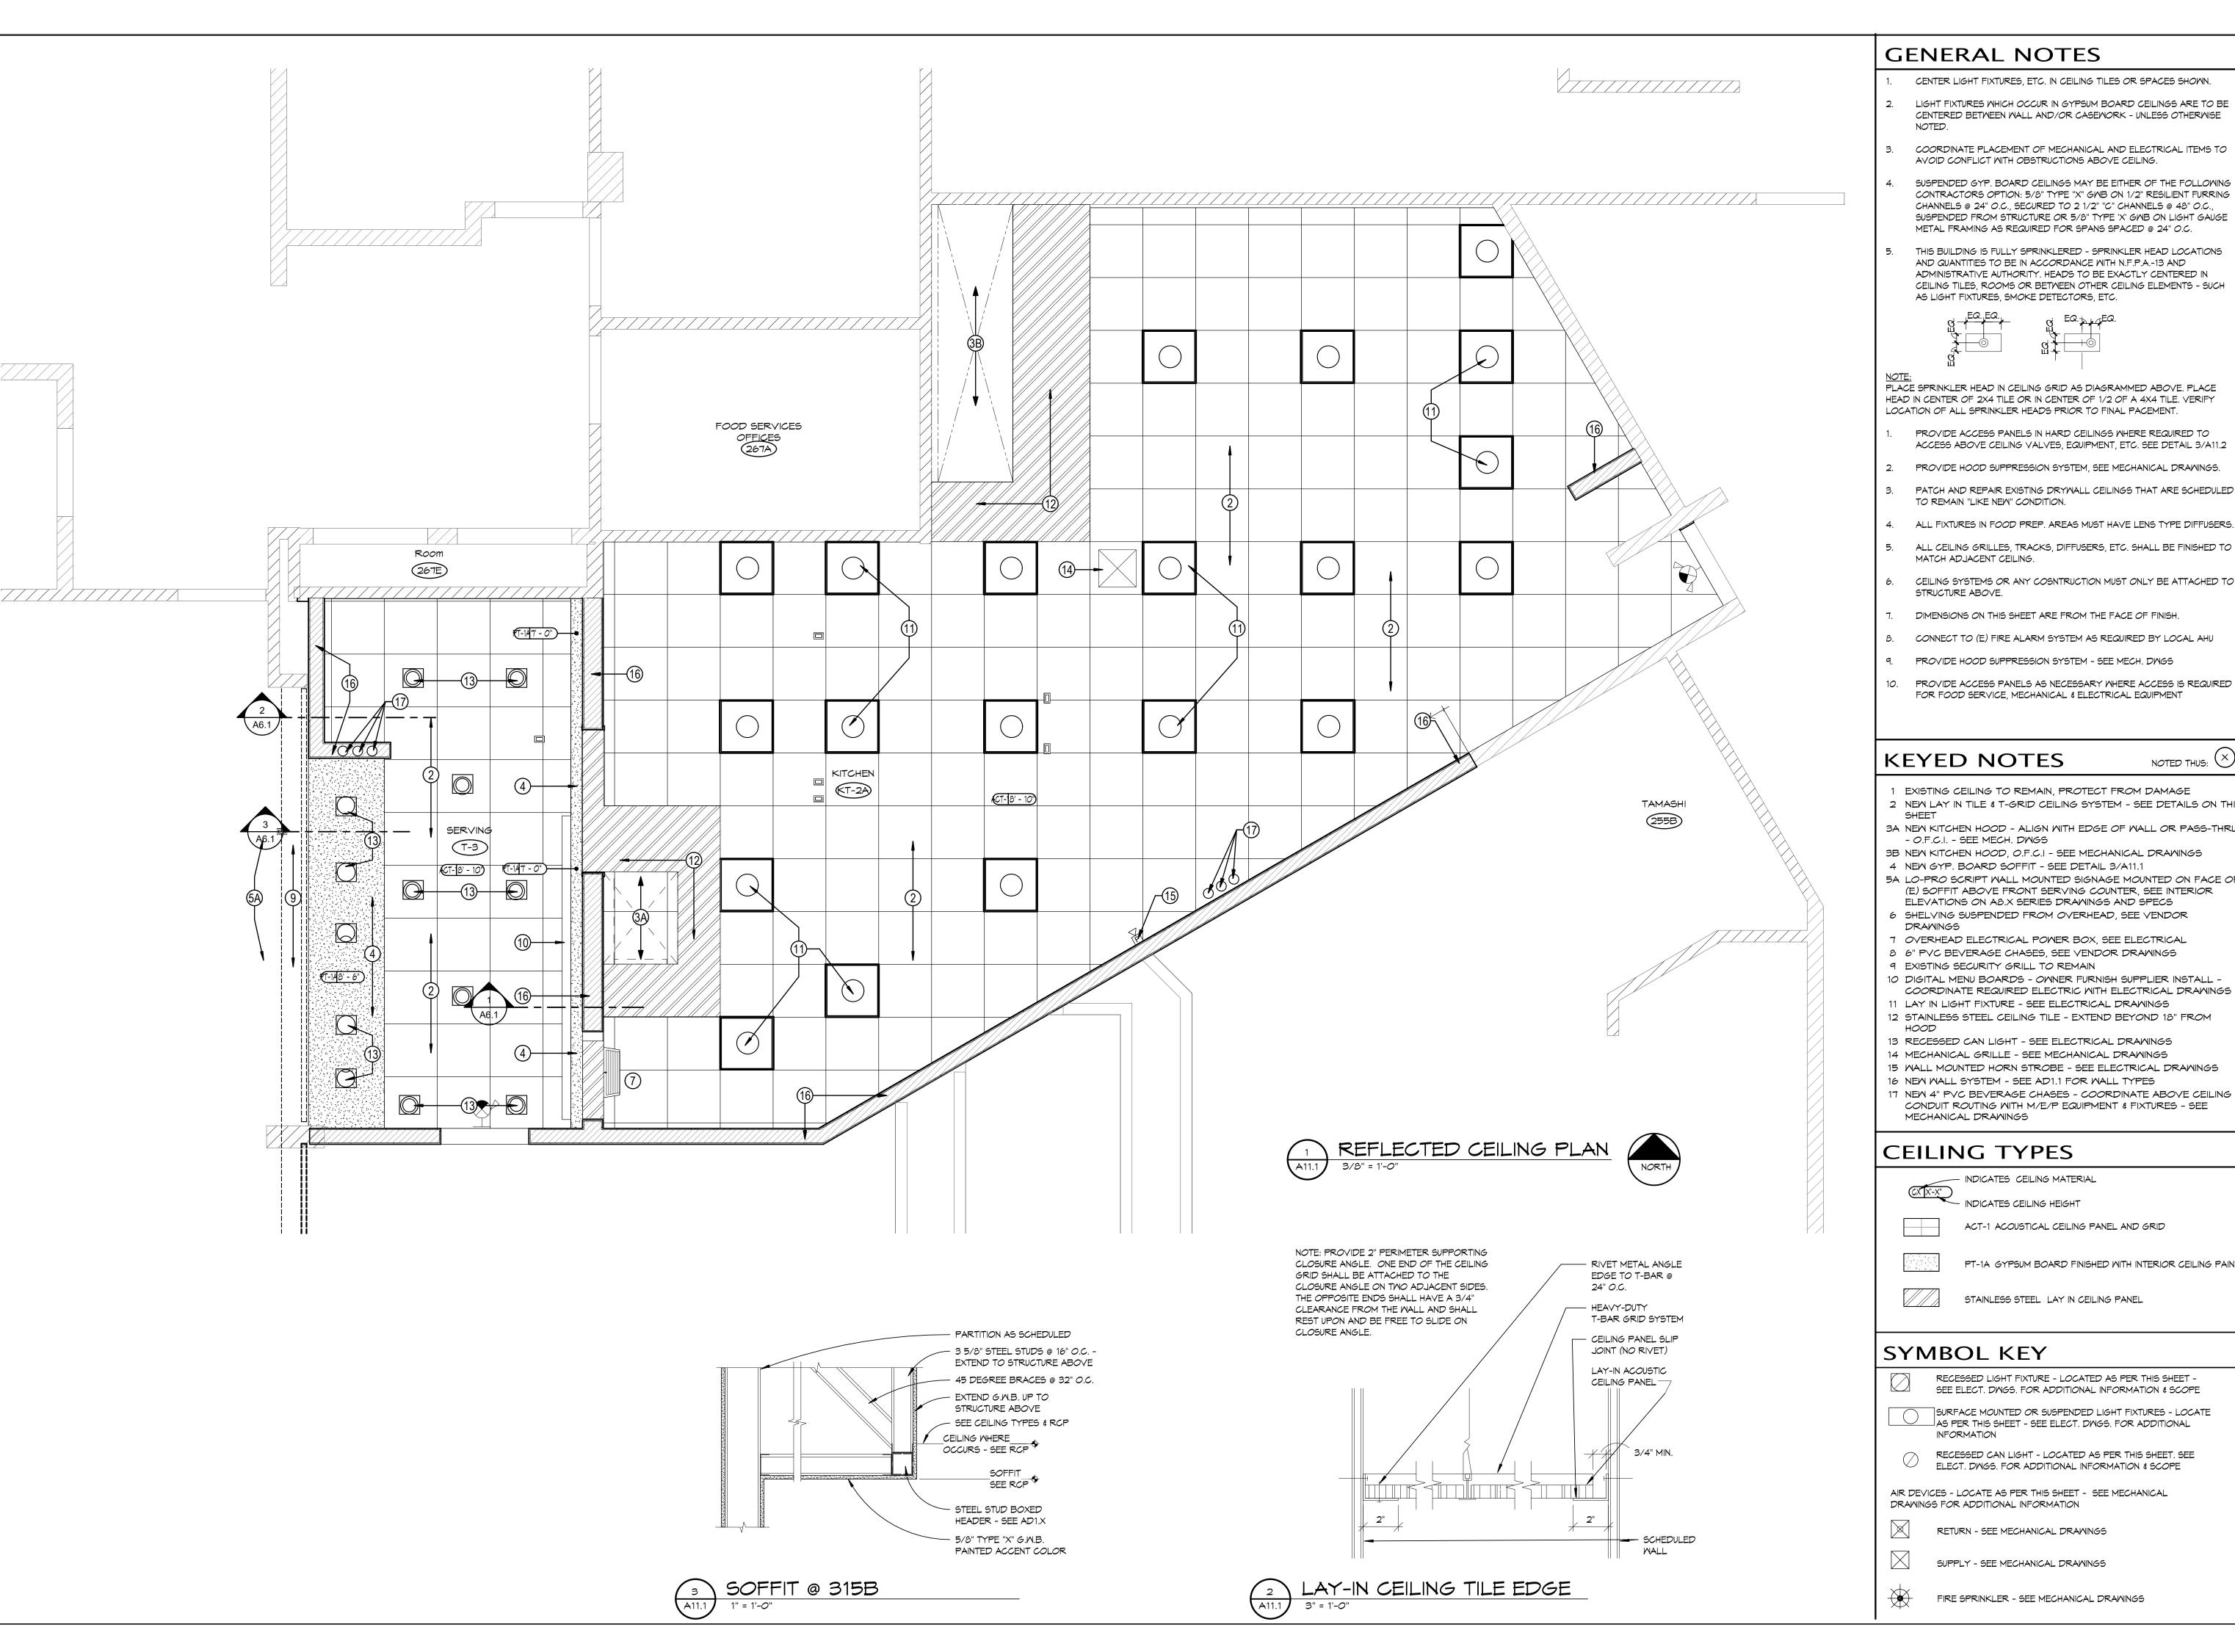




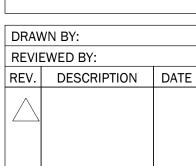

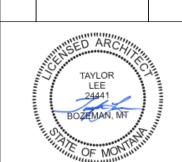
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SHEET



GENERAL NOTES

- CENTER LIGHT FIXTURES, ETC. IN CEILING TILES OR SPACES SHOWN.
- LIGHT FIXTURES WHICH OCCUR IN GYPSUM BOARD CEILINGS ARE TO BE CENTERED BETWEEN WALL AND/OR CASEMORK - UNLESS OTHERWISE
- COORDINATE PLACEMENT OF MECHANICAL AND ELECTRICAL ITEMS TO AVOID CONFLICT WITH OBSTRUCTIONS ABOVE CEILING.
- SUSPENDED GYP. BOARD CEILINGS MAY BE EITHER OF THE FOLLOWING CONTRACTORS OPTION: 5/8" TYPE "X" GWB ON 1/2" RESILIENT FURRING CHANNELS @ 24" O.C., SECURED TO 2 1/2" "C" CHANNELS @ 48" O.C., SUSPENDED FROM STRUCTURE OR 5/8" TYPE 'X' GMB ON LIGHT GAUGE METAL FRAMING AS REQUIRED FOR SPANS SPACED @ 24" O.C.
- THIS BUILDING IS FULLY SPRINKLERED SPRINKLER HEAD LOCATIONS AND QUANTITIES TO BE IN ACCORDANCE WITH N.F.P.A.-13 AND ADMINISTRATIVE AUTHORITY. HEADS TO BE EXACTLY CENTERED IN CEILING TILES, ROOMS OR BETWEEN OTHER CEILING ELEMENTS - SUCH AS LIGHT FIXTURES, SMOKE DETECTORS, ETC.

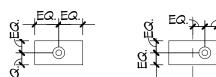

PLACE SPRINKLER HEAD IN CEILING GRID AS DIAGRAMMED ABOVE. PLACE HEAD IN CENTER OF 2X4 TILE OR IN CENTER OF 1/2 OF A 4X4 TILE. VERIFY LOCATION OF ALL SPRINKLER HEADS PRIOR TO FINAL PACEMENT.

- PROVIDE ACCESS PANELS IN HARD CEILINGS WHERE REQUIRED TO ACCESS ABOVE CEILING VALVES, EQUIPMENT, ETC. SEE DETAIL 3/A11.2
- PROVIDE HOOD SUPPRESSION SYSTEM, SEE MECHANICAL DRAWINGS.
- PATCH AND REPAIR EXISTING DRYWALL CEILINGS THAT ARE SCHEDULED TO REMAIN "LIKE NEW" CONDITION.
- MATCH ADJACENT CEILING. CEILING SYSTEMS OR ANY COSNTRUCTION MUST ONLY BE ATTACHED TO
- DIMENSIONS ON THIS SHEET ARE FROM THE FACE OF FINISH.
- CONNECT TO (E) FIRE ALARM SYSTEM AS REQUIRED BY LOCAL AHU
- PROVIDE HOOD SUPPRESSION SYSTEM SEE MECH. DWGS
- 10. PROVIDE ACCESS PANELS AS NECESSARY WHERE ACCESS IS REQUIRED FOR FOOD SERVICE, MECHANICAL & ELECTRICAL EQUIPMENT

KEYED NOTES

NOTED THUS: (X)

- 1 EXISTING CEILING TO REMAIN, PROTECT FROM DAMAGE 2 NEW LAY IN TILE & T-GRID CEILING SYSTEM - SEE DETAILS ON THIS
- 3A NEW KITCHEN HOOD ALIGN WITH EDGE OF WALL OR PASS-THRU - O.F.C.I. - SEE MECH. DWGS
- 3B NEW KITCHEN HOOD, O.F.C.I SEE MECHANICAL DRAWINGS 4 NEW GYP. BOARD SOFFIT - SEE DETAIL 3/A11.1
- 5A LO-PRO SCRIPT WALL MOUNTED SIGNAGE MOUNTED ON FACE OF (E) SOFFIT ABOVE FRONT SERVING COUNTER, SEE INTERIOR ELEVATIONS ON A8.X SERIES DRAWINGS AND SPECS
- 6 SHELVING SUSPENDED FROM OVERHEAD, SEE VENDOR
- 7 OVERHEAD ELECTRICAL POWER BOX, SEE ELECTRICAL
- 8 6" PVC BEVERAGE CHASES, SEE VENDOR DRAWINGS 9 EXISTING SECURITY GRILL TO REMAIN
- 10 DIGITAL MENU BOARDS OWNER FURNISH SUPPLIER INSTALL -COORDINATE REQUIRED ELECTRIC WITH ELECTRICAL DRAWINGS
- 11 LAY IN LIGHT FIXTURE SEE ELECTRICAL DRAWINGS 12 STAINLESS STEEL CEILING TILE - EXTEND BEYOND 18" FROM
- 13 RECESSED CAN LIGHT SEE ELECTRICAL DRAWINGS
- 14 MECHANICAL GRILLE SEE MECHANICAL DRAWINGS 15 WALL MOUNTED HORN STROBE - SEE ELECTRICAL DRAWINGS
- 16 NEW WALL SYSTEM SEE AD1.1 FOR WALL TYPES 17 NEW 4" PVC BEVERAGE CHASES - COORDINATE ABOVE CEILING CONDUIT ROUTING WITH M/E/P EQUIPMENT & FIXTURES - SEE MECHANICAL DRAWINGS

CEILING TYPES

- INDICATES CEILING MATERIAL

INDICATES CEILING HEIGHT

ACT-1 ACOUSTICAL CEILING PANEL AND GRID



STAINLESS STEEL LAY IN CEILING PANEL

SYMBOL KEY

- RECESSED LIGHT FIXTURE LOCATED AS PER THIS SHEET -
- SEE ELECT. DWGS. FOR ADDITIONAL INFORMATION & SCOPE SURFACE MOUNTED OR SUSPENDED LIGHT FIXTURES - LOCATE → AS PER THIS SHEET - SEE ELECT. DWGS. FOR ADDITIONAL
- INFORMATION RECESSED CAN LIGHT - LOCATED AS PER THIS SHEET. SEE

ELECT. DWGS. FOR ADDITIONAL INFORMATION & SCOPE AIR DEVICES - LOCATE AS PER THIS SHEET - SEE MECHANICAL



RETURN - SEE MECHANICAL DRAWINGS

FIRE SPRINKLER - SEE MECHANICAL DRAWINGS



SUPPLY - SEE MECHANICAL DRAWINGS



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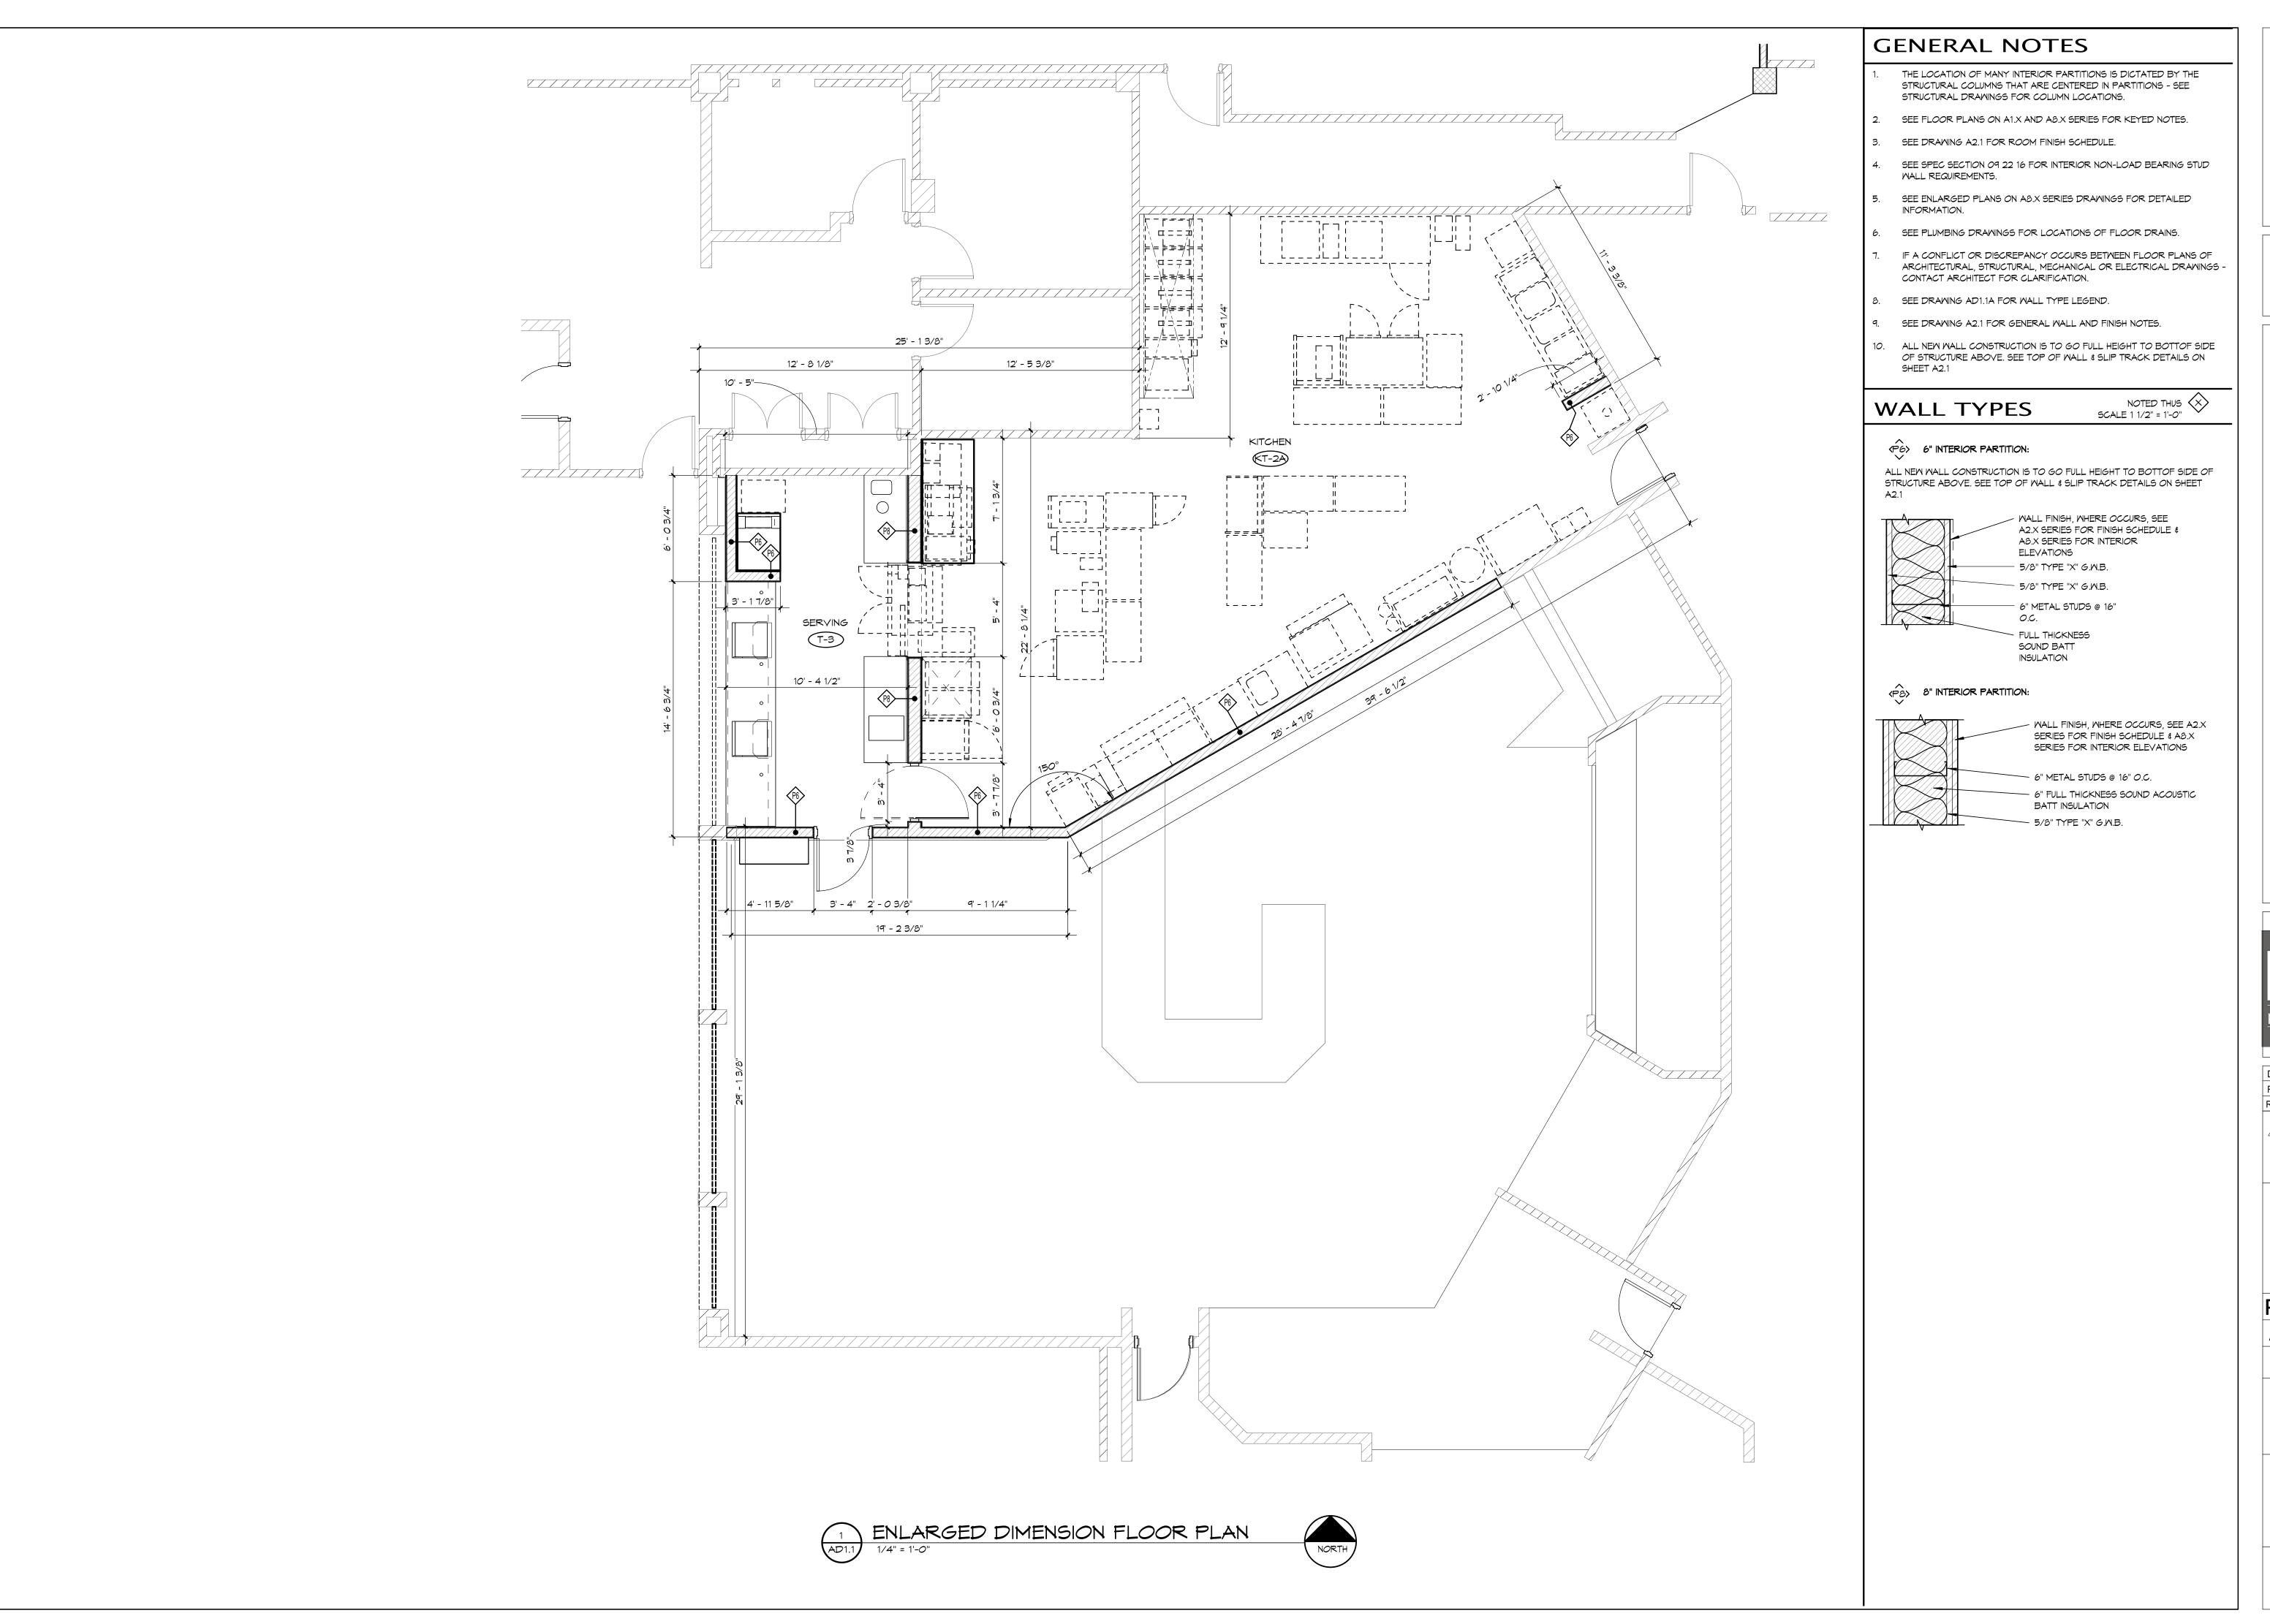
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CEILING PLANS SHEET







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SHEET TITLE
DIMENSION
FLOOR PLAN

FLOOR PLA SHEET

AD1.1

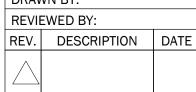PROPRIETARY EQUIPMENT SCHEDULE OWNER FURNISH OWNER INSTALL

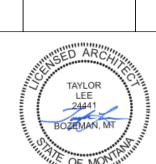Ö										ME	CHANICA	<u> </u>					
Ž		F					ELE	CTRICA	AL					PLU	MBING	_	
ITEM	DESCRIPTION	QUAN	MANUFACTURER	MODEL / PART NUMBER	VOLT	РН КУ	V AMI	Р Н	НР	NEMA RATING	HW	CW FW	FW2	IV	v DW	ROUGH-IN	REMARKS
952	CERTIFICATE HOLDER (2'X2')	1	FCC	CFA AMD25													
956	CFA CARES PANEL	1	FCC	H-CRS-001-L													
956A	CFA CARES DISPLAY	1	FCC	CFAAMD35													
957	PICK UP SIGN	1	FCC														

PROPRIETARY EQUIPMENT SCHEDULE OWNER FURNISH & VENDOR

CONTACT DIGITAL MENU BOARDS VENDOR LOCATED IN CHICK-FIL-A NATIONAL ACCOUNT SCHEDULE

o'	\succeq							MEC	HANICAL	L					
Ž	DESCRIPTION A MANUFACTURER				EL	ECTRICA	AL				P	LUMBING			
DESCRIPTION	MANUFACTURER O	MODEL / PART NUMBER	VOLT	РН И	KW A	AMP HE	IP PL	JG NEMA RATING	HW C	CW FW	FW2	IW DV	w	ROUGH-IN	REMARKS
672F DIGITAL MENU BOARDS (32" DIAGONAL)**	4 CINEPLEX DIGITAL MEDIA		120)								
672MA DIGITAL MENU BOARDS MOUNT	1 CINEPLEX DIGITAL MEDIA														
672MB DIGITAL MENU BOARDS PLAYER	1 CINEPLEX DIGITAL MEDIA		120												
CASH REGISTER TERMINALS AND ORDER MONITORS MUST (COMMUNICATE IN (DYNAMIC ROUTING) REAL TIME.														NATIONAL PRICING: http://www.lavi.com/chick-fil-a/login.aspx

PROPRIETARY EQUIPMENT SCHEDULE CONTRACTOR FURNISH & CONTRACTOR INSTALL

CONTACT CFA LICENSING TEAM AT (800) 304-0849 OPTION 3 OR CFALICENSING@STRATEGICEQUIPMENT.COM AT TRIMARK STRATEGIC TO ORDER EQUIPMENT - SOME EQUIPMENT HAS A 6 WEEK LEAD TIME

5								N	ECHA	NICAL						
	DESCRIPTION SUPPLIER MODEL / PART NUMBER	ELECTRICAL PLUMBING											NG			
DESCRIPTION		VOLT	PH	KW	AMP	DIRECT	NEMA RATING	HW	cw	FW	FW2	IW	DW	ROUGH-IN	REMARKS	
36" CFA HERITAGE SCRIPT SIGN LOW PROFILE - ILLUMINATED INTERIOR	1 CLAYTON SIGNS	36A1	120	1		2.0	Х									SCRIPT TO BE CIRCUITED IN SERIES, JUNCTION BOX TO BE CONNECTED TO LIGHT SWITCH AT SERVING AREA OR BOH AREA.





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BOZEMAN, MT

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BRANDING PLAN
& SCHEDULE

SHEET


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SHEET TITLE
KITCHEN EQUIP.
PLAN

SHEET
K1.1

EQUIPMENT SCHEDULE CONTRACTOR FURNISHED, CONTRACTOR INSTALLED

IF CLAYTON FIXTURE IS PROVIDING ALL THE MILL WORK IN THE MILL WORK PACKAGE. PLEASE CONTACT DONALD WILSON AT CLAYTON FIXTURE (404) 363-1665 - DONALD WILSON@ACCESSCEA COM - IF NOT. CONTACT THE CONTRACTED MILL WORK PROVIDER.

	>						MECH	IANICAL	-					
					ELECTI	RICAL					PLUMB	NG		
ITEM NO.	DESCRIPTION OF EQUIPMENT	APPROVED MANUFACTURER	VOLT	PH KW	AMP	HP	NEMA-RATING	HW	CW FW	FW2	IW	DW	ROUGH-IN	E REMARKS
101	1 FRONT SERVING COUNTER	G.C./MILLWORK MANUFACTURER		-	-									101 REFER TO MANUFACTURER SHOP DRAWINGS
103	17 DOUBLE WALL PAPER CUP DISPENSER	SAN JAMAR MODEL #C2410C												103
106	1 DESSERT COUNTER	G.C./MILLWORK MANUFACTURER		-	-									106 REFER TO MANUFACTURER SHOP DRAWINGS
108	1 BACK SERVING COUNTER	G.C./MILLWORK MANUFACTURER		-	-									108 REFER TO MANUFACTURER SHOP DRAWINGS
110	1 BACK SERVING COUNTER	G.C./MILLWORK MANUFACTURER		-	-									110 REFER TO MANUFACTURER SHOP DRAWINGS
111	1 STAINLESS STEEL UNDER MOUNT HAND SINK	VOLLRATH MODEL #10101-1										2"		111
120	1 PRIMARY BOARDS COUNTER	G.C./MILLWORK MANUFACTURER		-	-									120 REFER TO MANUFACTURER SHOP DRAWINGS
120a	2 BUILT-IN BREAD RACK SLIDES	G.C./MILLWORK MANUFACTURER		_	_									120a INCLUIDE 2 BRACKETS PER SET: REFER TO MANUFACTURER SHOP DRAWINGS

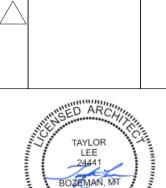EQUIPMENT SCHEDULE OWNER FURNISHED, CONTRACTOR INSTALLED

	≥					MECH	IANIC/	AL						
					ELECTRI	CAL				PLUMBING	3		<u> </u>	
	کے ا												- {	
ITEM NO.	DESCRIPTION OF EQUIPMENT	APPROVED MANUFACTURER	VOLT PH	KW	AMP	HP NEMA-RATING	HW	CW	FW F	W2 IW C	ow	ROUGH-IN	ITEM	REMARKS
150	2 BREAD RACK	LOCAL SUPPLIER											150	
180	4 ORDER REGISTER	GC/FSP VENDOR	120 1		0.70	5-20P							180	
181	4 CASH DRAWER	GC/FSP VENDOR											181	
182	5 RECEIPT PRINTER	GC/FSP VENDOR	120 1		1.80	5-20P							182	PROVIDE WITH 120V/24V POWER SUPPLY ADAPTER FOR USE WITH 120V IG OUTLET
182L	3 LABEL PRINTER	GC/FSP VENDOR	120 1		1.7	5-20P							182L	PROVIDED WITH 120V/24V POWER SUPPLY ADAPTER FOR USE WITH 120V IG OUTLET
183	7 ORDER MONITOR	GC/FSP VENDOR	120 1		0.10	5-20P							183	
183a	6 RADIAL ARM	GC/FSP VENDOR											183a	USED TO MOUNT ORDER MONITORS - NOT SHOWN ON PLAN
183b	1 MONITOR MOUNTING POLE	GC/FSP VENDOR											183b	
202	3 UNDER-COUNTER SLIM JIM TRASH CAN	RUBBERMAID MODEL #FG354060GRAY											202	
202A	2 UNDER-COUNTER SLIM JIM TRASH CAN	RUBBERMAID MODEL #1971258											202A	
206	3 SOAP DISPENSER	ECOLAB MODEL #92211379												RE: ARCHITECTURAL SHEETS FOR DETAILS ON MOUNTING HEIGHTS AND LOCATIONS
210	1 INGREDIENT BIN	RUBBERMAID MODEL #3602-88											210	
211B	1 FLY SYSTEM	GC/FSP VENDOR	120 1	0.017		5-15P								CLOCK STYLE RECEPTACLE REQUIRED
220	1 COAT RACK	SAFCO MODEL #4162-24in											220	
225	1 FAT VAT	PITCO FRIALATOR MODEL FAT VAT											225	
260	1 42" VENT HOOD	HALTON HOODS		-	_								_	HOOD SHROUD BY VENT HOOD MANUFACTURER; REFER TO SHOP DRAWINGS
266	1 126" VENT HOOD	HALTON HOODS		-	-									HOOD SHROUD BY VENT HOOD MANUFACTURER; REFER TO SHOP DRAWINGS
269	1 ANSUL FIRE SUPPRESSION SYSTEM	HALTON HOODS	120 1			DIRECT CONNECTION								REFER TO MANUFACTURER SHOP DRAWINGS
270	1 ANSUL FIRE SUPPRESSION SYSTEM	HALTON HOODS	120 1			DIRECT CONNECTION								REFER TO MANUFACTURER SHOP DRAWINGS
308e	1 SYRUP RACK	MONIN MODEL #P573	120 1			BINEOT CONNECTION							308e	The Extremination of the Extreme Browning
	3 10-HEAD BEVERAGE TOWER	GC/FSP VENDOR	115 1		10.00	5-15P/5-15P				3/4"				PROVIDED WITH (2) CORDS AND PLUGS PER TOWER
316	2 CO2 TANK	GC/FSP VENDOR	110		10.00	3-13173-131				3/4				ORDER WITH WS1.25TC CONTROLLER; FLOOR DRAIN REQUIRED
317A	1 BEVERAGE RACK SYSTEM (6 SHELF - 3 WIDE)	GC/FSP VENDOR											317A	ONDER WITH WOLLD GONT ROLLERS, TEOGRAPH WITH NEW
	1 8-STOP WATER MANIFOLD PANEL	GC/FSP VENDOR							3/4"			P-28		RE: PLUMBING SHEETS FOR DETAILS
320	3 TURBO CARBONATOR	GC/FSP VENDOR	115 1		6.2	5-20P			5/4			1 -20		ORDER (8) #44231, (3) #44233, (8) DR. PEPPER PUMPS, & (3) #T5274SN-01
355F	1 FAUCET FOR DECK MOUNTED HAND SINK	T&S MODEL #B-0328-CR-VF05	110		0.2	3-201	1/2"	1/2"				P-6	355F	ONDEN (6) #44231, (3) #44230, (6) BIN 1 ELY BIN 10, & (3) #132140N-01
359	2 WALL MOUNTED SPLASH GUARD	GC/FSP VENDOR					1/2	1/2				F-0		SEE DETAILS PAGE K-901 FOR TYP.
360	1 HAND SINK	EAGLE MODEL #HSAN-10									2"	P-5		SEE DETAILS PAGE K-901 FOR TYP. SEE DETAILS PAGE K-901 FOR TYP.
360E	1 EMERGENCY EYEWASH STATION	ACORN MODEL #S0660-RH									2	P-42		TO BE MOUNTED TO WALL BETWEEN 33 IN AND 45 IN AFF
360F	1 FAUCET FOR WALL MOUNTED HAND SINK	T&S MODEL #B-1146-CFA-VF05					1/2"	1/2"				P-5	360E	TO BE MOUNTED TO WALL BETWEEN 33 IN AND 43 IN AFF
360Fe		TOTO MODEL #TEL165-C20E#CP						1/2"				P-5	360Fe	
364	1 SENSOR FAUCET FOR WALL MOUNTED HAND SINK 1 3 COMPARTMENT UTENSIL SINK						1/2	1/2		4.4/0"		P-0		
		EAGLE MODEL #314-18-3-18								1 1/2"				SEE DETAILS PAGE K-901 FOR TYP.
364a	1 3 COMPARTMENT SINK CHEMICAL DISPENSER	SOLIDSENSE					4/0"	4/0"				D.0	364a	
364DF	1 FAUCETS FOR UTENSIL SINK	T&S MODEL #B-0152-14-CRBC					1/2	1/2"		4.4/0"		P-9	364DF	CEE DETAILS DAGE K 004 FOR TVD
366	1 SINGLE BOWL VEGETABLE PREP SINK	EAGLE MODEL #314-16-1-18L								1 1/2"				SEE DETAILS PAGE K-901 FOR TYP.
	1 VEGETABLE WASH DISPENSER	ECOLAB					1/0"	1/0"				D 0	366a	
	1 FAUCETS FOR VEGETABLE PREP SINK	T&S BRASS MODEL #B-0154-CR-C					1/2"	1/2"	1/0"			P-8	366F	
	1 FILTERED WATER FAUCET (WALL MOUNTED)	T&S MODEL #B-0236-CR-063X					4 (0"	1/0"	1/2"			(2) P-30	367FW	
370	1 MOP SINK FAUCET	GC/FSP VENDOR					1/2"	1/2"				P-7	370	
370a	1 MOP SINK CHEMICAL DISPENSER	SOLIDSENSE					4 (0)	4/0"		0"		(0) D 7	370a	
370B	1 MOP SINK	GC/FSP VENDOR					1/2"	1/2"		3"		(2) P-7	370B	
651	1 LOCKERS	GC/FSP VENDOR						+						2 TIERS, 12 OPENINGS
	3 PAPER TOWEL DISPENSER	SAN JAMAR #T1490TBK												RE: ARCHITECTURAL SHEETS FOR DETAILS ON MOUNTING HEIGHTS AND LOCATIONS
661	1 MOP RACK	GC/FSP VENDOR											661	
	1 TRASH CART WITH LID	GC/FSP VENDOR											665A	
	1 SAFE	AMERICAN SECURITY PRODUCTS MODEL #9336356	125		1.5 -									DIGITAL KEYPAD OUTER DOOR HINGE RIGHT
672	4 MENU BOARD	CINEPLEX	120 0	-	12.5	5-20P							672	REFER TO MANUFACTURER SHOP DRAWINGS






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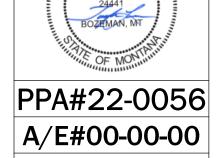


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CFA KITCHEN EQIP. SCHED.

SHEET

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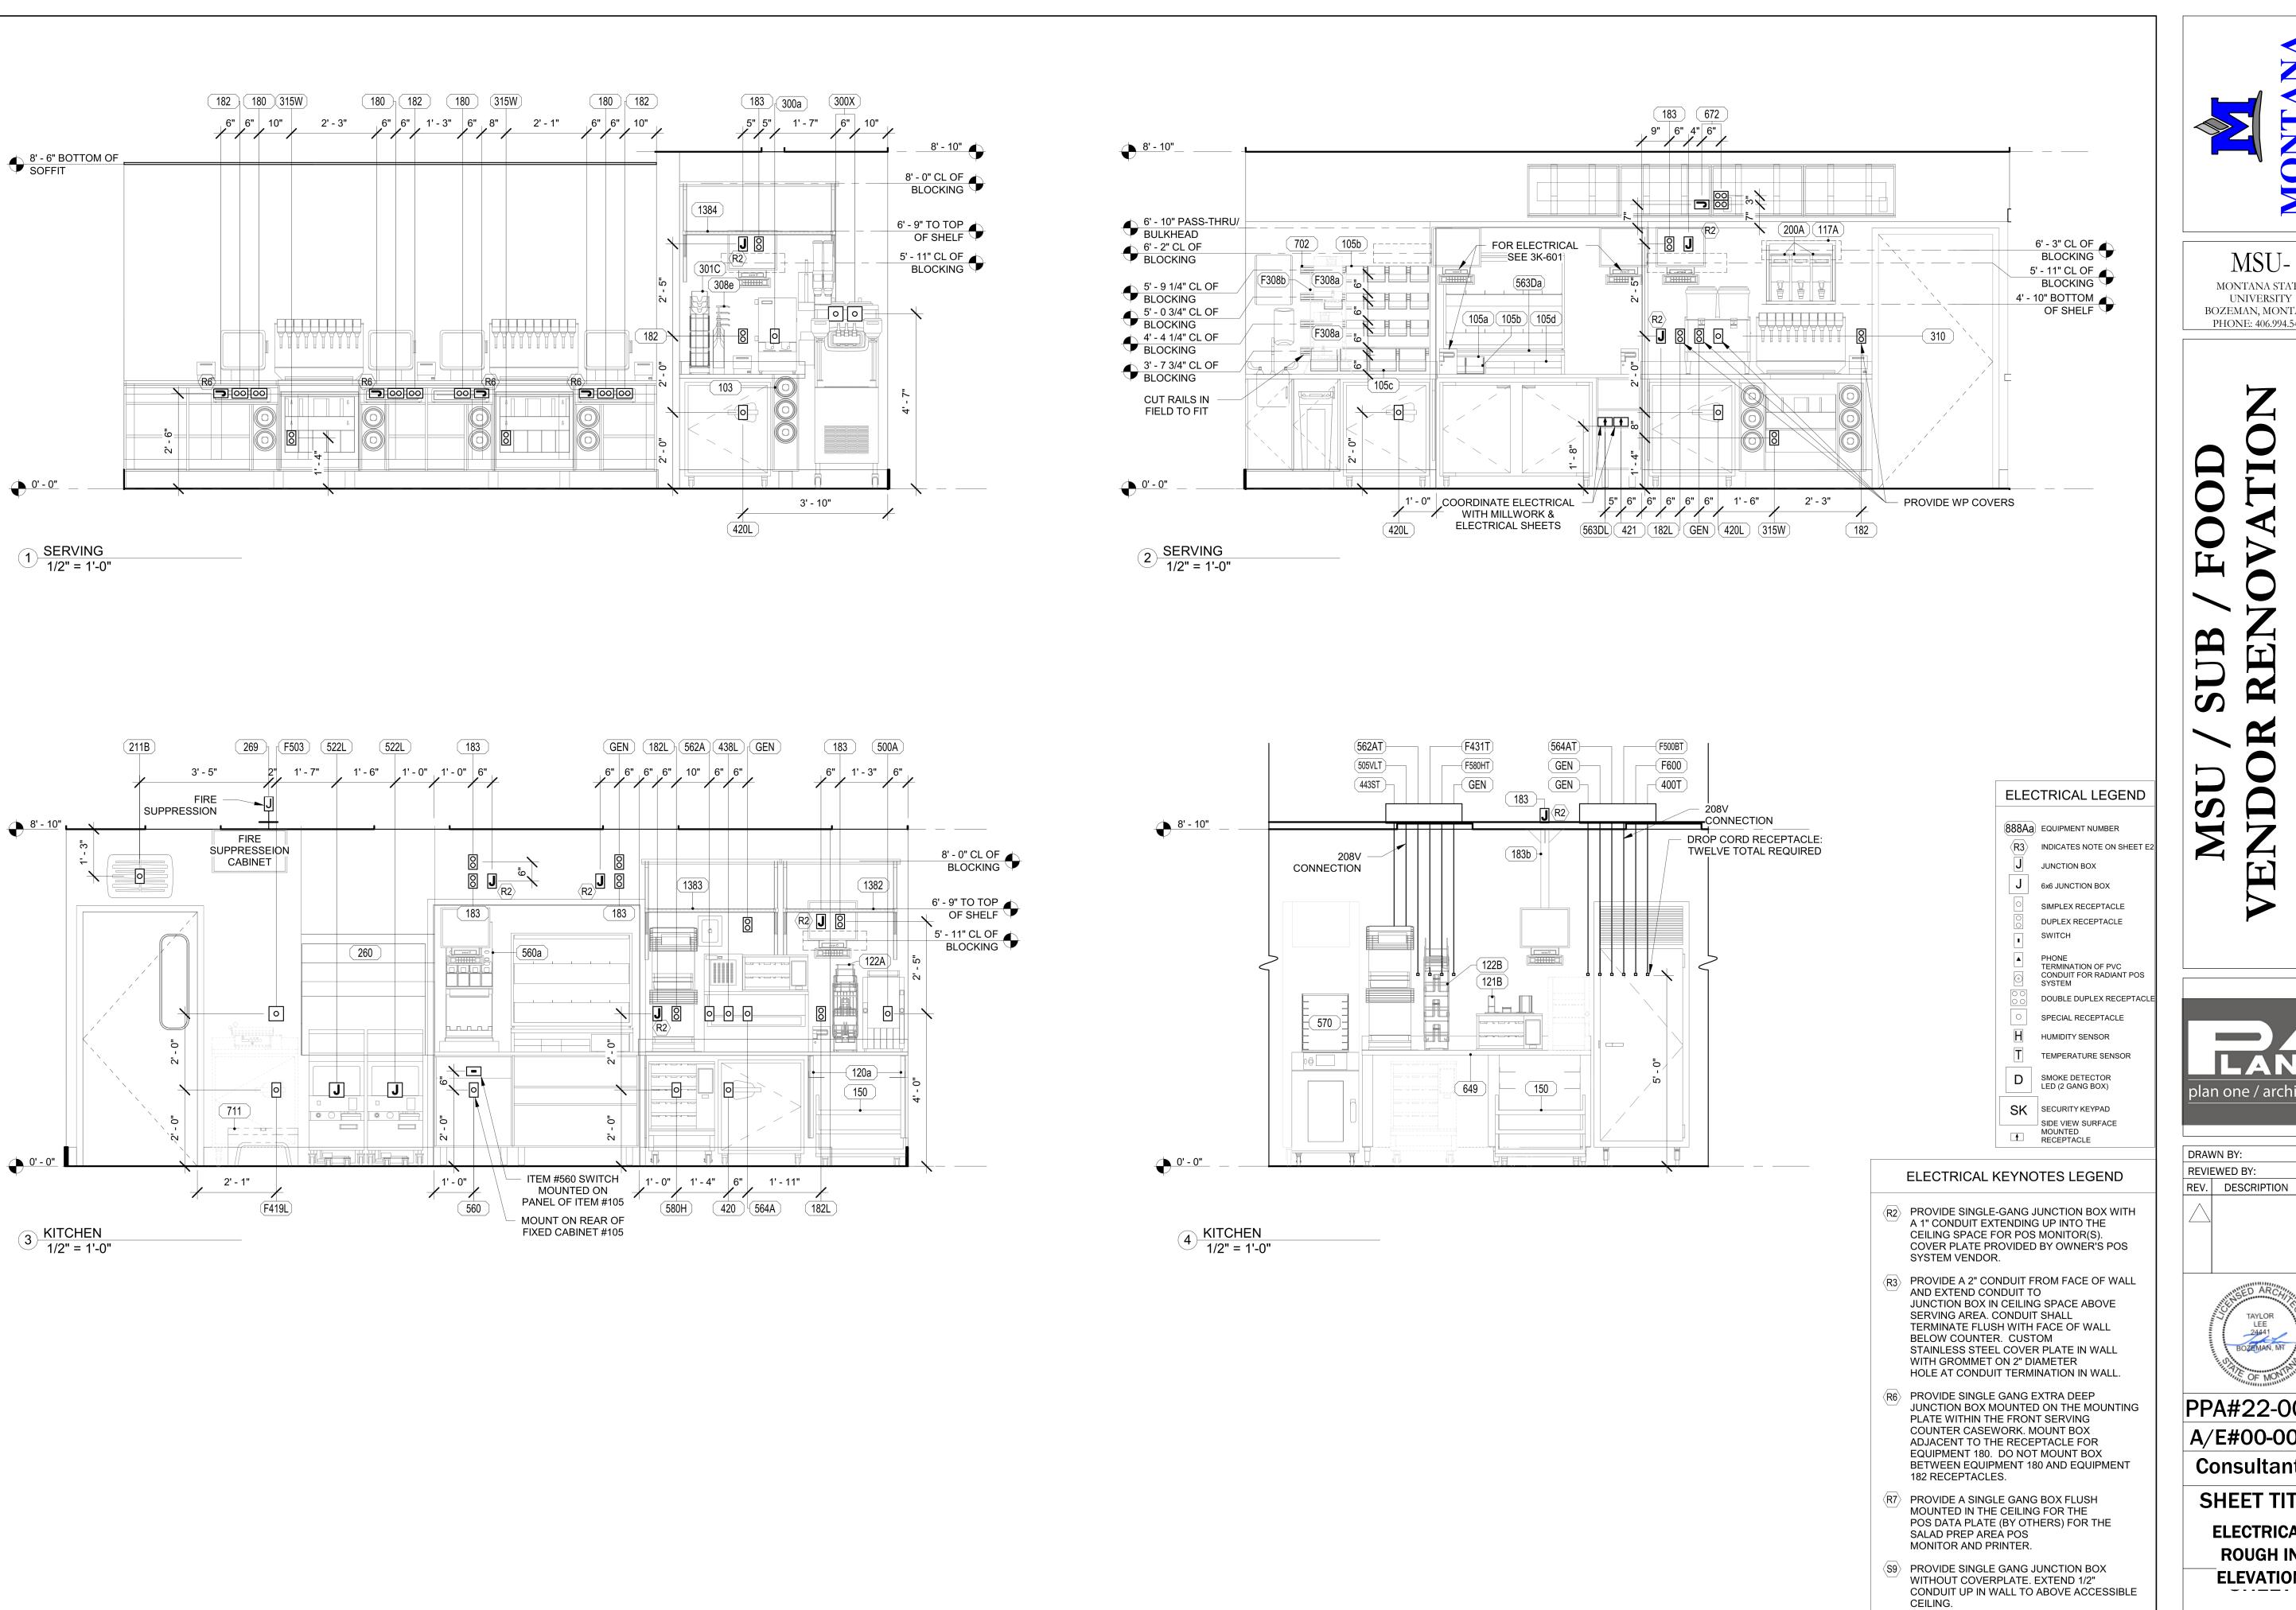
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CFA KITCHEN EQIP. SCHED. 2

SHEET **K2.2**

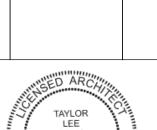

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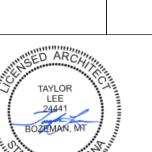
* KEYNOTE INFORMATION PER PROTOTYPE E-SHEET STANDARDS

- ANSUL DETAILS

REFER TO K-901 & K-904 FOR: - SHELVING INSTALLATION AND MOUNTING DETAILS - OEP DETAILS - DIRECT CONNECTION - ISLAND LOCATION - WATER FILTRATION DETAILS




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SHEET TITLE **ELECTRICAL ROUGH IN**

ELEVATION



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SHEET TITLE **ELECTRICAL ROUGH IN**

ELEVATION K8.2
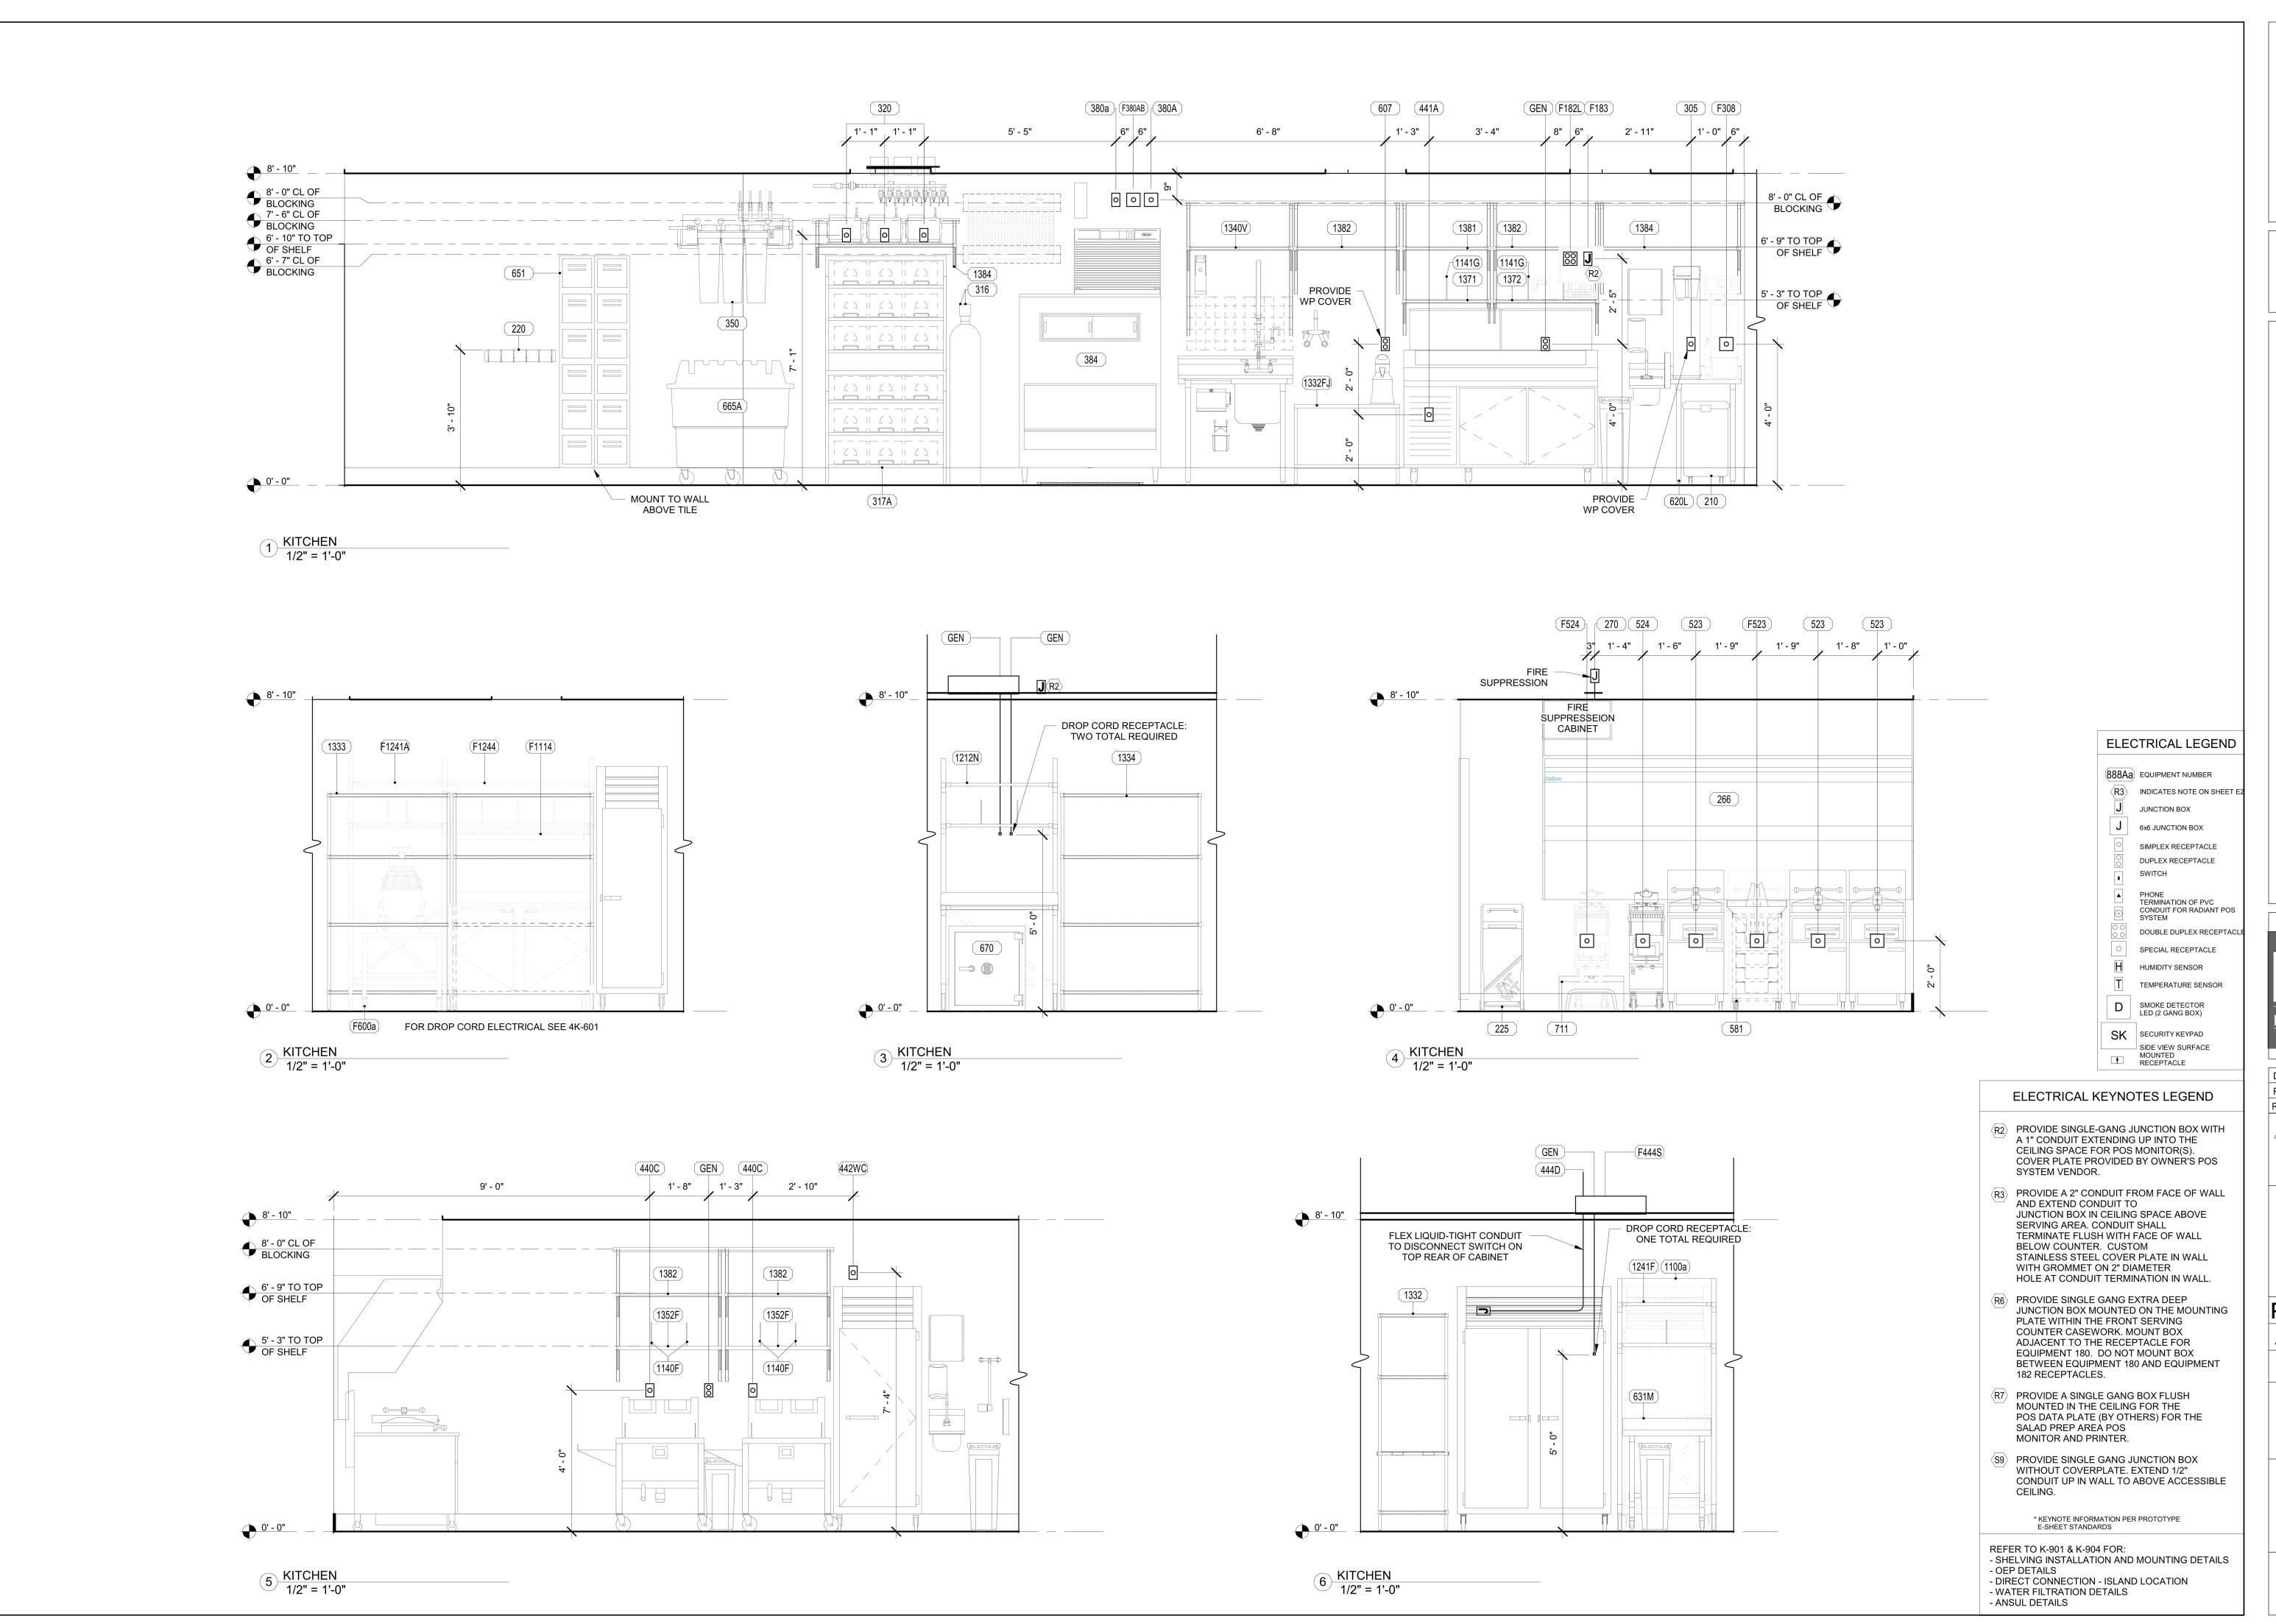
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SUB

16' - 6"

WALL MOUNTED P-24 P-24 SPLASH GUARD 360F

9' - 1"

2 KITCHEN - PLUMBING 1/2" = 1'-0"


KITCHEN - PLUMBING

′ 1/2" = 1'-0"

BEVERAGE INSTALLER TO LOCATE CARBONATOR SHELF, WATER MANIFOLD, AND 6" PVC SLEEVE PENETRATIONS

6" PVC SLEEVE

CAULKED TO CEILING TILE

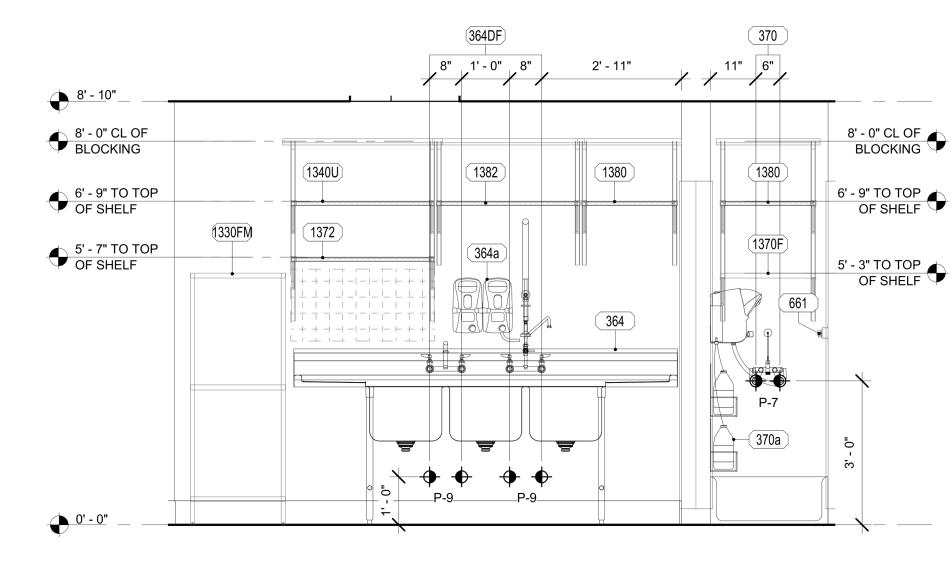

F380AB (380A)

6' - 2"

5' - 1"

PLUMBING LEGEND

EQUIPMENT NUMBER HOT WATER **COLD WATER**

FILTERED WATER (FW) FILTERED WATER (FW2

• GAS

REFER TO K-901 & K-902 FOR: - SHELVING INSTALLATION AND MOUNTING DETAILS - OEP DETAILS - DIRECT CONNECTION - ISLAND LOCATION - WATER FILTRATION DETAILS

- PLUMBING KEYNOTES LEGEND P-5 KITCHEN HAND SINK ROUGH IN: (SINK AND FAUCET WITH 1.0 GPM AERATORFURNISHED BY OWNER) CONTRACTOR SHALL INSTALL WALL HUNG, STAINLESSSTEEL SINK AND FAUCET SET AND MAKE FINAL CONNECTIONS. PROVIDEMCGUIRE LF175 SUPPLIES WITH STOPS AND A MCGUIRE 8912 POLISHED CHROMEP-TRAP. ADJUST FAUCET OUTLET TEMPERATURE TO 100 DEGREES F (OR HIGHERAS REQUIRED BY LOCAL
- JURISDICTION). P-6 SERVING COUNTER DROP IN SINK ROUGH IN: (SINK AND FAUCET WITH 1.0 GPMAERATOR FURNISHED BY OWNER) CONTRACTOR SHALL INSTALL SINK ANDFAUCET SET AND MAKE FINAL CONNECTIONS. PROVIDE MCGUIRE 8912 POLISHEDCHROME P-TRAP AND MCGUIRE LF175 STOPS WITH 20" CHROME PLATED 3/8"COPPER RISERS. ADJUST FAUCET OUTLET TEMPERATURE TO 100 DEGREES F(OR HIGHER AS
- REQUIRED BY LOCAL JURISDICTION). P-7 MOP SINK FAUCET: (MOP SINK BASIN BUILT BY GENERAL CONTRACTOR) PROVIDET&S BRASS MODEL B-2345 FAUCET WITH CERAMA SPRING CHECK VALVECARTRIDGES, HOSE THREAD SPOUT OUTLET, TOP BRACE, ADJUSTABLE INLETSPREAD FROM 3" TOP 8". INCLUDE T&S BRASS MODEL 43-072 HOSE THREAD X 3/4"FEMALE NPT CHROME ADAPTOR.
- NO SUBSTITUTIONS. SEE ALSO P-16. P-8 VEGETABLE PREP SINK ROUGH-IN: (SINK AND FAUCET WITH 0.65 GPM SPRAYHEAD FURNISHED BY OWNER) CONTRACTOR SHALL INSTALL SINK AND MAKEFINAL CONNECTIONS. PROVIDE MCGUIRE LFST08 STOPS AND BRASSCRAFT 36"CHROME PLATED 1/2" OD COPPER RISERS MODEL 3-36AC, ASSEMBLE AND MOUNTTWO HANDLE FAUCET WITH PRE-RINSE SPRAY ARM. INSTALL ADD-ON FAUCETWITH 15" SPOUT AT BASE OF PRE-RINSE RISER. SEE K-SHEET ELEVATIONS.PROVIDE 1-1/2" SCHED 80 PVC (PIPE AND FITTINGS) INDIRECT WASTE MANIFOLDFROM SINK BASIN TO FLOOR SINK P-13B, NO P-TRAP REQUIRED. INSTALLCLEANOUT AT TURN.

PLUMBING KEYNOTES LEGEND

- ANSUL DETAILS

- THREE OR FOUR COMPARTMENT POT SINK ROUGH-IN: (SINK AND FAUCETS WITH 0.65 GPMSPRAY HEAD FURNISHED BY OWNER) CONTRACTOR SHALL INSTALL SINK, ASSEMBLE & MOUNT TWO FAUCETS. AND MAKE FINAL CONNECTIONS. PROVIDEMCGUIRE LFST08 STOPS AND BRASSCRAFT 36" CHROME PLATED 1/2" OD COPPERRISERS MODEL 3-36AC,. ASSEMBLE AND MOUNT ONE TWO-HANDLE FAUCET WITHPRE-RINSE SPRAY. INSTALL ADD-ON FAUCET WITH 18" SPOUT AT BASE OFPRE-RINSE RISER. ASSEMBLE AND MOUNT ONE TWO-HANDLE FAUCET WITHDOUBLE JOINT SPOUT ON OPPOSITE SIDE. SEE K-SHEET ELEVATIONS FORFAUCET LOCATIONS. PROVIDE 1-1/2" SCHED 80 PVC (PIPE AND FITTINGS)INDIRECT WASTE MANIFOLD FROM EACH SINK BASIN TO FLOOR SINK P-13A, NOP-TRAPS REQUIRED. PROVIDE CLEANOUT AT EACH
- UTILITY CONNECTION (ICEMAKER): PROVIDE A MCGUIRE MODEL LFHST06SBLEAD-FREE CHROME WHEEL ANGLE STOP, 1/2" FIP INLET AND OUTLET. PROVIDECHROME WALL ESCUTCHEON. INSTALL WITH BFP P-34. SEE DETAIL 3/P-201
- FORPIPING AT ICE MAKERS. UTILITY CONNECTION (COFFEE & TEA BREWERS): PROVIDE A MCGUIRE MODELLFHST06SB LEAD-FREE CHROME WHEEL ANGLE STOP, 1/2" FIP INLET ANDOUTLET. PROVIDE CHROME
- WALL ESCUTCHEON. INSTALL WITH BFP P-34. BALL VALVE: NIBCO MODEL 4660-T, 3/4", WITH IPS INLET AND
- OUTLET. FILTERED WATER FAUCET: (FAUCET PROVIDED BY OWNER) TWO-HANDLE WALLMOUNT FAUCET WITH SWING SPOUT. MOUNT ON WALL AS SHOWN ON K-SHEETS.PIPE FILTERED WATER TO BOTH SIDES OF FAUCET. CONNECT TO SUPPLY PIPINGWITH BRASS OR CHROME NIPPLES; GALVANIZED NOT
- ALLOWED. P-42 EMERGENCY THERMOSTATIC MIXING VALVE (EMERGENCY EYEWASH): BRADLEY MODEL S19-2000 EFX8 THERMOSTATIC TEMPERING VALVE (PROVIDED BY HJC). ANSI Z358.1 CERTIFIED FOR EMERGENCY FIXTURES, ASSE 1071 COMPLIANT, WITH DIAL THERMOMETER, INLET CHECK STOPS, ADJUSTABLE SETPOINT, ACCURATE WITHIN +/- 3 DEG F. INCLUDES INTEGRAL COLD WATER BYPASS WITH POSITIVE HOT WATER SHUT-OFF WHEN COLD WATER SUPPLY IS LOST. FACTORY SETPOINT

OF 85 DEG F. MOUNTING BRACKET INCLUDED. FACTORY ASSEMBLED AND TESTED. ROUGH BRASS FINISH. NO SUBSTITUTIONS. CONTACT CHICK-FIL-A NATIONAL ACCOUNTS AT HAYNES, JONES & CADBURY FOR PRICING AND DELIVERY.

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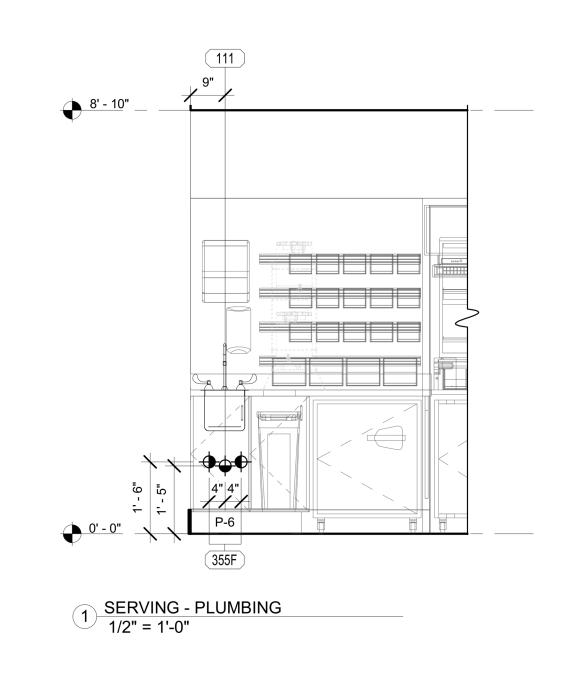
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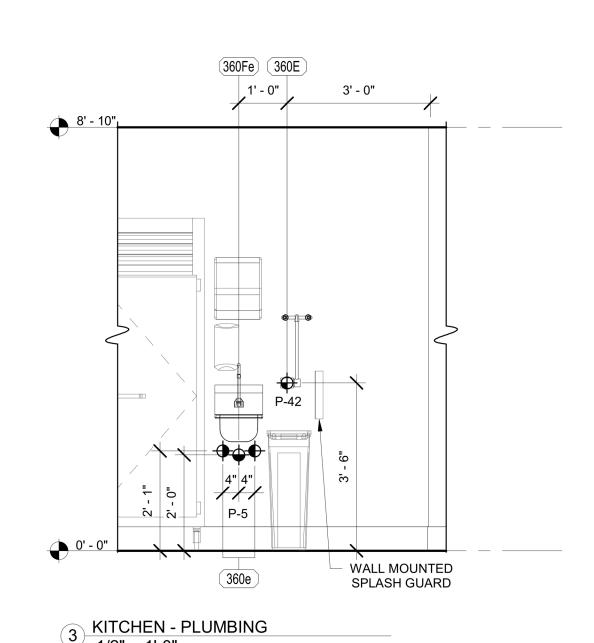
Consultant #: **SHEET TITLE**

PLUMBING ROUGH IN


ELEVATION

16.06.2023





1/2" = 1'-0"

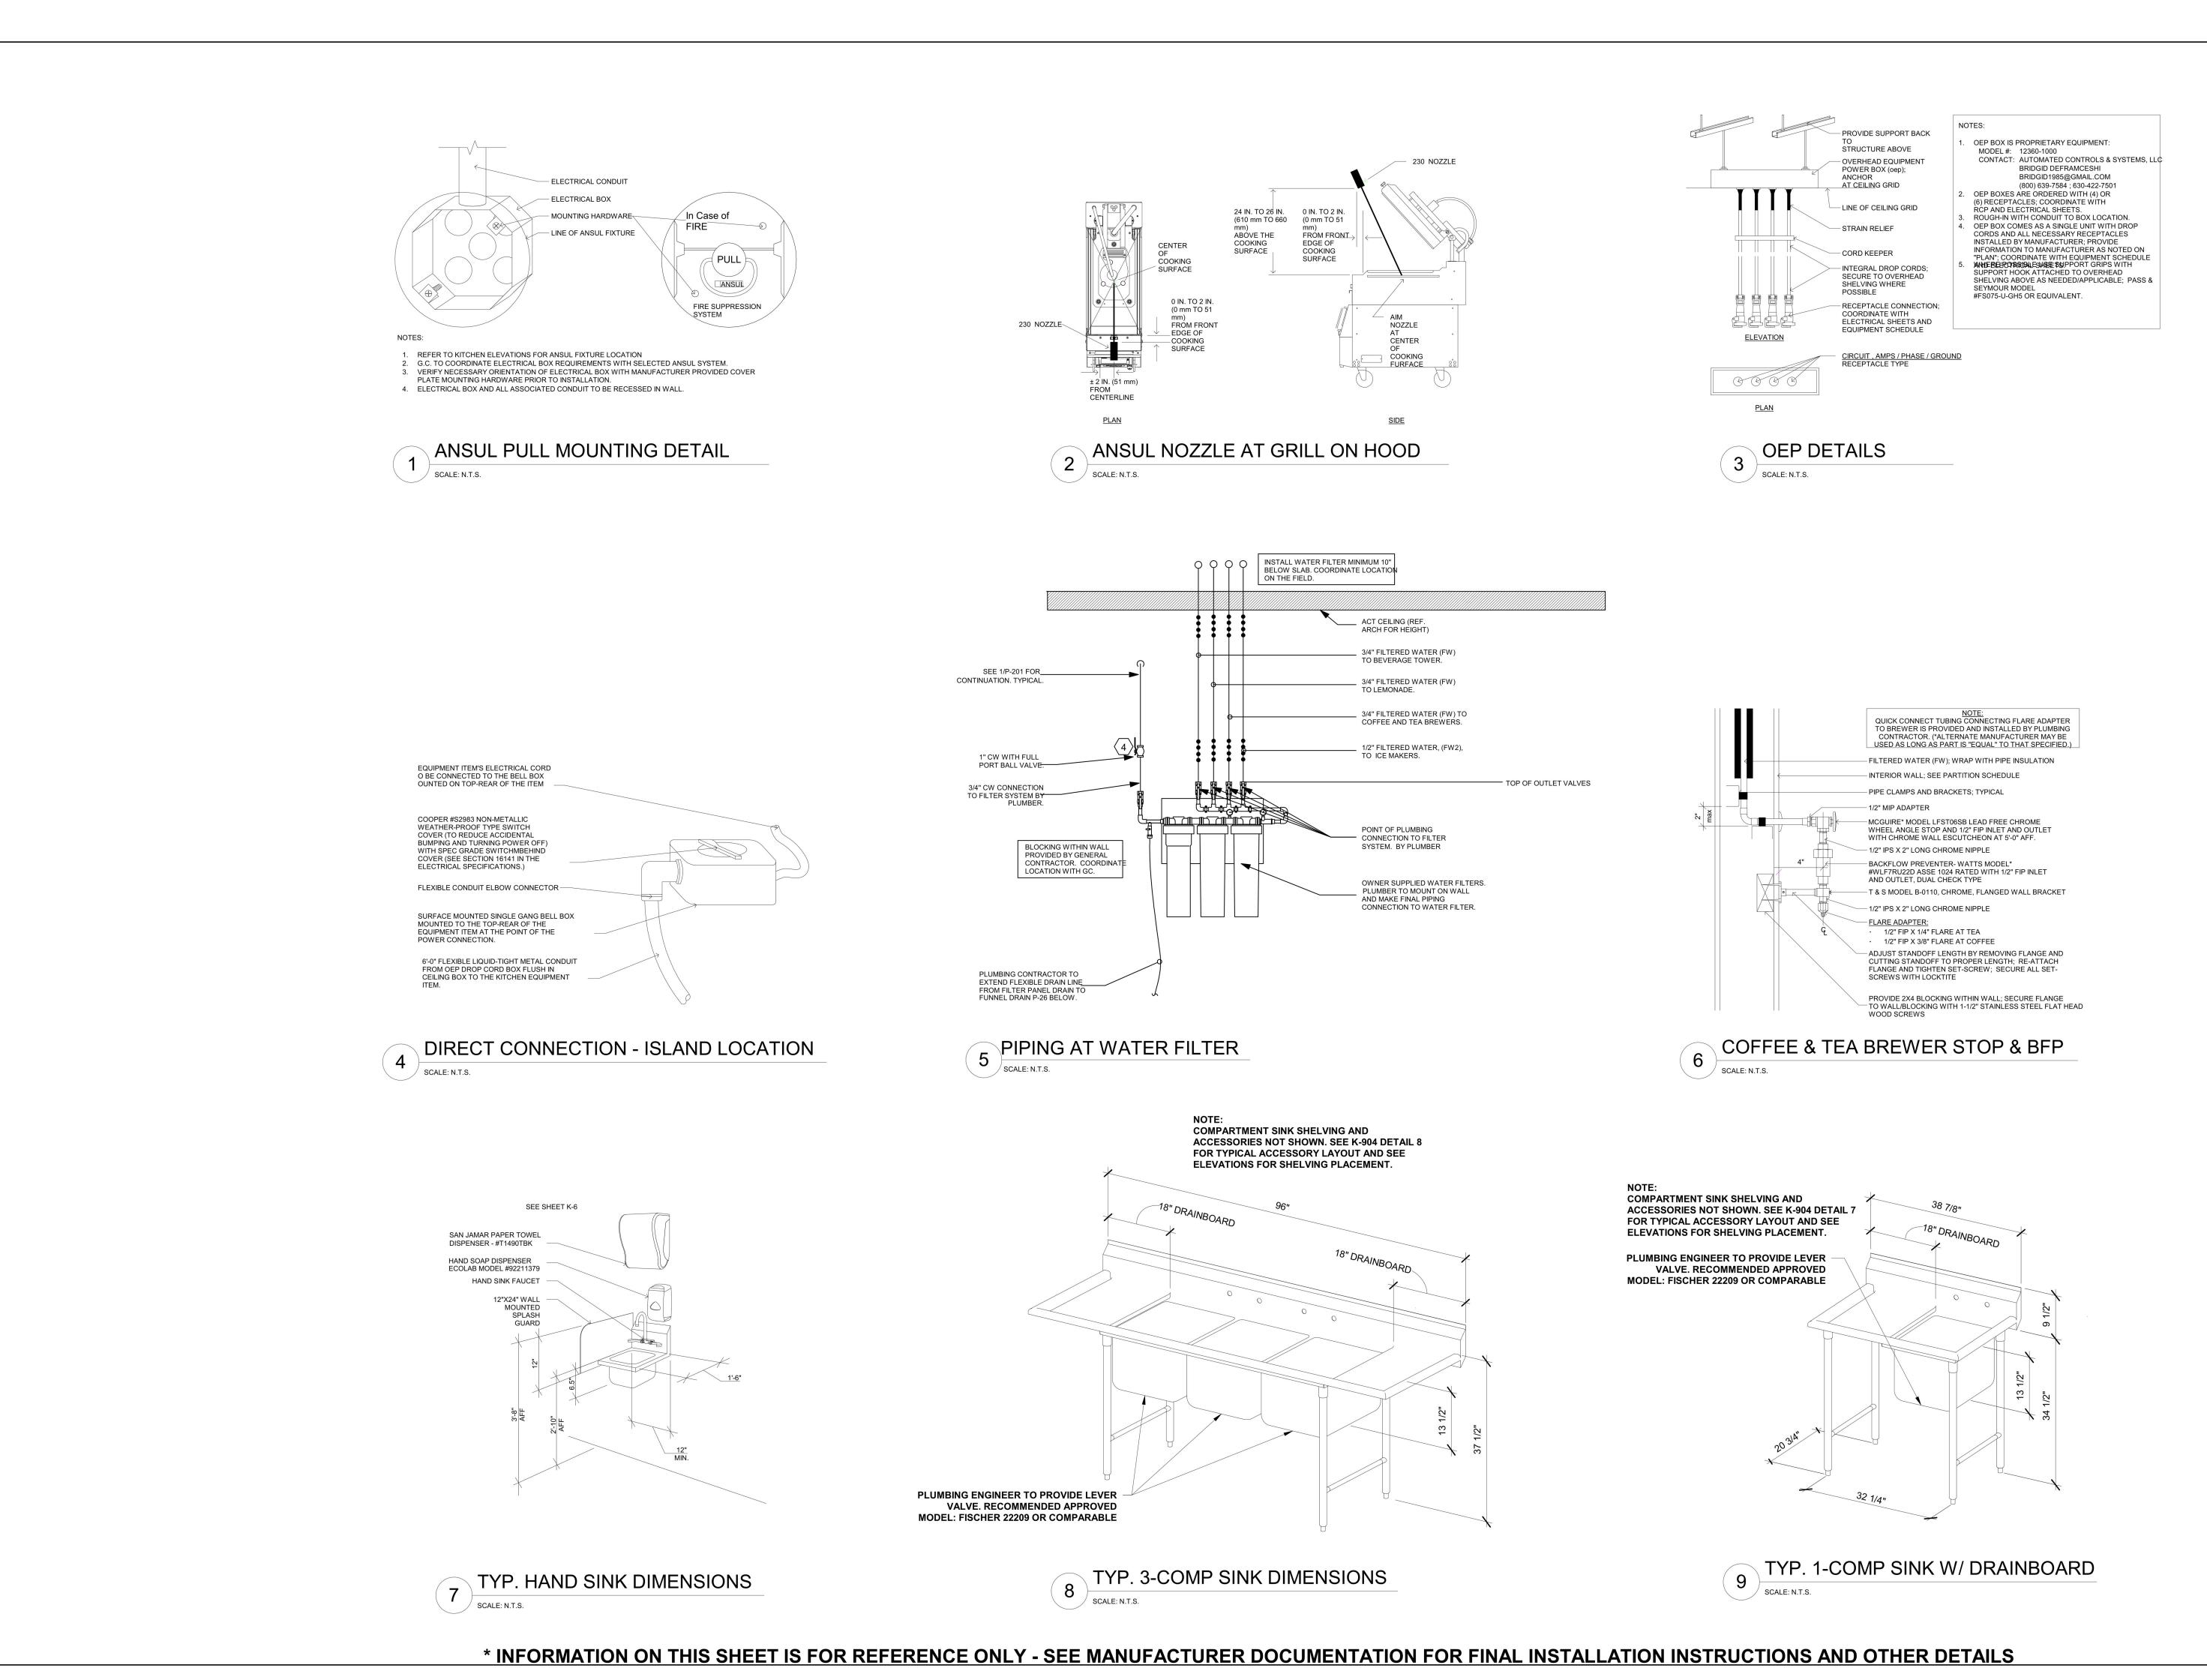



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PHONE: 406.994.5413

K8.4

16.06.2023

DRAWN BY:

REVIEWED BY:

REV. DESCRIPTION DATE

PPA#22-0056

A/E#00-00-00


Consultant #:

SHEET TITLE

KITCHEN

DETAILS

SHEET

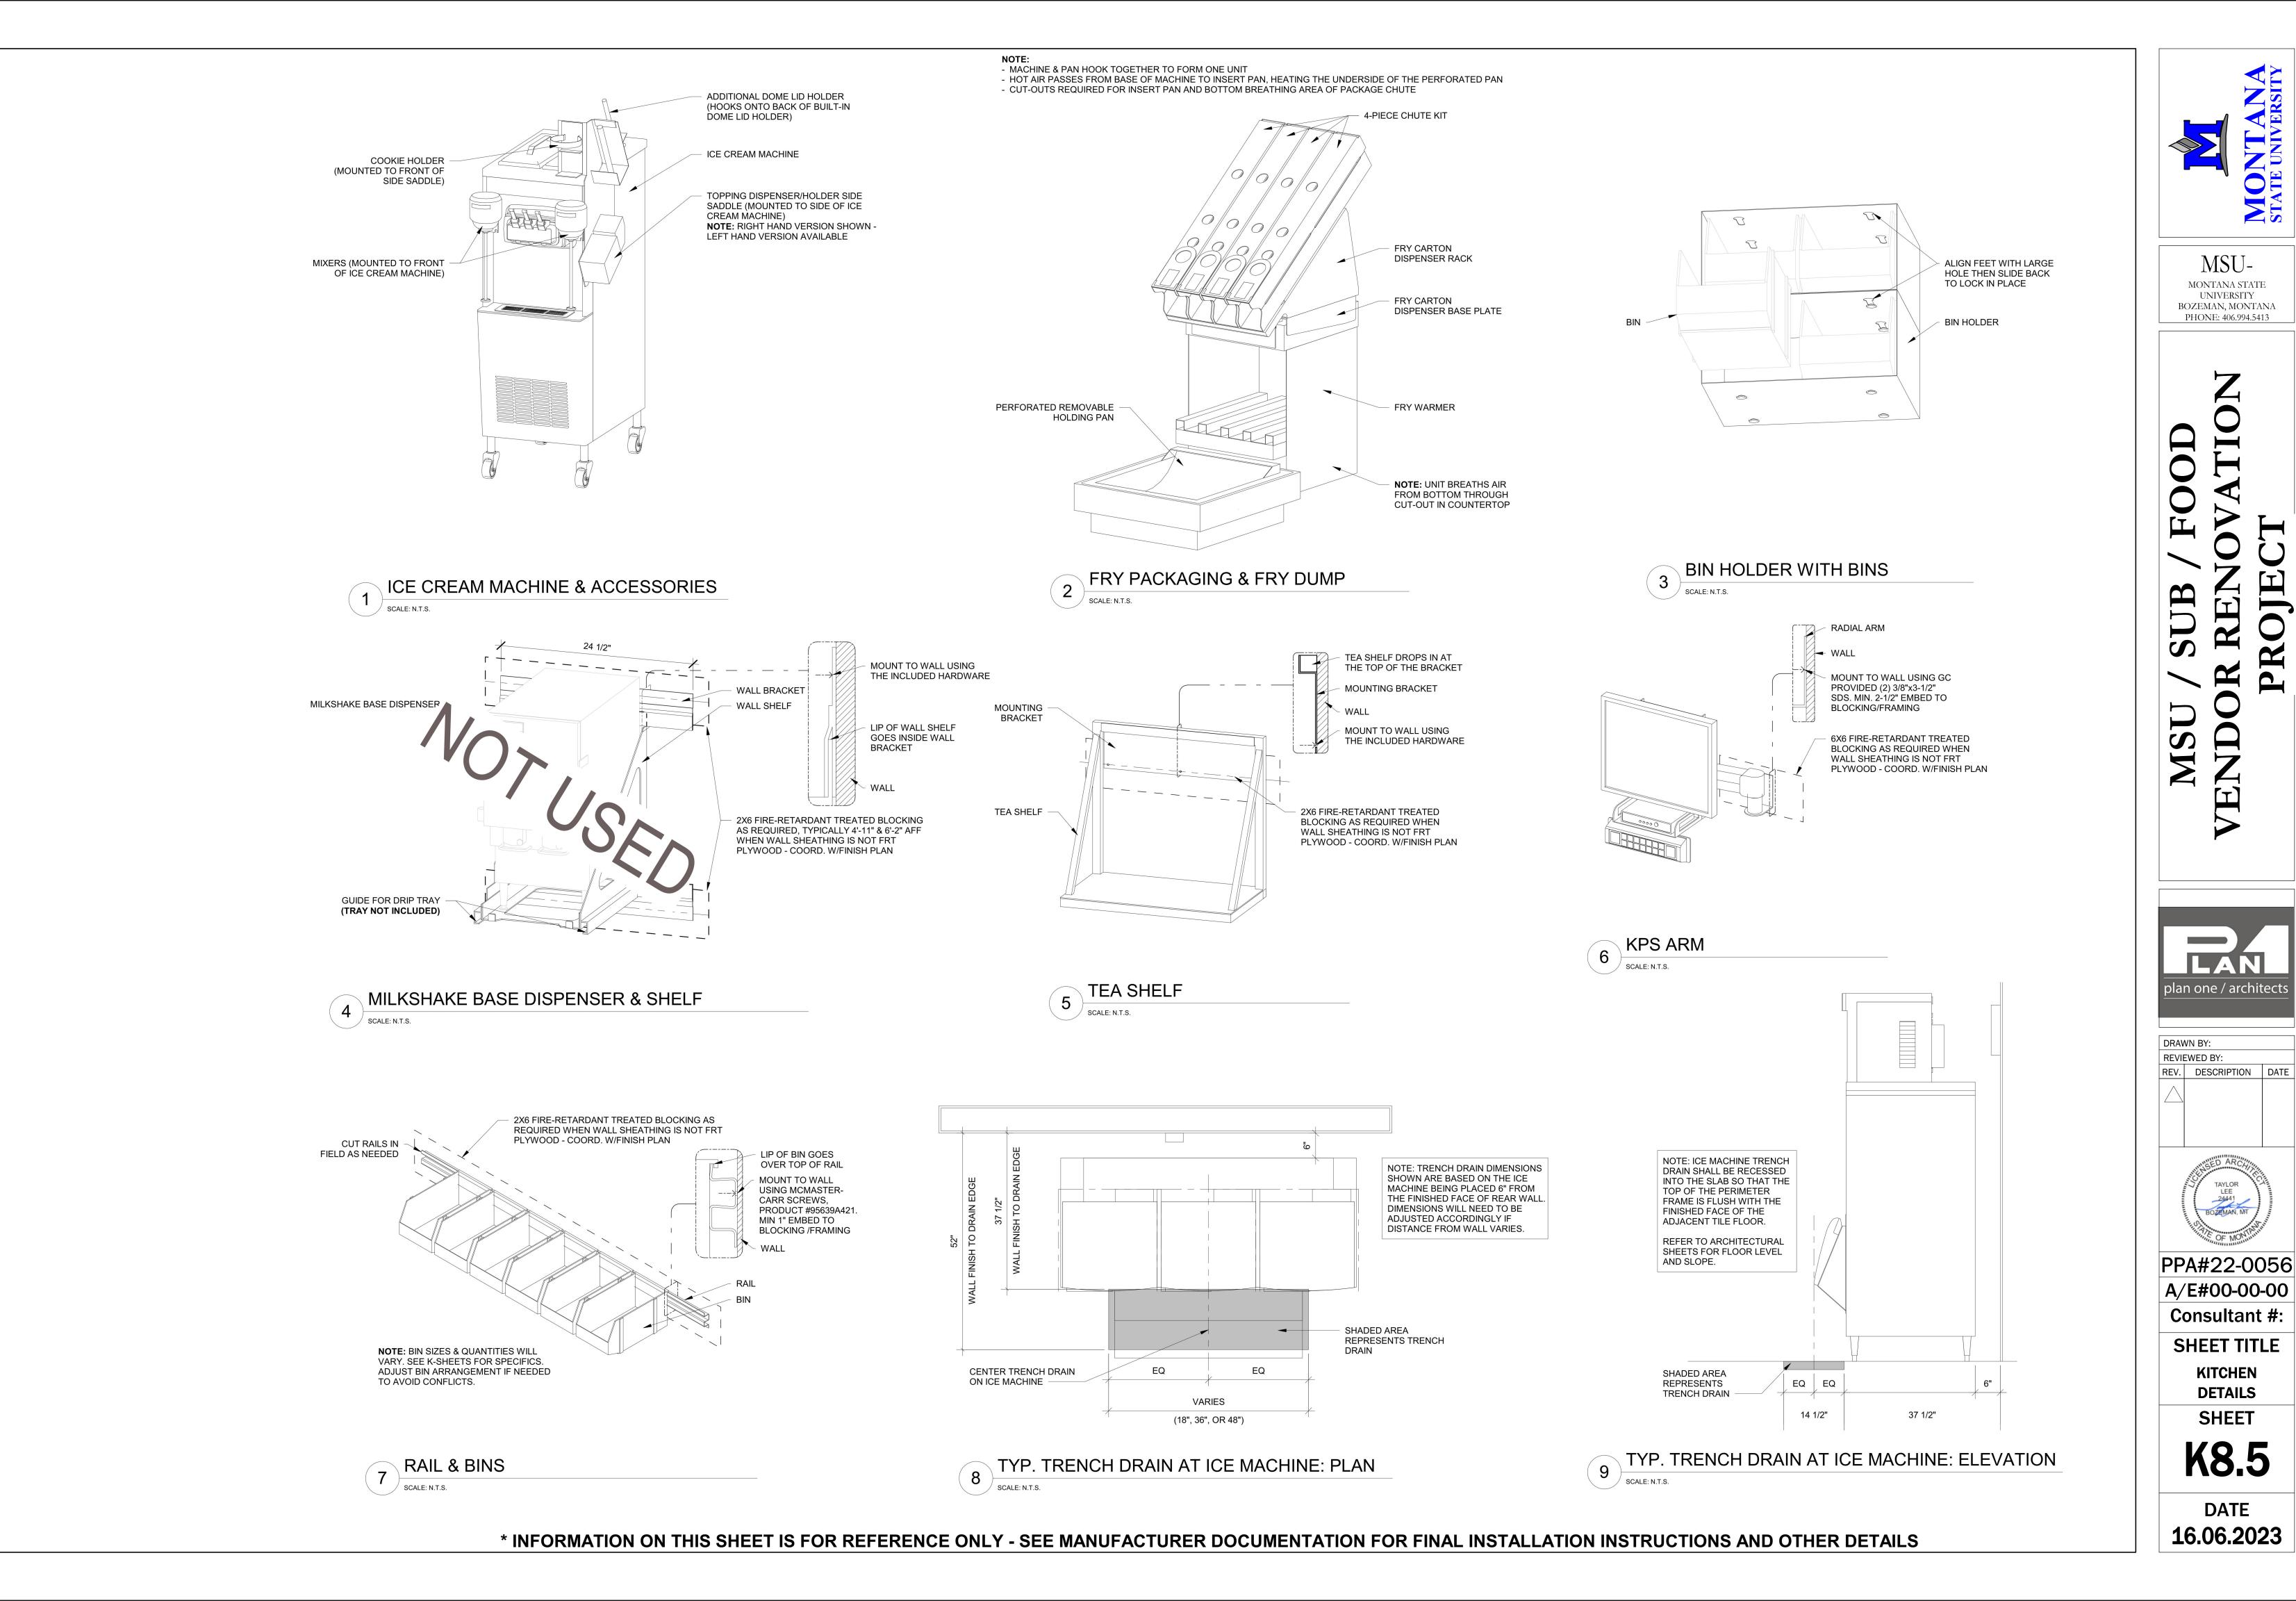



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DATE 16.06.2023

Consultant #:

SHEET TITLE

KITCHEN

DETAILS


SHEET

K8.5

plan one / architects

DRAWN BY: REVIEWED BY: HAND SINK & ACCESSORIES


SCALE: N.T.S.

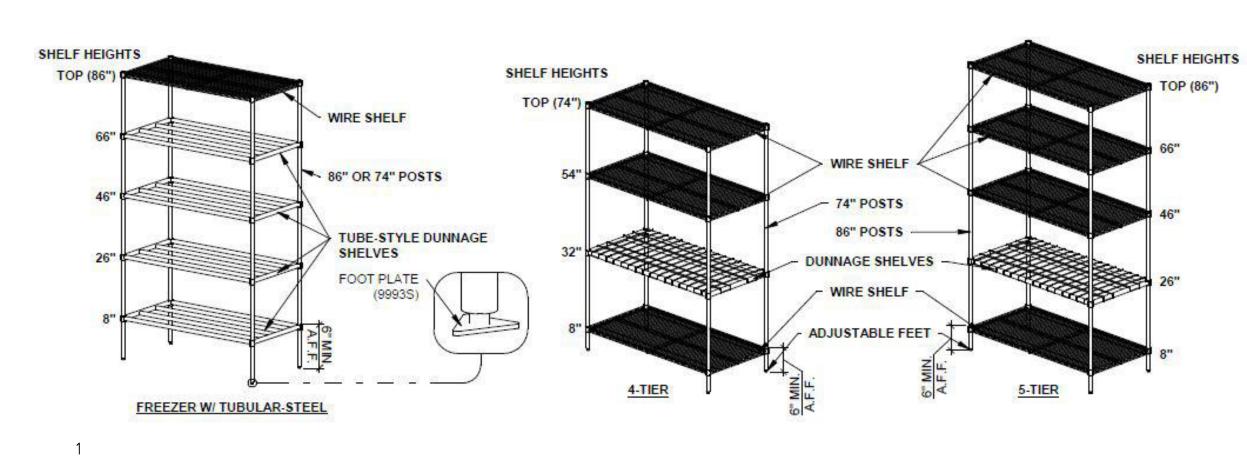


1-COMP VEGGIE PREP SINK SHELF & ACCESSORIES

SCALE: N.T.S.


6 SHELVING DETAIL: FLOOR SHELVES

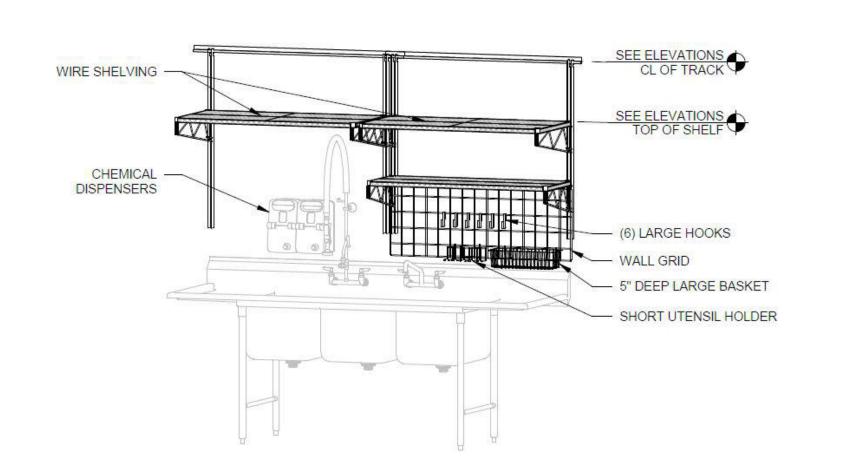




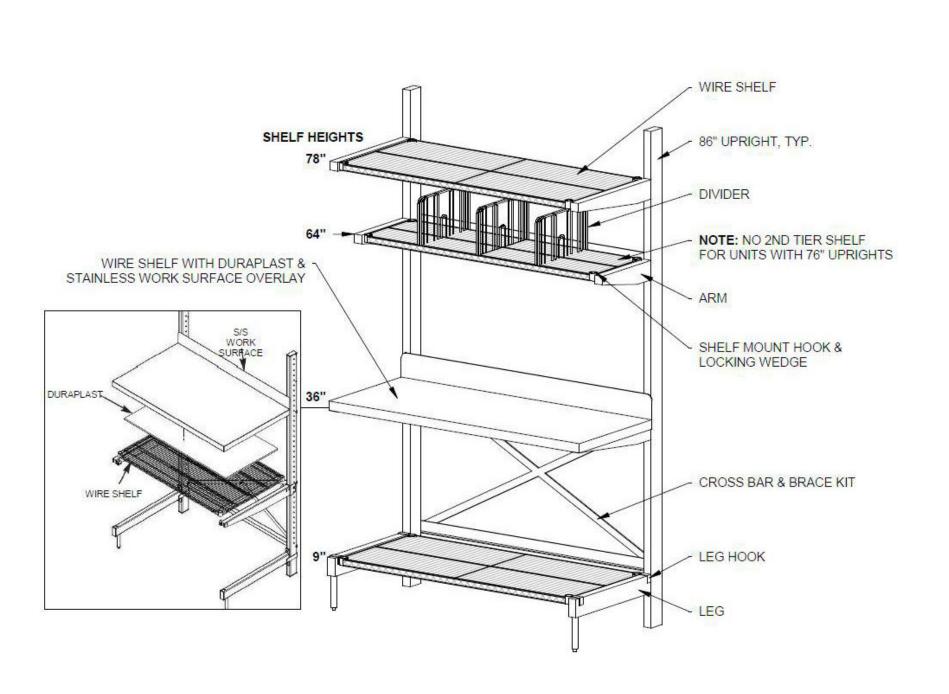

CANTILEVER SHELVING - WORK SURFACE

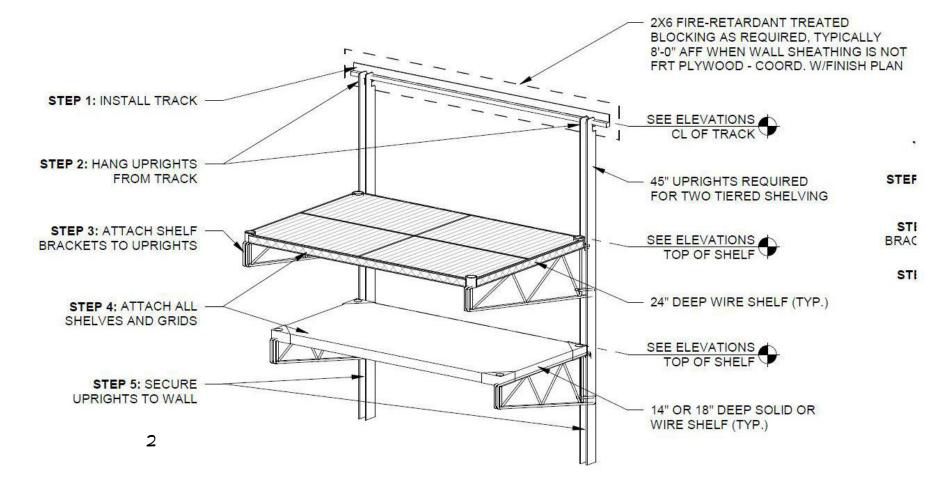

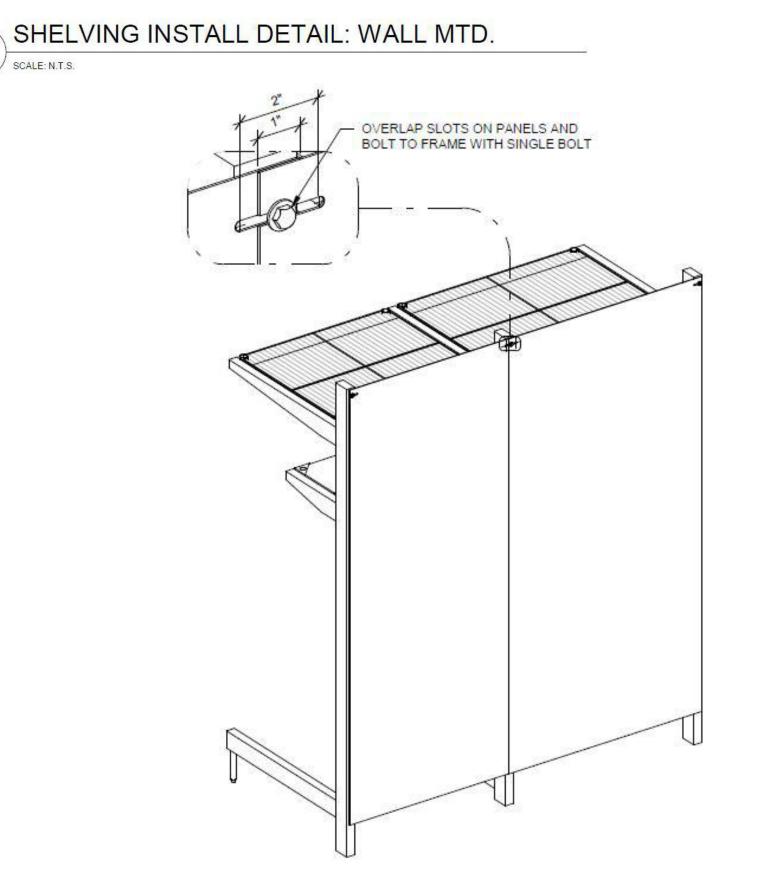

5 STAINLESS STEEL PANELS

MSU / SUB / FOO ENDOR RENOVAT

MSU-

MONTANA STATE


UNIVERSITY

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plan one / architects

2

DRAWN BY:
REVIEWED BY:
REV. DESCRIPTION DATE

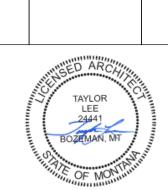

PPA#22-0056
A/E#00-00-00
Consultant #:

SHEET TITLE
KITCHEN
DETAILS

SHEET

K8.6

Panel: NF1

Location: KITCHEN KT-2A **Mounting:** Surface Enclosure: Type 1

Volts: 120/208 Wye Wires: 4

A.I.C. Rating: 14,000 Mains Type: MLO Buss Rating: 800 A

PROVIDE GFCI BREAKERS FOR ANY NON-ACCESSIBLE GFCI DEVICES.

CKT	Load Name	Trip	Poles		A		В		C	Poles	Trip	Load Name	СКТ
1	FRYER	80 A	3	7333	7333					3		FRYER	2
3						7333	7333						4
5								7333	7333				6
7	NF2	225 A	3	14032	23240					3	225 A	NF3	8
9						15680	21680						10
11								18320	22340				12
13	MAU-1	150	3	15000									14
15						15000							16
17								15000					18
19													20
21													22
23													24
25													26
27													28
29													30
31													32
33													34
35													36
37													38
39													40
41													42

Load Classification	Connected Load	Demand Factor	Estimated Demand	Panel	Totals
Motor	49176 VA	122.88%	60426 VA		
Receptacle	4800 VA	100.00%	4800 VA	Total Conn. Load:	204293 VA
Lighting	1447 VA	100.00%	1447 VA	Total Est. Demand:	163439 VA
Kitchen Equipment	148870 VA	65.00%	96766 VA	Total Conn.:	567 A
				Total Est. Demand:	454 A

ELECTRICAL LEGEND

FIRE ALARM DEVICES

LIGHTING DEVICES

	LAY-IN OR RECESSED LIGHTING FIXTURE
0	SURFACE MOUNTED LIGHTING FIXTURE
	DIRECT/ INDIRECT LIGHTING PENDANT MOUNTED FIXTURE.
├	SURFACE MOUNTED OR CHAIN HUNG STRIP FIXTURE
	WALL BRACKET LIGHTING FIXTURE
00	RECESSED DOWN LIGHT, HALF MOON INDICATES WALL WASH TRIM AND DIRECTION.
¤	SURFACE MOUNTED CYLINDER FIXTURE
Ю	WALL MOUNTED FIXTURE
£	WALL SCONCE FIXTURE
	FILLED CENTER OR SLASH INDICATES FIXTURE IS AN EMERGENCY DEVICE WITH EMERGENCY BATTERY PACK OR CONNECTED TO EMERGENCY POWER.
H Z (X)	EXIT SIGN, BRACKET INDICATES WALL MOUNTING. NUMBER OF FACES AND DIRECTION INDICATED BY FILLED AREAS.
R	REMOTE DOUBLE HEAD EGRESS FIXTURE
\forall	SITE GROUND MOUNTED FLOOD FIXTURE
4	DOUBLE HEAD WALL MOUNTED BATTERY PACK POWERED EGRESS FIXTURE.

FOOD SERVICE COORDINATION

ROUND HEAD POLE MOUNTED SITE LIGHT FIXTURE.

CAREFULLY COORDINATE WITH FOOD SERVICE PLANS AND KITCHEN DESIGNER FOR FINAL LOCATION, HEIGHT, AND ALL OTHER INSTALLATION REQUIREMENTS OF ALL DEVICES PRIOR TO ROUGH-IN.

COORDINATE WITH FOOD SERVICE PLANS FOR ANY ADDITIONAL DATA REQUIREMENTS FOR EQUIPMENT.

LOW VOLTAGE ROUGH-IN NOTE

THE ELECTRICAL CONTRACTOR IS RESPONSIBLE FOR ALL ROUGH-IN'S ASSOCIATED WITH SYSTEMS INSTALLED IN PROJECT, INCLUDING BUT NOT LIMITED TO, VOICE/DATA JACKS, FIRE ALARM, SPEAKERS, CLOCKS, CCTV, DOOR ACCESS CONTROL, ETC. EC SHALL COORDINATE ALL REQUIREMENTS, BOX SIZES, CONDUIT SIZES, LOCATIONS AND MOUNTING HEIGHTS WITH OWNER AND OWNER SELECTED CONTRACTOR PRIOR TO

POWER DEVICES

VFD VARIABLE FREQUENCY DRIVE

CO2 DETECTOR BY MC, ROUGH-IN BY EC THERMOSTAT BY MC, ROUGH-IN BY EC

PAD MOUNTED UTILITY TRANSFORMER

UNDERGROUND OR BURIED CIRCUIT

F	MANUAL PULL STATION
F	AUDIO/VISUAL HORN/STOBE DEVICE
F	VISUAL STROBE DEVICE
F	AUDIO SPEAKER DEVICE
Ē	CEILING MOUNTED AUDIO/VISUAL SPEAKER/STROBE DEVICE
É	CEILING MOUNTED AUDIO SPEAKER DEVICE
M	MAGNETIC DOOR HOLDER
(SD)	SMOKE DETECTOR
HD	HEAT DETECTOR
<u>©</u>	CARBON MONOXIDE DETECTOR
DSD —	DUCT SMOKE DETECTOR
FSD	FIRE SMOKE DAMPER
FACP	FIRE ALARM CONTROL PANEL
FAA	FIRE ALARM REMOTE ANNUNCIATOR
R	ADDRESSABLE INTERFACE DEVICE BY EC FOR FIRE/SMOKE DAMPERS
ESV	ELEVATOR SHAFT VENT, CONNECT TO FIRE ALARM SYSTEM
PS	SPRINKLER CONNECTION, PRESSURE SWITCH
TS	SPRINKLER CONNECTION, TAMPER SWITCH
FS	SPRINKLER CONNECTION, FLOW SWITCH
LAA	SPRINKLER CONNECTION, LOW AIR ALARM

	LAY-IN OR RECESSED LIGHTING FIXTURE
0	SURFACE MOUNTED LIGHTING FIXTURE
· ·	DIRECT/ INDIRECT LIGHTING PENDANT MOUNTED FIXTURE.
⊢•	SURFACE MOUNTED OR CHAIN HUNG STRIP FIXTURE
	□ WALL BRACKET LIGHTING FIXTURE
\circ C	RECESSED DOWN LIGHT, HALF MOON INDICATES WALL WASH TRIM AND DIRECTION.
¤	SURFACE MOUNTED CYLINDER FIXTURE
Ю	WALL MOUNTED FIXTURE
H	WALL SCONCE FIXTURE
	FILLED CENTER OR SLASH INDICATES FIXTURE IS AN EMERGENCY DEVICE WITH EMERGENCY BATTERY PACK OR CONNECTED TO EMERGENCY POWER.
H X &	EXIT SIGN, BRACKET INDICATES WALL MOUNTING. NUMBER OF FACES AND DIRECTION INDICATED BY FILLED AREAS.
R	REMOTE DOUBLE HEAD EGRESS FIXTURE
\bowtie	SITE GROUND MOUNTED FLOOD FIXTURE
4	DOUBLE HEAD WALL MOUNTED BATTERY PACK POWERED EGRESS FIXTURE.
←	SQUARE HEAD POLE MOUNTED SITE LIGHT FIXTURE.

MISCELLANEOUS LEGEND


AC	ABOVE COUNTER	AFG	ABOVE FINISHED GRADE
EC	ELECTRICAL CONTRACTOR	WM	WIRE MOLD
(E)	EXISTING	GC	GENERAL CONTRACTOR
(R)	RELOCATED	GND	GROUND
(N)	NEW DEVICE	UG	UNDER GROUND
Ċ	CONDUIT	BOD	BOTTOM OF DEVICE
BFG	BELOW FINISHED GRADE	TOD	TOP OF DEVICE
uc	UNDER COUNTER	COD	CENTER OF DEVICE
WP	WEATHER PROOF	BOF	BOTTOM OF FIXTURE
MC	MECHANICAL CONTRACTOR	PC	PLUMBING CONTRACTOR
1	REFER TO ELECTRICAL NOTES		
	HOMERUN TO ELECTRICAL PANEL		
•	NUMBER OF HASH MARKS INDICATES CONDUCTORS. NO MARKS INDICATE SHOWN BUT SHALL BE INCLUDED IN A	s TWO.	GROUNDING CONDUCTOR NOT
	NORMAL CIRCUIT CONCEALED IN WA	ALL OR	EXPOSED

E2.0

ELECTRICAL ABBREVIATIONS

	POWER DEVICES		ELECTRICAL ADD	INL V IA	
\$	SINGLE POLE SWITCH, SUBSCRIPT INDICATES TYPE: P PILOT LIGHT 2 2 POLE	A ACCU ACU	AMP(S) AIR CONDITIONING CONDENSING UNIT AIR CONDITIONING UNIT	LTS LW	LIGHTS LIGHT WHITE
	MC MOMENTARY CONTACT	ADJ	ADJUSTABLE	MC	MECHANICAL CONTRACTOR
	3 3-WAY	ADMIN AFF	ADMINISTRATION ABOVE FINISH FLOOR	MCA MOC	MINIMUM CIRCUIT AMPS MOMENTARY CONTACT
	4 4-WAY K KEYED	AHU	AIR HANDLING UNIT	MCB	MAIN CIRCUIT BREAKER
	D DIMMER	AL	ALUMINUM AMPERE(S)	MDP	MAIN DISTRIBUTION PANEL
	LV LOW VOLTAGE	AMP APPL	APPLIANCE	MECH MIN	MECHANICAL MINIMUM
	T TIMER, 1 HOUR TIMER, MOTOR RATED FOR EXHAUST FANS	APPROX	APPROXIMATE	MOCP	MAXIMUM OVERCURRENT
	OS OCCUPANCY SENSOR	ATS	AUTOMATIC TRANSFER SWITCH		PROTECTION MAIN LUGS ONLY
	DUDIEV DECEDTA CLE CUDCONDE INDICATECTVDE	BLDG	BUILDING	MLO Mp	MAIN LUGS ONLY MAIN PANEL
	DUPLEX RECEPTACLE SUBSCRIPT INDICATES TYPE: WP WEATHERPROOF	BRK BTU/HR	BREAKER BRITISH THERMAL UNIT/HOUR	MTD	MOUNTED
	GFCI GROUND FAULT CIRCUIT INTERRUPTER	BIU/HK	DRITISH THERMAL UNIT/HOUR	MFA	MINIMUM FEEDER AMPACITY
	AC ABOVE COUNTER	С	CONDUIT	MFG NIC	MANUFACTURER NOT IN CONTRACT
	IG ISOLATED GROUND	CB CCT	CIRCUIT BREAKER CIRCUIT	NO	NUMBER
	TR TAMPER RESISTANT WR WEATHER RESISTANT	CCTV	CLOSED CIRCUIT TELEVISION		OVER CURRENT PROTECTION
	FILLED CENTER INDICATES GFCI DEVICE	CUH	CABINET UNIT HEATER	OCP Off	OVER CURRENT PROTECTION OFFICE
		CFM	CUBIC FEET PER MINUTE	OH	OVERHEAD
₩₩	DOUBLE DUPLEX RECEPTACLE, SUBSCRIPT ABOVE INDICATE TYPE	COM COMM	COMMUNICATION COMMISSARY		PHASE
	· · · · · · · · · · · · · · · · · · ·	COMP	COMPRESSOR	P PNL	PANEL
	DUPLEX RECEPTACLE IN FLOOR BOX	COND CONTR	CONDENSER CONTRACTOR	PREP	PREPARATION
	DOUBLE DUPLEX RECEPTACLE IN FLOOR BOX	cu	COPPER	PROD	PRODUCE PROVIDE & INSTALL
φ	SIMPLEX RECEPTACLE	CTV CW	CABLE TELEVISION COOL WHITE	P/I	
ф	DUPLEX RECEPTACLE, CEILING MOUNTED. DEVICE AND COVER SHALL MATCH	CWP	COLD WATER PUMP	RA RAF	REMOTE ANNUNCIATOR RETURN AIR FAN
Ψ	CEILING FINISH			RECP	RECEPTACLE
- F	CELENTO TITUDI	DIA DISC	DIAMETER DISCONNECT	RECPTS	RECEPTACLES REFRIGERATOR
igoplus	SWITCHED DUPLEX RECEPTACLE, BOX INDICATES DEVICE LOCATED IN FLOOR BOX	DPS	DOOR POWER SUPPLY	REF REFR	REFRIGERANT
Φ	208V SINGLE PHASE RECEPTACLE, CONFIGURATION NOTED ON PLANS	DWG	DRAWING	REQD RM	REQUIRED Room
₩	208V THREE PHASE RECEPTACLE, CONFIGURATION NOTED ON PLANS	EC EF	ELECTRICAL CONTRACTOR EXHAUST FAN	RMS RR	ROOM(S) RESTROOMS
Φ	SIMPLEX RECEPTACLE IN FLOOR BOX	ELEC EMD	ELECTRIC ESTIMATED MAXIMUM DEMAND	RS	RAPID START
	MUSHROOM HEAD PUSH BUTTON	EMER ENGR	EMERGENCY ENGINEER	SDP SER	SUB DISTRIBUTION PANEL SERVICE
PC)	PHOTO CELL	ETC	ETCETERA	SF	SUPPLY FAN SHEET
	WALL MOUNTED CLOCK HANGER/ POWER RECEPTACLE	EWC EXT	ELECTRIC WATER COOLER EXTERIOR	SHT SN	SOLID NEUTRAL
os	CORNER WALL MOUNTED OCCUPANCY SENSOR	FA	FIRE ALARM	SP SPECS	SWITCH, PILOT SPECIFICATIONS
<u>OS</u>	CEILING MOUNTED OCCUPANCY SENSOR, LINE-VOLTAGE	FAC FACP	FACILITY FIRE ALARM CONTROL PANEL	SPST	SWITCH, SINGLE POLE- SINGLE THROW
OS ₂	CEILING MOUNTED OCCUPANCY SENSOR, STYLE 2	FIX FLA	FIXTURE FULL LOAD AMPS	STD STL	STANDARD STEEL
©S ₃	CEILING MOUNTED OCCUPANCY SENSOR, STYLE 3	FT	FOOT	STOR SW	STORAGE SWITCH
PP PP	OCCUPANCY SENSOR POWER PACK, BOX INDICATES WALL MOUNTING	GC	GENERAL CONTRACTOR		TELEPHONE BACK BOARD
	, and the second	GFCI GFI	GROUND FAULT CIRCUIT INTERRUPTER GROUND FAULT INTERRUPTER	TBD TV	TELEVISION
9 🌢 🕲	SPECIAL PURPOSE CONNECTION, BRACKET INDICATES WALL MOUNTING, BOX INDICATES FLOOR MOUNTING		HORSEPOWER	TYP	TYPICAL
		HP HPS	HIGH PRESSURE SODIUM	UG	UNDERGROUND
Ψ od	JUNCTION BOX, BRACKET INDICATES WALL MOUNTING, BOX INDICATES FLOOR	HID	HIGH INTENSITY DISCHARGE	UGE	UNDERGROUND ELECTRICAL UNDERGROUND TELEPHONE
	MOUNTING	HT HTRS	HEIGHT HEATERS	UGT UH	UNIT HEATER
√ M ∕	MOTOR CONNECTION	HW HWH	HOT WATER HOT WATER HEATER	V	VOLT(S)
R	RELAY	HWP	HOT WATER PUMP	VA VEST	VOLT AMPERES VESTIBULE
	NON-FUSED DISCONNECT SWITCH	HZ	HERTZ		
	FUSED DISCONNECT SWITCH	INC	INCORPORATED	W W	WIRE WATT(S)
\square	COMBINATION STARTER/DISCONNECT SWITCH	J-BOX	JUNCTION BOX	W/ WM	WITH WATT MISER
	CONTACTOR	KHZ KIT	KILOHERTZ KITCHEN	XFMR	TRANSFORMER
\$ _M	MANUAL MOTOR STARTER	KVA KW	KILIVOLT AMPERE(S) KILOWATT(S)		
AS	AQUASTAT BY PLUMBING CONTRACTOR, WIRED BY EC.		• •		
VED	VARIARI F FREQUENCY DRIVE				

INTERIOR MOUNTING HEIGHTS

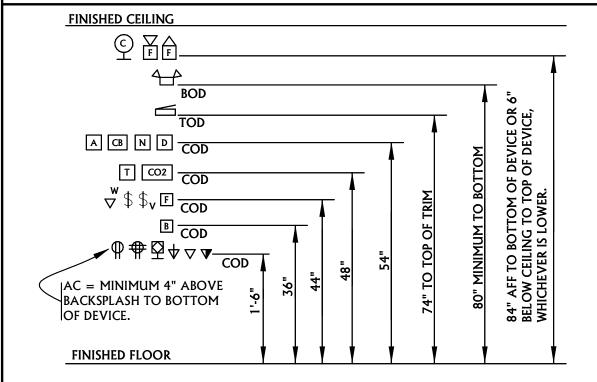

ELECTRICAL SHEET LIST
ELECTRICAL COVER SHEET
PANEL SCHEDULES
ELECTRICAL DEMOLITION PLAN
FIRST FLOOR POWER AND DATA PLAN
ROOF POWER PLAN
FIRST FLOOR LIGHTING PLAN
ELECTRICAL DETAILS

MSU-CPDC MONTANA STATE UNIVERSIT BOZEMAN, MONTANA PHONE: 406.994.5413 FAX: 406.994.5665

ACE INC ACE JOB 22BZ5727

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PPA#22-0056 A/E#00-00-00 Consultant #:

SHEET TITLE **ELECTRICAL COVER** SHEET

SHEET

06.16.2023

Panel:	NF2
Location	KITCHEN KT

Location: KITCHEN KT-2A
Supply From: NF1
Mounting: Surface
Enclosure: Type 1

 Volts:
 120/208 Wye
 A.I.C. Rating:
 14,000

 Phases:
 3
 Mains Type:
 MLO

 Wires:
 4
 Buss Rating:
 225 A

Notes:
PROVIDE GFCI BREAKERS FOR ANY INACCESSIBLE GFCI DEVICES.

CKT	Circuit Description	Trip	Poles		A	В		С		Poles	Trip	Circuit Description	CK
1	Receptacle	20 A	1	720	1260					1	20 A	Receptacle	
3	Receptacle BEVERAGE TOWER	20 A	1			180	180			1	20 A	Receptacle BEVERAGE TOWER	
5	Receptacle	20 A	1					1620	180	1	20 A	Receptacle BEVERAGE TOWER	
7	Receptacle LEMONADE BUBBLER	20 A	1	180	180					1	20 A	Receptacle REFRIGERATOR	
9	Receptacle REFRIGERATOR	20 A	1			180	540			1	20 A	Receptacle	
11	Receptacle TOASTER	20 A	1					180	360	1	20 A	Receptacle	
13	Receptacle HOT HOLDING CABINET	20 A	1	180	180					1	20 A	Receptacle HOT HOLDING TOWER	
15	Receptacle FRY HOLDING STATION	20 A	1			180	865			2	20 A	Receptacle SANDWICH SLIDE	
17	Receptacle REF. WORK TABLE [FUTURE]	20 A	1					180	865				
19	Receptacle ANSUL FIRE SUPPRESSION	20 A	1	1800	1250					2	20 A	Receptacle EGG STATION [FUTURE]	
21	Receptacle VECTOR OVEN	30 A	3			2633	1250						
23								2633	180	1	20 A	Receptacle HOT HOLDING TOWER [FUTURE]	
25				2633	180					1	20 A	Receptacle HOT HOLDING CAB. [FUTURE]	
27	Receptacle RADIANT TOASTER [FUTURE]	35 A	2			2750	360			1		Receptacle	
29								2750	180	1		Receptacle REACH IN FREEZER	
31	Receptacle REFRIGERATOR	20 A	1	180	180					1		Receptacle REF. WORK TABLE [FUTURE]	
33	Receptacle SINGLE COFFEE MAKER [FUTURE]	20 A	2			2000	180			1		Receptacle MIXER [FUTURE]	
35								2000	540	1		Receptacle [FUTURE]	
37	Receptacle PREP TABLE	20 A	1	180	180					1		Receptacle LEMON JUICER	
39	Receptacle	20 A	1	100		360	1550			2		Receptacle ICE MACHINE	
41	Receptacle ICE MACHINE [FUTURE]	20 A	2			300	1330	1550	1550				
43				1550	1427			1330	1330	1		LIGHTING	
45	Receptacle RECIEPT PRINTER	20 A	1	1330	1727	180	900			1		Receptacle GENERAL POWER	
47	Receptacle GENERAL POWER	20 A	1			100	700	900	1260	1		Receptacle DIGITAL BOARDS AND DISPLAYS	
49	EMERGENCY LIGHTING	20 A	1	20	372			700	1200	3	20 A	-	
51	EF-2	20 A	3	20	SIZ	228	372					Er-1	
53	LI-Z					220	SIL	228	372			-	\vdash
55				228	360			220	372	1		Receptacle SERVICE RECEPTACLE	
57	MAU-1 CONNECTION #2		3	220	360	792				I	20 A	Receptacie Service Recept Acte	
59		20 A				192		792					
				702				192					\vdash
61				792									
63													
65													
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Legend:

Load Classification	Connected Load	Demand Factor	Estimated Demand	Panel	Totals
Motor	4176 VA	114.22%	4770 VA		
Receptacle	3420 VA	100.00%	3420 VA	Total Conn. Load:	48033 VA
Lighting	1447 VA	100.00%	1447 VA	Total Est. Demand:	34981 VA
Kitchen Equipment	38990 VA	65.00%	25344 VA	Total Conn.:	133 A
				Total Est. Demand:	97 A

Notes:

Panel: NF3

Location: KITCHEN KT-2A
Supply From: NF1
Mounting: Surface
Enclosure: Type 1

Volts: 120/208 Wye Phases: 3 Wires: 4 A.I.C. Rating: 14,000 Mains Type: MLO Buss Rating: 225 A

Total Conn. Load: 67260 VA

Total Est. Demand: 44202 VA
Total Conn.: 187 A

Total Est. Demand: 123 A

Notes:

PROVIDE GFCI BREAKERS FOR ANY INACCSSIBLE GFCI DEVICES.

Receptacle

Kitchen Equipment

1 3 5 7 9	Receptacle THAWING CABINET					В		С				Circuit Description	СКТ
5 7	D	20 A	1	1920 180						1	Trip 20 A	Receptacle THAWING CABINET [FUTURE]	2
7	Receptacle PRESSURE FRYER	50 A	3			4500	4500			3	50 A	Receptacle PRESSURE FRYER	4
								4500	4500				6
9				4500	4500								8
	LOCK-OFF DEVICE	20 A	1			0	0			1	20 A	LOCK-OFF DEVICE	10
11	Receptacle PRESSURE FRYER	50 A	3					4500	4500	3	50 A	Receptacle PRESSURE FRYER [FUTURE]	12
13				4500	4500								14
15						4500	4500						16
17	LOCK-OFF DEVICE	20 A	1					0	0	1		LOCK-OFF DEVICE	18
19	Receptacle GRILLE [FUTURE]	30 A	3	1100	1100					3	30 A	Receptacle GRILLE	20
21						1100	1100						22
23								1100	1100				24
25	LOCK-OFF DEVICE	20 A	1	0	0					1		LOCK-OFF DEVICE	26
27	Receptacle	20 A	1			540	180			1		Receptacle FIRE SUPPRESSION	28
29	Receptacle ICE CREAM MACHINE	20 A	3					760	0	1		LOCK-OFF DEVICE	30
31				760	180					1		GAS VALVE	32
33						760	0			1		LOCK-OFF DEVICE	34
35	HOOD CONTROL PANEL	20 A	1					180	1200	1	20 A	CIRCUIT FOR ANSUL PULLS	36
37													38
39													40
41													42
43													44
45													46
47													48
49													50
51													52
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65													66
67													68
69													70
71													72 74
73 75													76
75													78
79													80
81													82
83													84
0.5		Ta	tal Load:	2324	0 V 4	2168	0 V 4	2234	0 V A				
			al Amps:		5 A		1 A	187					
end:		100	ar a mupo.										
ena:													

100.00%

65.00%

1380 VA

42822 VA

1380 VA

65880 VA



MSU-CPDC

MONTANA STATE UNIVERSITY
BOZEMAN, MONTANA
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FAX: 406.994.5665

MSU / SUB / FOOD

RENOVATION P

ACE INC

ACE JOB 22BZ5727

DRAWN BY: Author

REVIEWED BYChecker

REV. DESCRIPTION DATE

1 CFA SALAD BAR 05/11/
COMMENTS 23




PPA#22-0056
A/E#00-00-00
Consultant #:

SHEET TITLE PANEL SCHEDULES

SHEET

E2.0

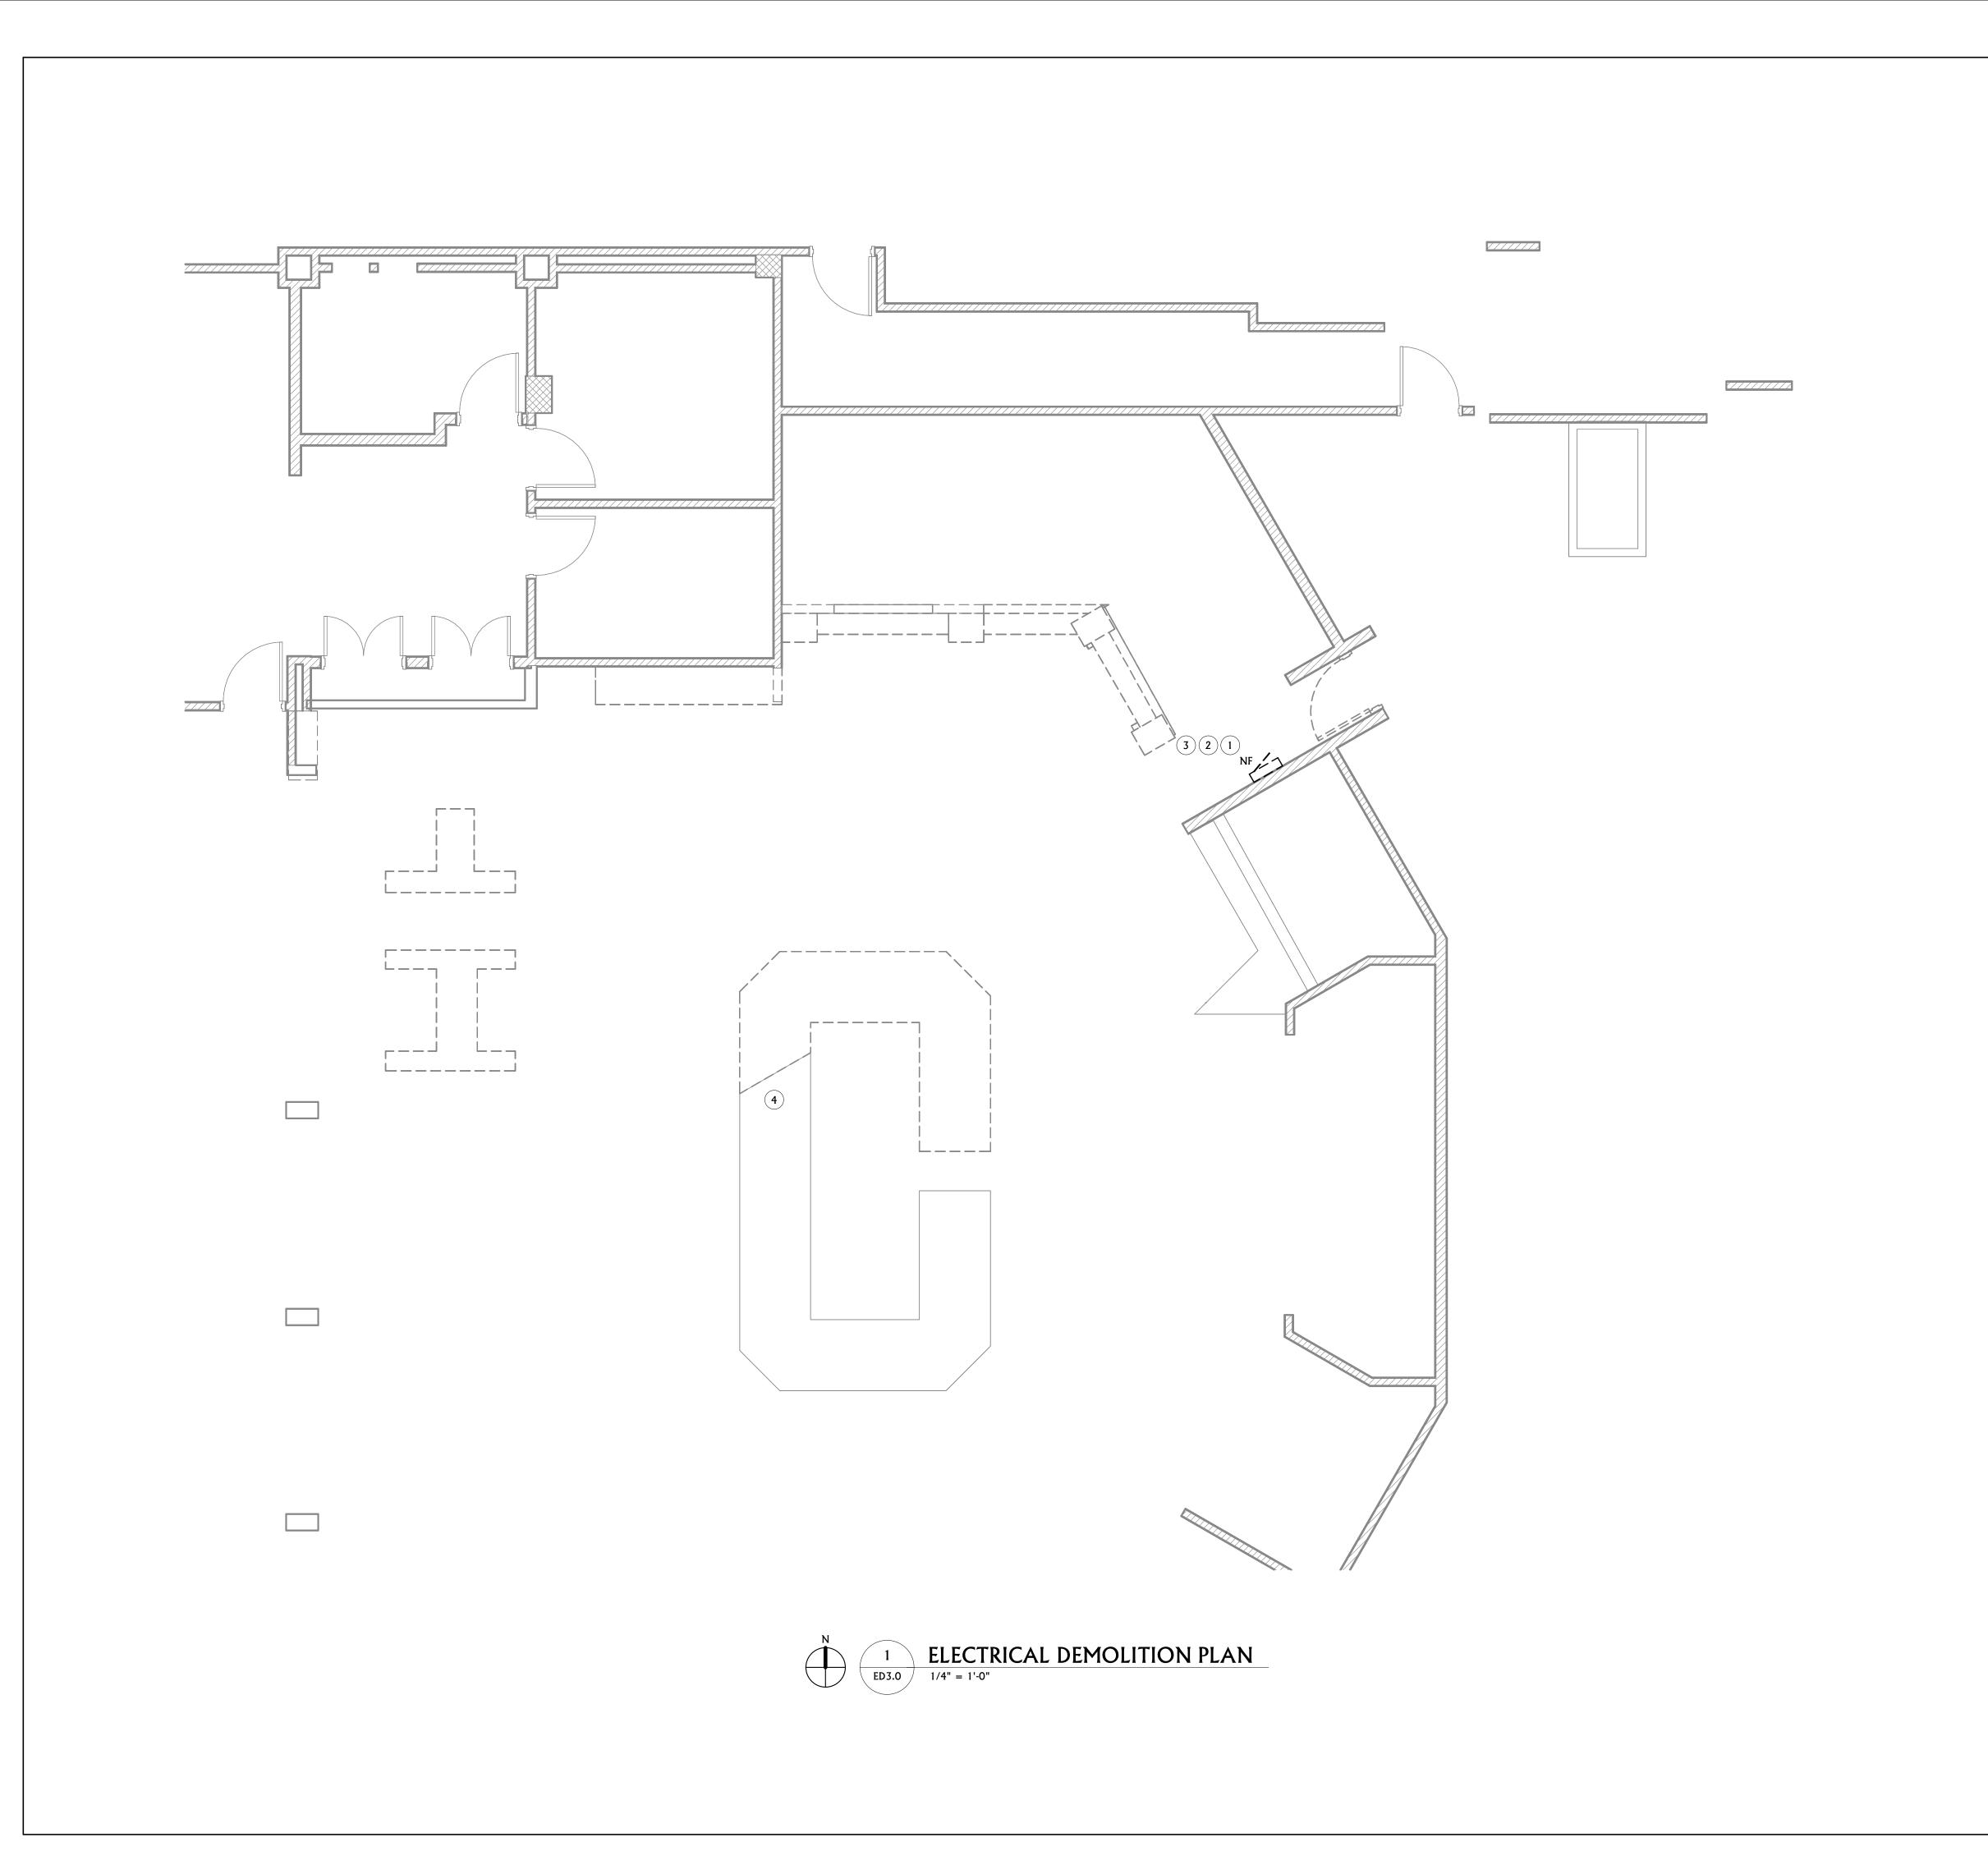

ELECTRICAL GENERAL DEMOLITION NOTES

- A ELECTRICAL CONTRACTOR SHALL REMOVE ALL ELECTRICAL DEVICES IN AREAS OF THIS FACILITY AFFECTED BY REMODEL WORK INCLUDING BUT NOT LIMITED TO: JUNCTION BOXES, OUTLETS, LIGHTS, CABLE, CONDUIT AND WIRE. ALL DEVICES MAY NOT BE SHOWN ON THIS SHEET AND SITE INVESTIGATION IS REQUIRED FOR EXACT QUANTITIES. CONFIRM DEMOLITION SCOPE WITH GENERAL CONTRACTOR AT PRE-BID WALK AND RECYCLE WHERE FEASIBLE. DISPOSE OF ALL FLUORESCENT LAMPS AND BALLASTS IN A LEGAL AND ENVIRONMENTALLY FRIENDLY MANNER. PROVIDE PROPER DISPOSAL DOCUMENTATION STATING ITEMS DISPOSED OF AND QUANTITY TO OWNER FOR
- RETENTION. EXISTING CONDUITS STUBBED THROUGH THE FLOOR THAT ARE NOT REUSED OR ARE ABANDONED SHALL BE CUT AT THE FLOOR SURFACE, GROUND FLUSH AND FILLED WITH GROUT. FLOOR FINISH SHALL MATCH THAT OF EXISTING.
- DEVICES SHOWN ARE BASED ON EXISTING PLANS AND LIMITED VISUAL FIELD OBSERVATIONS AND ARE ONLY INTENDED TO CONVEY SCOPE. DEMO OR MODIFY ALL EXISTING ELECTRICAL INSTALLATIONS AS REQUIRED TO SUPPORT PROJECT. FIELD VERIFY ALL CONDITIONS PRIOR TO BIDDING.
- D ALL WORK SHALL BE PERFORMED IN STRICT ACCORDANCE WITH NEC, STATE AND LOCAL BUILDING CODE.
- RETURN ANY USABLE/ SALVAGEABLE ELECTRICAL DEVICES TO OWNER INCLUDING BUT NOT LIMITED TO: LIGHT FIXTURES, ELECTRICAL HEATERS, PANELS, CIRCUIT BREAKERS ETC. CONFIRM WITH OWNER ITEMS THAT ARE DESIRABLE FOR RETENTION.
- ALL DASHED ITEMS ON DEMOLITION PLANS ARE TO BE REMOVED UNLESS NOTED OTHERWISE. SOLID ITEMS ARE TO REMAIN OR TO BE RELOCATED AS NOTED. NOTE -ITEMS SHOWN IN THE DEMOLITION PLANS ARE BASED ON "EXISTING DRAWINGS". ADDITIONAL ELECTRICAL ITEMS MAY BE ENCOUNTERED THAT ARE NOT SHOWN - ALL GENERAL ELECTRICAL ITEMS IN THE AREA OF REMODEL ARE TO BE REMOVED THAT ARE AFFECTED BY REMODEL. VERIFY ALL EXISTING CONDITIONS PRIOR TO BIDDING.
- G ANY WORK THAT REQUIRES POWER DISRUPTIONS SHALL BE SCHEDULED AND APPROVED BY THE OWNER. ALL WORK SHALL BE PERFORMED WITH NO DISRUPTION OF THE OWNER'S
- H DISCONNECT AND REMOVE ALL ELECTRICAL FROM MECHANICAL EQUIPMENT SHOWN TO BE DEMOLISHED. SEE MECHANICAL DRAWINGS FOR ADDITIONAL INFORMATION.
- SOME DEVICES AND SYSTEMS THAT ARE NOT REMOVED MAY BE AFFECTED BY DEMOLITION AND CONSTRUCTION. PROVIDE ALL LABOR AND MATERIALS REQUIRED TO MAINTAIN OR RESTORE CONTINUITY AND FUNCTION OF ALL EXISTING DEVICES AND SYSTEMS THAT ARE NOT REMOVED BUT ARE AFFECTED BY DEMO OR CONSTRUCTION
- REMOVE ALL ABANDONED WIRE, RACEWAY AND CABLING IN THE PROJECT AREA. PROVIDE UPDATED, TYPEWRITTEN DIRECTORIES FOR ALL EXISTING PANELS AFFECTED BY DEMOLITION WORK. LABEL ALL CIRCUIT BREAKERS THAT HAVE THEIR ENTIRE LOAD REMOVED AS 'SPARE'.
- MAINTAIN OR RESTORE FUNCTIONALITY TO ALL SYSTEMS THAT ARE AFFECTED BY PROJECT PHASING. CONTRACTOR SHALL PROVIDE ALL WORK TO MAINTAIN, CONNECT, RECONNECT, MODIFY OR RESTORE THE FUNCTION OF ALL SYSTEMS THAT ARE AFFECTED IN ANY WAY BY PROJECT PHASING. PROVIDE ALL WORK FOR TEMPORARY CONNECTIONS OR SYSTEM MODIFICATIONS REQUIRED TO ACCOMMODATE PROJECT PHASING. REFER TO ARCHITECTURAL FOR PHASING INFORMATION.
- M ALL PANELS TO REMAIN IN SERVICE UNTIL NEW SERVICE AND DISTRIBUTION SYSTEM IS COMPLETE. CONNECT ALL LOADS REMAINING AFTER DEMO IS COMPLETE TO NEW PANELS. MODIFY AND EXTEND WIRING AS REQUIRED.

ELECTRICAL KEYNOTES

- REMOVE ALL EXISTING ELECTRICAL POWER AND LIGHTING DEVICES WITHIN PROJECT
- COORDINATE WITH MECHANICAL CONTRACTOR FOR REMOVAL OF EXISTING ROOFTOP MECHANICAL EQUIPMENT SERVING PROJECT SCOPE.
- DEMO PANEL NF AND ASSOCIATED FEEDER. RELABEL BREAKER FOR NF IN MDP-X AS
- MAINTAIN CIRCUITING TO SALAD BAR.



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CFA SALAD BAR 05/11/ COMMENTS 23



PPA#22-0056 A/E#00-00-00 Consultant #:

SHEET TITLE **ELECTRICAL DEMOLITION PLAN**

SHEET

ED3.0



ELECTRICAL POWER GENERAL NOTES

- A REFER TO ARCHITECTURAL PLANS FOR ADDITIONAL INFORMATION ON DEVICE LOCATIONS, DIMENSIONS, ETC. CAREFULLY EXAMINE ARCHITECTURAL FLOOR PLANS, CEILING PLANS, ELEVATIONS, ETC. FOR INFORMATION THAT AFFECTS ELECTRICAL WORK. NOTIFY ARCHITECT/ENGINEER IMMEDIATELY OF ANY DISCREPANCIES BETWEEN ARCHITECTURAL AND ELECTRICAL PLANS.
- B ALL DARK ITEMS ARE NEW, UNLESS NOTED OTHERWISE. ALL SHADED ITEMS ARE EXISTING
- C ALL ITEMS DENOTED WITH AN (R) ARE RELOCATED OR REINSTALLED. ALL ITEMS
- DENOTED WITH AN (E) ARE EXISTING TO REMAIN. D EC SHALL COORDINATE EXACT FLOOR BOX LOCATION WITH ARCHITECTURAL FURNITURE PACKAGE PRIOR TO SETTING OF ANY BOXES, UNLESS SPECIFICALLY DIMENSIONED IN THE PLAN. SEE ARCHITECTURAL FURNITURE PLAN FOR DETAILS.
- E CONNECT ALL DEVICES TO EXISTING CIRCUITS SERVING THE AREA UNLESS NOTED OTHERWISE. VERIFY EXISTING LOAD PRIOR TO CONNECTING ADDITIONAL DEVICES.
- CONNECT ALL FIRE ALARM DEVICES TO EXISTING FIRE ALARM SYSTEM. CONNECT ALL SPEAKERS TO EXISTING OVERHEAD PAGING SYSTEM.
- H FIRE SEAL ALL PENETRATIONS IN FIRE RATED WALLS. COORDINATE WITH ARCHITECTURAL FOR LOCATIONS.
- REFER TO FOOD SERVICE PLANS FOR ADDITIONAL ELECTRICAL REQUIREMENTS AND DETAILS. COORDINATE EXACT LOCATION OF EQUIPMENT AND DEVICES WITH FOOD SERVICE PLANS.

ELECTRICAL KEYNOTES

- PROVIDE PERMANENTLY MOUNTED LOCK-OFF AT BREAKER FUTURE DEVICE. CIRCUIT INFO SUBJECT TO CHANGE FROM OWNER/ARCHITECT.
- PROVIDE GFCI BREAKERS FOR INACCESSIBLE DEVICES.
- COORDINATE WITH FOOD SERVICE PLANS FOR ALL CEILING POWERED DEVICES. COORDINATE WITH FOOD SERVICE PLANS FOR ALL EQUIPMENT MOUNTING HEIGHTS.
- RELOCATE EXISTING HORN STROBE DEVICE TO APPROXIMATE LOCATION. FIELD
- COORDINATE WITH EXISTING BUILDING FIRE ALARM SYSTEMS ARE REQUIRED. DATA DROPS SHOWN OFFSET FOR CLARITY. COORDINATE WITH FOOD SERVICE FOR
- EXACT LOCATIONS & DEVICE TO BE SERVED. QUADPLEX PROVIDED FOR DIGITAL MENU BOARD. COORDINATE WITH FOOD SERVICE
- FOR EXACT LOCATION.
- PROVIDE ANSUL PULLS FOR UNDER HOOD DEVICES. PROVIDE CONDUIT AND BOXES FOR CATCARD READER. COORDINATE WITH CADCARD FOR READER.





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PPA#22-0056 A/E#00-00-00 Consultant #:

SHEET TITLE FIRST FLOOR POWER **AND DATA PLAN**

SHEET

E3.0

ELECTRICAL POWER GENERAL NOTES

- A REFER TO ARCHITECTURAL PLANS FOR ADDITIONAL INFORMATION ON DEVICE LOCATIONS, DIMENSIONS, ETC. CAREFULLY EXAMINE ARCHITECTURAL FLOOR PLANS, CEILING PLANS, ELEVATIONS, ETC. FOR INFORMATION THAT AFFECTS ELECTRICAL WORK. NOTIFY ARCHITECT/ENGINEER IMMEDIATELY OF ANY DISCREPANCIES BETWEEN ARCHITECTURAL AND ELECTRICAL PLANS.
- B ALL DARK ITEMS ARE NEW, UNLESS NOTED OTHERWISE. ALL SHADED ITEMS ARE EXISTING
- C ALL ITEMS DENOTED WITH AN (R) ARE RELOCATED OR REINSTALLED. ALL ITEMS DENOTED WITH AN (E) ARE EXISTING TO REMAIN.
- D EC SHALL COORDINATE EXACT FLOOR BOX LOCATION WITH ARCHITECTURAL FURNITURE PACKAGE PRIOR TO SETTING OF ANY BOXES, UNLESS SPECIFICALLY DIMENSIONED IN THE PLAN. SEE ARCHITECTURAL FURNITURE PLAN FOR DETAILS.
- E CONNECT ALL DEVICES TO EXISTING CIRCUITS SERVING THE AREA UNLESS NOTED OTHERWISE. VERIFY EXISTING LOAD PRIOR TO CONNECTING ADDITIONAL DEVICES.
- F CONNECT ALL FIRE ALARM DEVICES TO EXISTING FIRE ALARM SYSTEM. G CONNECT ALL SPEAKERS TO EXISTING OVERHEAD PAGING SYSTEM.
- H FIRE SEAL ALL PENETRATIONS IN FIRE RATED WALLS. COORDINATE WITH ARCHITECTURAL FOR LOCATIONS.
- REFER TO FOOD SERVICE PLANS FOR ADDITIONAL ELECTRICAL REQUIREMENTS AND DETAILS. COORDINATE EXACT LOCATION OF EQUIPMENT AND DEVICES WITH FOOD SERVICE PLANS.

ELECTRICAL KEYNOTES

CONTROLS. COORDINATE WITH FOOD SERVICE PROVIDER AND MECHANICAL CONTRACTOR.





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REFER TO MAU/EF'S MANUFACTURER'S WIRING DIAGRAM FOR INTERCONNECT TO HOOD

DOCUMENT CONSTR 100%



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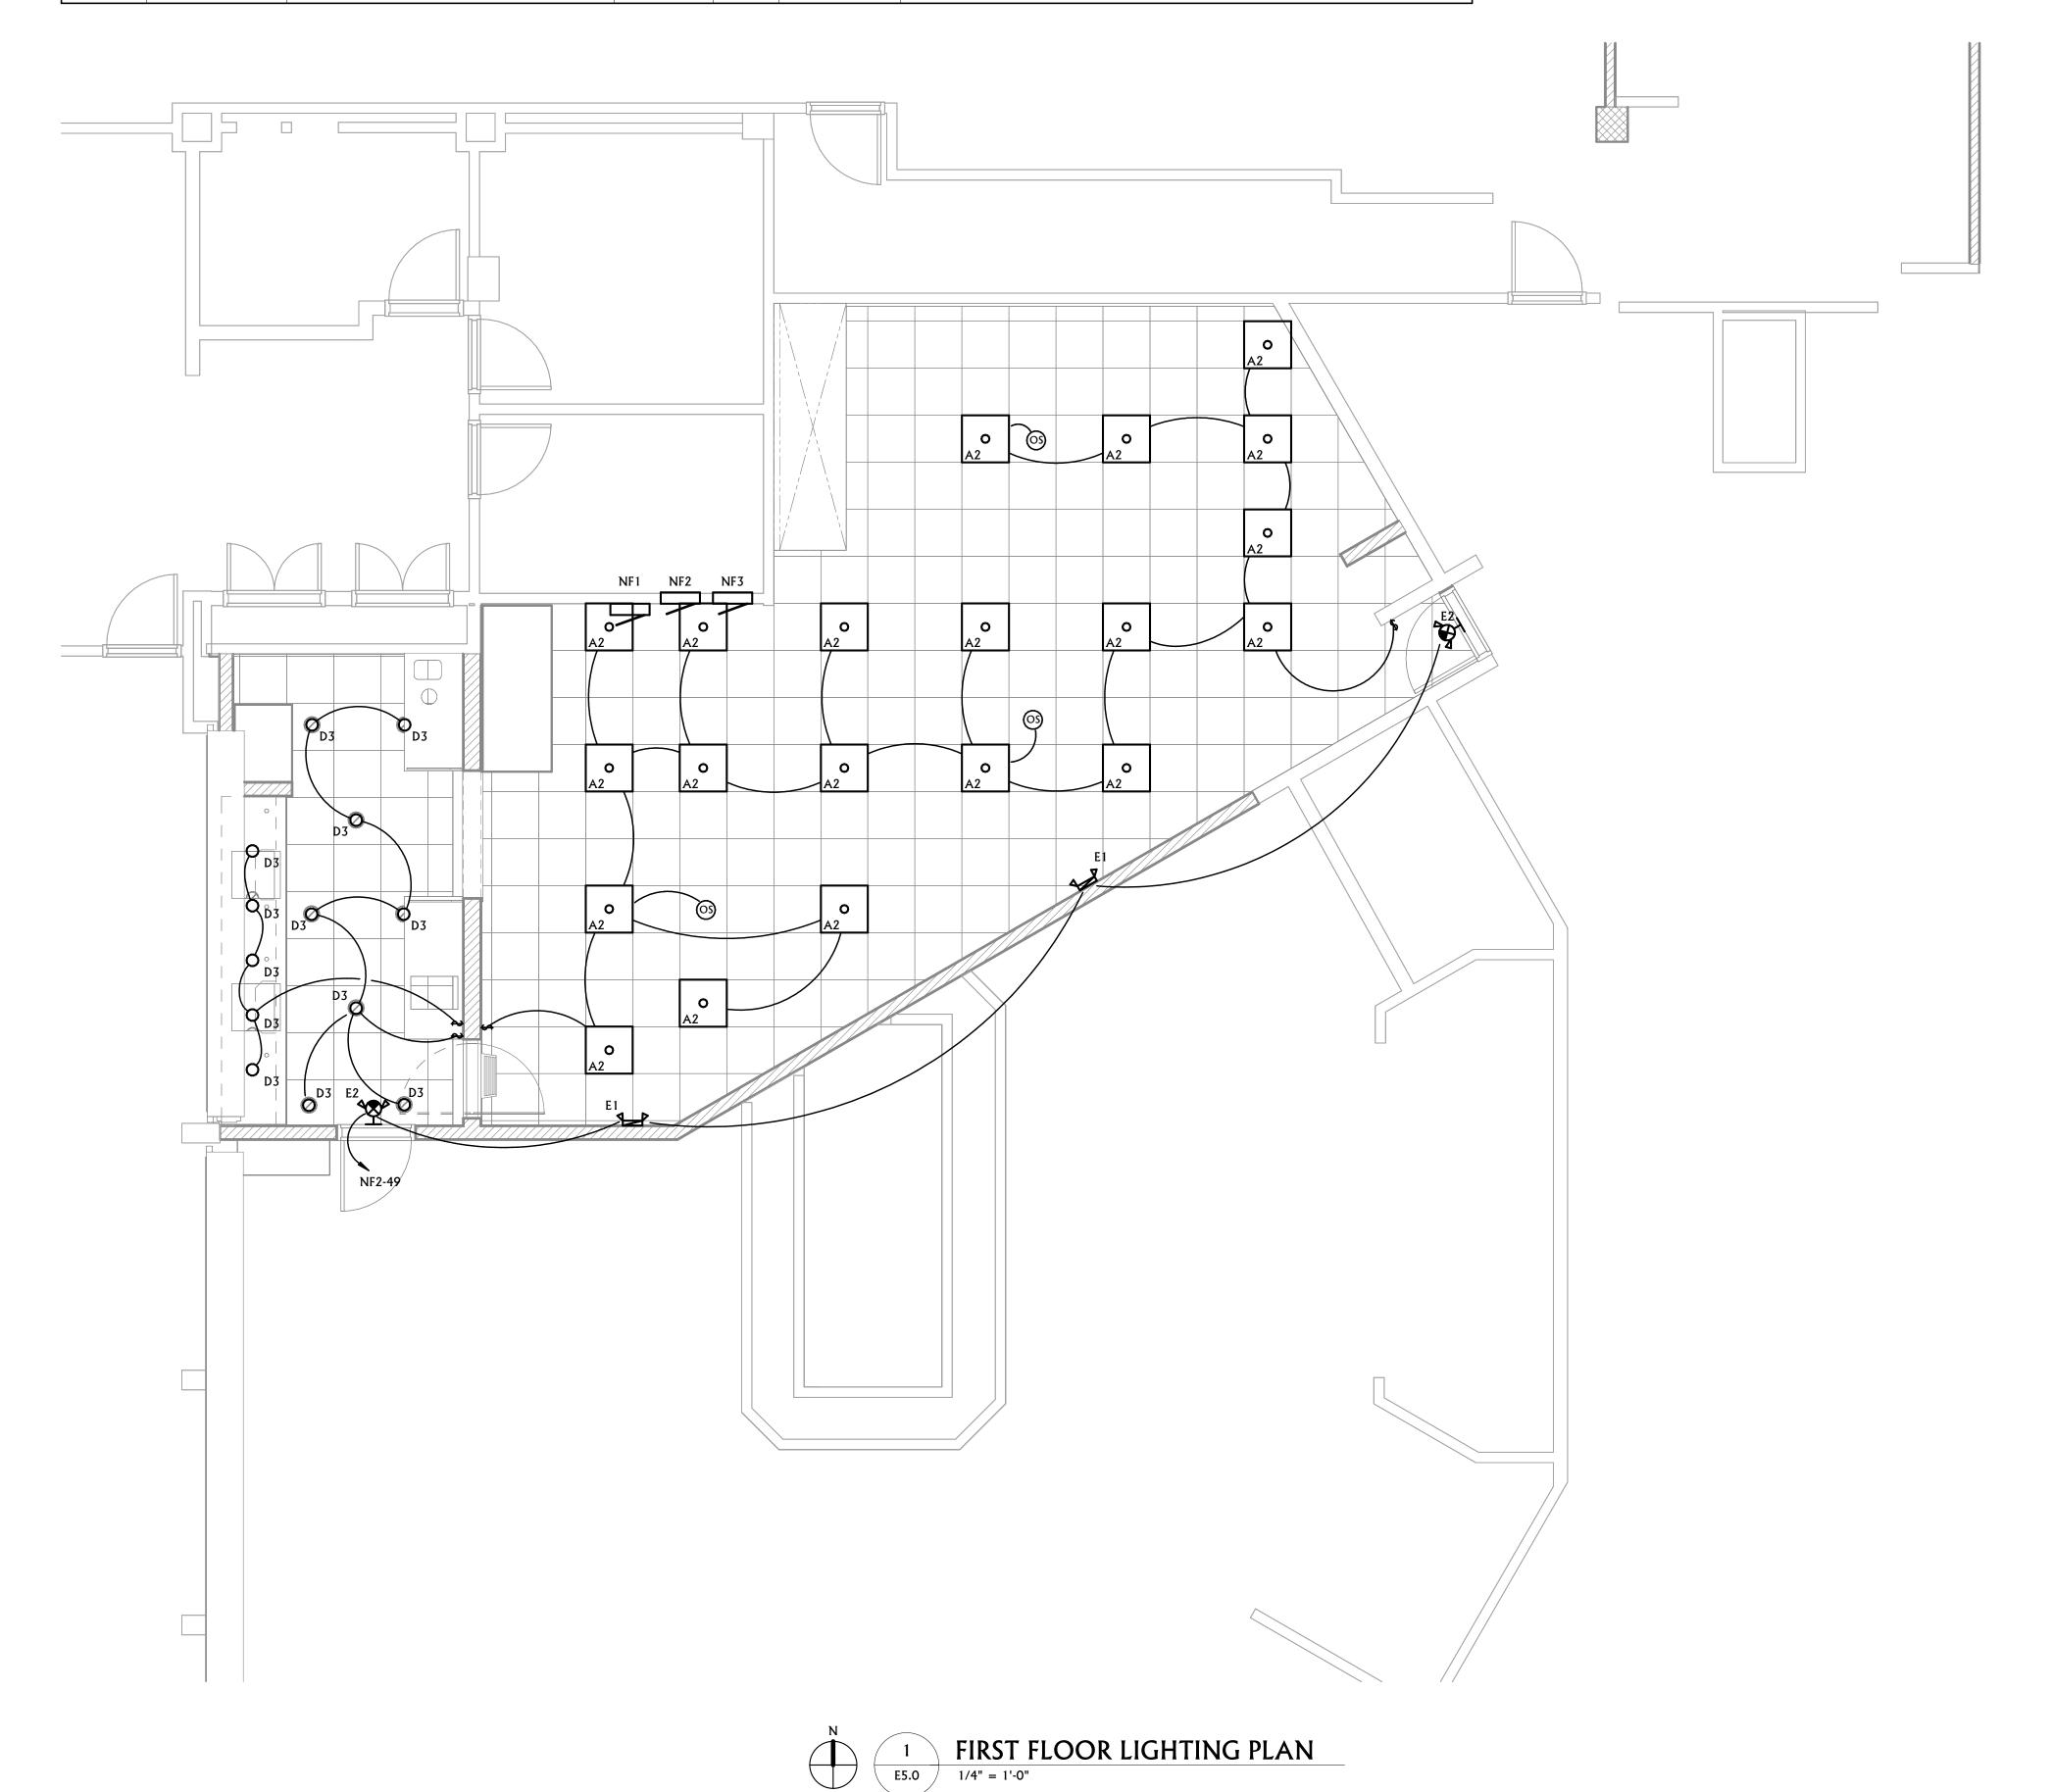
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SHEET TITLE ROOF POWER PLAN

SHEET

E4.0

LUMINAIRE SCHEDULE										
					ELECTRICAL					
CALLOUT	MANUFACTURER	MODEL	MOUNTING	LAMP	DATA	DESCRIPTION				
A2	COOPER	24FP6440C	RECESSED	LED	120 V/1-59 VA	2'X4' LED FLAT PANEL RATED 6611 LUMENS, 4000K COLOR TEMP				
D3	COOPER	PD6-20-D010B-PDM6B-30-61VC	RECESSED	LED	120 V/1-19 VA	LED DOWNLIGHT WITH CLEAR REFLECTOR & TRIM RATED 2000 LUMENS, 3000K COLOR TEMP				
E1	SURE-LITES	SELW25	WALL	LED	120 V/1-5 VA					
E2	SURE-LITES	APC7R	WALL	LED	120 V/1-5 VA					



ELECTRICAL LIGHTING GENERAL NOTES

- A REFER TO ARCHITECTURAL PLANS FOR ADDITIONAL INFORMATION ON DEVICE LOCATIONS, DIMENSIONS, ETC. CAREFULLY EXAMINE ARCHITECTURAL FLOOR PLANS, CEILING PLANS, ELEVATIONS, ETC. FOR INFORMATION THAT AFFECTS ELECTRICAL WORK. NOTIFY ARCHITECT/ENGINEER IMMEDIATELY OF ANY DISCREPANCIES BETWEEN ARCHITECTURAL AND ELECTRICAL PLANS.
- B ALL DARK ITEMS ARE NEW, UNLESS NOTED OTHERWISE. ALL SHADED ITEMS ARE EXISTING
- C ALL ITEMS DENOTED WITH AN (R) ARE RELOCATED OR REINSTALLED. ALL ITEMS DENOTED WITH AN (E) ARE EXISTING TO REMAIN.
- D MODIFY AND REUSE EXISTING CIRCUITS WHERE POSSIBLE. CIRCUITING SHALL BE AS SHOWN BUT CIRCUIT NUMBERS MAY BE CHANGED TO MAKE USE OF EXISTING AVAILABLE CIRCUITS. PROVIDE NEW BREAKERS AND WIRING AS NEED TO ACCOMMODATE NEW CIRCUITING.
- E CONNECT ALL LIGHTING FIXTURES TO EXISTING LIGHTING CIRCUITS UNLESS NOTED OTHERWISE. VERIFY EXISTING LOAD PRIOR TO CONNECTING ADDITIONAL LIGHTING FIXTURES.
- CONNECT ALL EXIT SIGNS AND EMERGENCY FIXTURES TO EXISTING EMERGENCY
- CIRCUITS SUPPLYING AREA UNLESS NOTED OTHERWISE, WIRING NOT SHOWN. G LOW VOLTAGE WIRING FOR OCCUPANCY SENSORS AND POWER PACKS NOT SHOWN.
- PROVIDE POWER PACKS AND WIRING AS REQUIRED FOR ALL OCCUPANCY SENSORS. H VERIFY VOLTAGE OF EXISTING LIGHTING CIRCUITS PRIOR TO SUBMITTALS. COORDINATE ANY MODIFICATIONS TO LIGHTING CIRCUITS OR FIXTURES WITH ENGINEER.
- PROVIDE UNSWITCHED HOT CONDUCTOR FROM LOCAL LIGHTING CIRCUIT TO ALL EMERGENCY AND EXIT FIXTURES.
- WHEN LIGHT SWITCHES ARE SHOWN LOCATED ON THE WALL THAT IS COMMON WITH THE END OF THE DOOR SWING INTO A SPACE, DO NOT LOCATE THE SWITCHES BEHIND THE DOOR BUT RATHER A MINIMUM OF 6" FROM THE END OF THE SWING. VERIFY EXACT DOOR SWING PRIOR TO ROUGH-IN.
- K FIRE SEAL ALL PENETRATIONS IN FIRE RATED WALLS. COORDINATE WITH ARCHITECTURAL FOR LOCATIONS.
- L REFER TO FOOD SERVICE PLANS FOR ADDITIONAL ELECTRICAL REQUIREMENTS AND DETAILS. COORDINATE EXACT LOCATION OF EQUIPMENT AND DEVICES WITH FOOD

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SHEET TITLE FIRST FLOOR **LIGHTING PLAN**

SHEET

E5.0




EXTEND CONDUIT TO ACESSIBLE CEILING SPACE,

PROVIDE PLASTIC BUSHING

FIRE SEAL ALL PENETRATIONS THROUGH RATED ASSEMBLIES

WHEN INTERMEDIATE CEILING SYSTEMS ARE USED, NO. 12 GA. (2.7 MM) HANGERS SHALL BE ATTACHED TO THE GRID MEMBERS WITHIN 3" (76 MM) OF EACH CORNER OF EACH FIXTURE. TANDEM FIXTURES MAY UTILIZE COMMON WIRES. WHEN HEAVY-DUTY CEILING SYSTEMS ARE USED, SUPPLEMENTAL HANGERS ARE NOT REQUIRED IF A 48" (1219 MM) MODULAR HANGER PATTERN IS FOLLOWED. WHEN CROSS RUNNER ARE USED WITHOUT SUPPLEMENTAL HANGERS TO SUPPORT LIGHTING FIXTURES, THESE CROSS RUNNERS SHALL PROVIDE THE SAME CARRYING CAPACITY AS THE MAIN RUNNER. LIGHTING FIXTURES WEIGHING LESSS THAN 56 LBS. (25.4 KG) SHALL HAVE FOUR NO. 12 GA (2.7 MM) HANGERS CONNECTED FROM THE FIXTURE HOUSING TO THE STRUCTURE ABOVE. THESE WIRES MAY LIGHTING FIXTURES WEIGHING 56 LBS (25.4 KG) OR MORE SHALL BE SUPPORTED DIRECTLY FROM THE STRUCTURE ABOVE BY APPROVED HANGERS. **RUNNERS** RECESSED **FIXTURE** -MAIN-RUNNERS



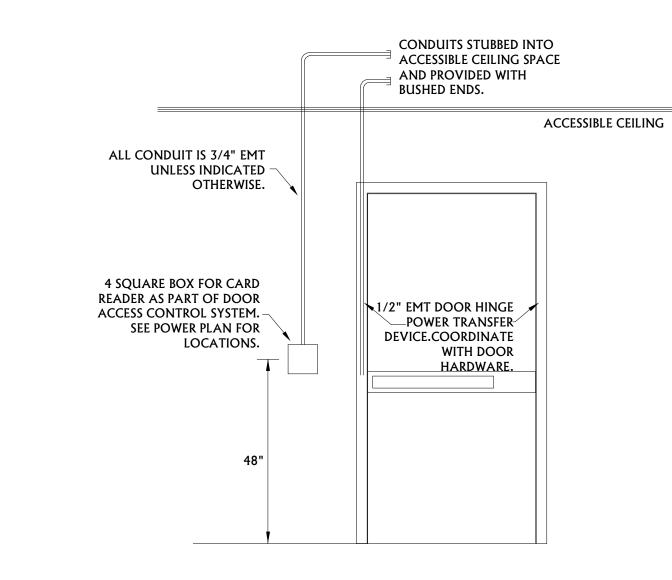


COMMUNICATIONS OUTLET ROUGH-IN DETAIL

1 1/2" EMT—

RANDL INDUSTRIES 5-SQUARE BOX-

WITH TWO-GANG MUD RING



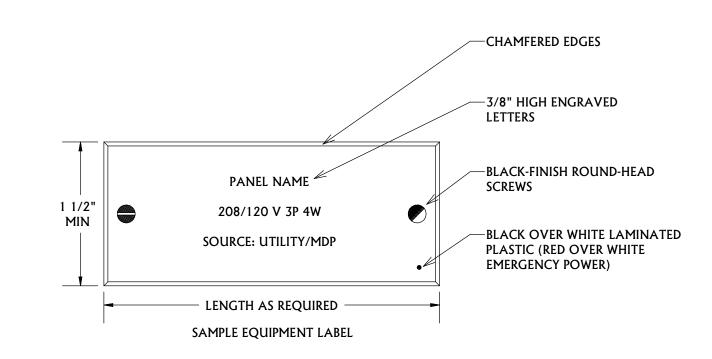

EQUIPMENT IDENTIFICATION LABEL



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CONSTRUCTION DOCUMENTS

100% ACE

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PPA#22-0056 A/E#00-00-00 Consultant #:

SHEET TITLE **ELECTRICAL DETAILS**

SHEET

E6.0

KITCHEN HOOD FIRE PROTECTION NOTES

- EACH TYPE I GREASE HOOD OR HOOD SYSTEM SHALL BE PROTECTED BY AN AUTOMATIC WET AGENT FIRE PROTECTION SYSTEM IN
- **COMPLIANCE WITH NFPA 96.** UPON ACTIVATION OF THE HOOD OR HOOD SYSTEM FIRE PROTECTION SYSTEM:
- ALL SOURCES OF FUEL AND ELECTRICAL POWER THAT PRODUCE HEAT TO ALL EQUIPMENT REQUIRING PROTECTION BY THAT SYSTEM
- STEAM SUPPLIED FROM AN EXTERNAL SOURCE SHALL NOT BE REQUIRED TO AUTOMATICALLY SHUT OFF.
- GAS APPLIANCES NOT REQUIRING PROTECTION BUT LOCATED UNDER THE HOOD OR HOOD SYSTEM WHERE PROTECTED APPLIANCES ARE LOCATED SHALL AUTOMATICALLY SHUT OFF.
- HOOD SYSTEM EXHAUST FAN(S) SHALL CONTINUE TO OPERATE AFTER THE EXTINGUISHING SYSTEM HAS BEEN ACTIVATED HOOD EXHAUST FAN(S) SHALL START UPON ACTIVATION OF THE EXTINGUISHING SYSTEM IF THE EXHAUST FAN AND ALL COOKING EQUIPMENT SERVED BY THE FAN HAVE BEEN SHUT DOWN.
- MAKEUP AIR UNIT SHALL BE DISABLED. EACH SYSTEM SHALL BE PROVIDED WITH A MANUAL METHOD OF ACTIVATION.

MANUAL BALANCING DAMPERS

ALL MANUAL DAMPER OPERATORS SHALL BE LOCKING QUADRANT TYPE. PROVIDE DAMPER INDEPENDENT FROM HIGH EFFICIENCY TAKEOFFS IF NEEDED TO ACCOMPLISH THIS.

TEST AND BALANCE NOTES

- TEST AND BALANCE WORK IS TO BE IN ACCORDANCE WITH NEBB STANDARDS.
- CONTRACTOR SHALL PROVIDE TEST AND BALANCE SERVICES FOR FAN COIL SYSTEM, EXHAUST SYSTEM, AND DOMESTIC HOT WATER RECIRCULATION SYSTEM.
- CONTRACTOR SHALL PROVIDE A FINAL REPORT INCLUDING ALL SYSTEM RESULTS. REPORT SHALL NOTE ANY NON-TYPICAL SYSTEM CHARECTERISTICS ENCOUTERED DURING THE TESTING PERIOD AND ANY MESURED VALUES EXCEEDING +/- 10% FROM SCHEDULED DESIGN PARAMATERS UNLESS OTHERWISE NOTED BELOW.
 - -0% TO + 10% FOR EXHAUST SYSTEMS.
 - -0% TO + 10% FOR FRESH AIR SYSTEMS. -5% TO + 10% FOR FAN COIL UNIT SYSTEMS.
- SEE THE PROJECT SPECIFICATIONS FOR ADDITIONAL REQUIREMENTS.

SITE ELEVATION NOTES

THE BUILDING SITE IS LOCATED IN BOZEMAN, MONTANA AND IS APPROXIMATELY AT 4900 FEET ELEVATION ABOVE SEA LEVEL. ACCOUNT FOR THIS ELEVATION IN ALL EQUIPMENT SELECTIONS.

PROJECT SEISMIC RESTRAINT NOTES

- MECHANICAL/PLUMBING SYSTEMS AND EQUIPMENT ON THIS PROJECT SHALL BE INSTALLED WITH SEISMIC RESTRAINTS IN ACCORDANCE WITH THE 2006 INTERNATIONAL BUILDING CODE (SEISMIC USE GROUP 'III', SEISMIC DESIGN CATEGORY 'D', COMPONENT IMPORTANCE FACTOR 1.5) AND THE LATEST EDITION OF SMACNA'S SEISMIC RESTRAINT MANUAL. SPRINKLER SYSTEMS AND EQUIPMENT SHALL BE INSTALLED WITH SEISMIC RESTRAINTS IN ACCORDANCE WITH THE LATEST EDITION OF NFPA 13.
- THE CONTRACTOR SHALL BE RESPONSIBLE TO PROVIDE SHOP DRAWINGS AND PROFESSIONAL STRUCTURAL ENGINEER SEISMIC RESTRAINT DRAWINGS FOR REVIEW AND APPROVAL. SUBMIT SHOP DRAWING INFORMATION ON EACH MAJOR PIECE OF EQUIPMENT AND FOR EACH MAJOR CATEGORY OF COMMONLY INSTALLED EQUIPMENT.
- SEE SPECIFICATION SECTION 220548 AND 230548

DUCTWORK CONSTRUCTION SCHEDULE

- SUPPLY DUCTWORK SHALL BE CONSTRUCTED AS LOW-PRESSURE DUCTWORK OPERATING AT STATIC PRESSURES LESS THAN OR EQUAL TO 2" W.C.
- GREASE DUCTWORK SHALL BE CONSTRUCTED AS ZERO CLEARANCE PRE-MANUFACTURED GREASE DUCTWORK.
- INSULATED DUCTWORK SHALL INCLUDE THE FOLLOWING
 - ALL UN-LINED INTERIOR SUPPLY DUCTWORK
 - EXPOSED INTERIOR SUPPLY DUCTWORK IN PAINTED CEILING APPLICATIONS AND REQUIRING INSULATION SHALL BE PROVIDED AS BLACK OR WHITE PSK FACING W/O PRINT TO MATCH CEILING FINISH.
 - ALL EXHAUST DUCTWORK FROM THE BACKDRAFT DAMPER TO THE BUILDING EXTERIOR
- ALL FRESH AIR AND COMBUSTION AIR DUCTWORK

LINED DUCTWORK SHALL INCLUDE THE FOLLOWING

- ALL TRANSFER DUCTWORK
- ALL SUPPLY AND RETURN DUCTWORK WITHIN 15' OF FAN COIL UNITS.
- UN-INSULATED AND UN-LINED DUCTWORK SHALL INCLUDE THE FOLLOWING
 - ALL INTERIOR EXHAUST DUCTWORK UNLESS OTHERWISE NOTED ALL INTERIOR RETURN DUCTWORK UNLESS OTHERWISE NOTED
- ALL EXPOSED INTERIOR SUPPLY DUCTWORK DOWNSTREAM OF VAV TERMINAL UNITS AND WITHIN THE SPACE SERVED
- INSULATED FLEXIBLE DUCTWORK MAY BE USED AT THE CONTRACTOR'S OPTION FOR A MAXIMUM OF 5 FT. LENGTH TO EACH DIFFUSER/REGISTER/GRILLE UNLESS OTHERWISE NOTED.
- DUCT INSULATION SHALL BE 11/2-INCH FIBERGLASS INSULATION WITH MINIMUM R-VALUE OF 5 AND A HEAVY DUTY FSK VAPOR
- ACOUSTICAL DUCT LINER SHALL BE 1-INCH FIBERGLASS WITH REINFORCED ACRYLIC COATING TO MEET ASTM C 1071 WITH MINIMUM
- CONDUCTIVITY (K) NOT EXCEEDING 0.24 BTU PER INCH/H-SQ FT-°F.
- ALL DUCT DIMENSIONS SHOWN ON PLANS ARE CLEAR INTERIOR DIMENSIONS.
- 12. ALL INSULATION SYSTEMS SHALL NOT EXCEED THE 25/50 FLAME AND SMOKE SPREAD RATINGS AS DEFINED BY ASTM E 84.

CONTROL NOTES

- TEMPERATURE CONTROL CONTRACTOR TO PROVIDE BOX AND CONDUIT TO ACCESSIBLE CEILING SPACE FOR EACH THERMOSTAT.
- TEMPERATURE CONTROL CONTRACTOR TO PROVIDE AND START UP VARIABLE FREQUENCY DRIVES.
- SPACE ABOVE CEILING BEING USED AS A RETURN AIR PLENUM. TEMPERATURE CONTROL SYSTEM INSTALLATION SHALL UTILIZE PLENUM RATED CABLE.
- TEMPERATURE CONTROL CONTRACTOR SHALL BE FICO. SEE THE PROJECT SPECIFICATIONS FOR ADDITIONAL REQUIREMENTS.

BACKSHELF KITCHEN RANGE HOOD SCHEDULE

					<i>D1</i> (C 1 (C 1 11		31121110		01100 0.00		,	
PLAN CODE	MANUF.	MODEL NUMBER	RATING TYPE	HOOD DIMENSIONS (L" X W" X H")	MATERIA		MATERIAL	WEIGHT	REMARKS			
H-1	HALTON	6030ND-2-PSP-F	I	126" X 37" X 38"	HEAVY	1384	-1.002	14" X 8"	TANK FS	STAINLESS STEEL	1095	SEE NOTES
H-2	HALTON	6030ND-2-PSP-F	I	42" X 34" X 38"	HEAVY	701	-0.519	8" X 8"	TANK FS	STAINLESS STEEL	533	SEE NOTES

- IN ADDITION TO THE BASE COMPONENTS. DEVICES, AND ACCESSORIES LISTED IN THE DRAWINGS: THE FOLLOWING ARE TO BE PROVIDED AND INCLUDED WITH THE TYPE I HOOD AND FIELD COORDINATED A. COORDINATE THE EXHAUST OUTLET CONFIGURATION, SQUARE OR ROUND, PRIOR TO PROCURING. AVAILABLE SPACE ABOVE THE HOOD MAY NOT PERMIT A ROUND OUTLET.
- PRIOR TO PROCURING, FIELD COORDINATE THE HEIGHT OF THE FIELD WRAPPER, THE LOCATION OF THE EXHAUST OUTLETS, AND THE LOCATION OF THE SUPPLY INLETS (REFER TO MECHANICAL PLANS). HOOD SHALL BE PROVIDED WITH INSULATED STAINLESS STEEL BACKSPLASH AND TOP AND SIDES WHERE ADIACENT TO WALLS. UNLESS OTHERWISE NOTED. SEE ARCHITECTURAL AND FOOD SERVICE FINISH DRAWINGS FOR FURTHER REQUIREMENTS FIELD COORDINATE THE INSTALLATION WITH THE GENERAL CONTRACTOR AND
- HOOD TOP SHALL BE FACTORY PROVIDED WITH 3M FIRE WRAP FOR ZERO CLEARANCE TO COMBUSTIBLES. HOOD SIDES AND BACK WHERE ADJACENT TO A WALL SHALL BE FACTORY PROVIDED WITH INSULATION FOR ZERO CLEARANCE APPLICATION.
- MECHANICAL-TEMPERATURE CONTROL CONTRACTOR SHALL PROVIDE ALL LOW VOLTAGE WIRING AND TERMINATIONS ELECTRICAL CONTRACTOR SHALL PROVIDE AND INSTALL ALL LINE VOLTAGE WIRING AND CONDUIT. EC ALSO RESPONSIBLE FOR LOW VOLTAGE CONDUIT AND WIRE PULL COORDINATE WITH THE ELECTRICAL CONTRACTOR CONTROLS CONTRACTOR SHALL REMOVE THE HOOD CONTROLLER FOR EACH SYSTEM FROM THE FIELD MOUNTED CONTROL CABINET AND MOUNT IN 2-GANG BOX WHERE INDICATED ON THE DRAWINGS PROVIDE CAT-6 WIRING FROM CONTROL CABINET TO CONTROLLER.
- AN ANSUL PROTECTION SYSTEM SHALL BE PROVIDED AND INSTALLED WITHIN THE HOOD. FIRE PROTECTION SYSTEM SHALL BE PROVIDED WITH NECESSARY ACCESSORIES FOR CABLE ACTUATED GAS SUPPLY SHUT OFF. PROVIDE ANSUL HOSE ASSEMBLY AND OUTLET FOR MOVABLE KITCHEN EQUIPMENT WITH INTEGRAL FIRE PROTECTION PIPING. FIRE PROTECTION CONTRACTOR SHALL PROVIDE SHOP DRAWINGS FOR FINAL FIRE PROTECTION SYSTEM LAYOUT COORDINATE AND FIRE SUPPRESSION PIPE. ACTUATION WIRE CONDUIT AND FIRE SUPPRESSION PIPE SHALL BE FULLY CONCEALED IN WALLS
- AND CEILING SPACES. REFER TO FOOD SERVICE DRAWINGS FOR EQUIPMENT LAYOUT AND FURTHER REQUIREMENTS. A FACTORY AUTHORIZED SERVICE TECHNICIAN SHALL PERFORM THE STARTUP. COMMISSIONING. AND OWNER TRAINING OF THE TYPE I KITCHEN HOOD AND ASSOCIATED FIRE SUPPRESSION SYSTEM. COORDINATE SYSTEM TESTING WITH THE AUTHORITY HAVING JURISDICTION PROVIDE STARTUP AND TEXT REPORTS IN THE PROJECT
- REFER TO THE MECHANICAL DRAWINGS FOR LOCATION OF SYSTEMS AND FURTHER INSTRUCTIONS AND DETAILS.

KITCHEN MAKE UP AIR UNIT SCHEDULE

										171		4 1 17	IIIL GI	/ IIII G	1 41 1	5 C11	LDG								
PLAN	MANILIE	MANUF. MODEL NUMBER	MODEL NUMBER	MODEL NILIMBED	MODEL NILIMRED	MANUE MODEL NUMBER	SUPPLY FAN		N F	HEATING DATA - SCR ELECTRI			CTRIC	COOLING DATA (PACKAGED DX - R410A) ELECTRICAL DATA #1					ELECTRICAL DATA #2					UNIT	REMARKS
CODE	MANUF.	MODEL NUMBER	CFM	ESP	НР	DESIGN KW	DESIGN MBH	EAT	LAT	ТОТ МВН	SENS MBH	IEER	EAT DB/WB	LAT DB/WB	VOLTS	PH	MCA	MOP	MAX KW		VOLTS	PH	AMP	WEIGHT	KEMAKKS
MAU-1	CAPTIVEAIRE	CASRTU2-E.452-15-8T	1650	0.5	1.5	33	114	-20	55	66.4	61.8	20.2	88/62.2	45.5/45.6	208	3	34.8	35	45	33	208	3	108.3	1817	SEE NOTES

- ELECTRIC MAKE UP AIR UNIT WITH DIRECT EXPANSION COOLING SECTION. UNIT SHALL BE CONFIGURED WITH A MOTORIZED BACKDRAFT DAMPER, INTAKE HOOD WITH FILTER SECTION, DIRECT EXPANSION COOLING SECTION, ELECTRIC HEATING SECTION, AND DOWN DISCHARGE BLOWER ASSEMBLY
- UNIT POWER SHALL HAVE TWO (2) POINT ELECTRICAL CONNECTIONS WITH FACTORY DISCONNECTS. ONE POINT FOR UNIT FAN AND COOLING POWER AND ONE FOR ELECTRIC HEAT DATA.
- PROVIDE UNIT WITH 24" FIELD INSTALLED VIBRATION ISOLATED CURB (1.5" ISOLATOR). COORDINATE WITH UNIT PROFILE AND DISCHARGE CONFIGURATION AS REQUIRED.
- PROVIDE MEANS FOR MONITORING AND ALARM BY EXISTING BUILDING DDC CONTROL SYSTEM. COORDINATE WITH TEMPERATURE CONTROLS CONTRACTOR AS REQUIRED. A FACTORY AUTHORIZED SERVICE TECHNICIAN SHALL PREFORM THE STARTUP, COMMISSIONING, AND OWNER TRAINING OF THE MAKEUP AIR UNIT. PROVIDE STARTUP AND TEXT REPORTS IN THE ORM MANUALS.

EXHAUST FAN SCHEDULE

PLAN COD	MANUEACTURER	MODEL NUMBER	CEM	ESP	RPM	DDIVE TVDE		ELECTRIC	CAL DATA		STATIC EFFICIENCY	SONES	WEIGHT	CONTROL NOTES	ADEA CEDUED	DEMARKS
PLAN CODI	MANUFACTURER	MODEL NUMBER	Crivi	ESP	KPIVI	DRIVE TYPE	HP	VOLT	FLA	PH					AREA SERVED	REMARKS
EF-1	CAPTIVEAIRE	USBI13DD-RM	1384	1.5	1759	DIRECT	1	208	3.1	3	32%	16.9	293	CONTROLLED VIA HOOD	KITCHEN HOOD	SEE NOTES
EF-2	CAPTIVEAIRE	USBI11DD-RM	701	1.5	1964	DIRECT	0.5	208	1.9	3	33%	14.7	254	CONTROLLED VIA HOOD	KITCHEN HOOD	SEE ONTES

FAN SERVING TYPE 1 GREASE SYSTEM; INSTALL FAN PER NFPA 96. PROVIDE FAN WITH FACTORY MOUNTED DISCONNECT, GREASE CUP, AND CURB.

GRILLE - REGISTER - DIFFUSER SCHEDULE

PLAN CODE	MANUFACTURER	MODEL NUMBER	FUNCTION	FACE SIZE	MATERIAL	FINISH	CFM	VOLUME DAMPER	REMARKS	
SD-1	CAPTIVEAIRE	DI-PSP	SUPPLY	24" X 24"	STEEL	BAKED ENAMEL	SEE PLANS	IN DUCT	SEE NOTES	

PROVIDE ALL DUCT TRANSITIONS TO AND FROM GRILLES/REGISTERS/DIFFUSERS (GRD'S) AS REQUIRED.

CONTRACTOR TO VERIFY CEILING TYPE AND PROVIDE CORRECT FRAMES, CONNECTORS, AND FINISH TYPE AND COLOR FOR ALL AIR DIFFUSION PRODUCTS PRIOR TO PROCUREMENT. REFER TO ARCHITECTURAL REFLECTED CEILING PLANS FOR ALL TYPE AND LOCATIONS OF CEILINGS. PROVIDE MANUFACTURE STANDARD COLOR CHART WITH SHOP DRAWINGS. COLOR / FINISH SELECTION BY ARCHITECT.

REFER TO THE MECHANICAL DRAWINGS AND DETAILS FOR FURTHER REQUIREMENT.


MECHANICAL SYMBOLS LEGEND AIR TERMINALS, EQUIPMENT & SPECIALTIES **NEW EQUIPMENT EQUIPMENT TAG EXISTING TO REMAIN EQUIPMENT NUMBER** (REFER TO SCHEDULE) EXISTING EQUIP TO BE REMOVED OR **RELOCATED** DIFFUSER/GRILLE TAG SUPPLY AIR TERMINAL (NEW, EXIST. - AIR TERMINAL NUMBER AIR TERMINAL CFM (REFER TO SCHEDULE RETURN AIR TERMINAL (NEW, EXIST., DEMO.) EXHAUST AIR TERMINAL (NEW, EXIST., DEMO.) WALL LOUVER SIDEWALL AIR TERMINAL LINEAR SLOT AIR TERMINAL

DUCTWORK & ACCESSORIES

P.O.D.C. - POINT OF DISCONNECTION

P.O.C. - POINT OF CONNECTION

T'STAT. (ELEC./PNEU.)

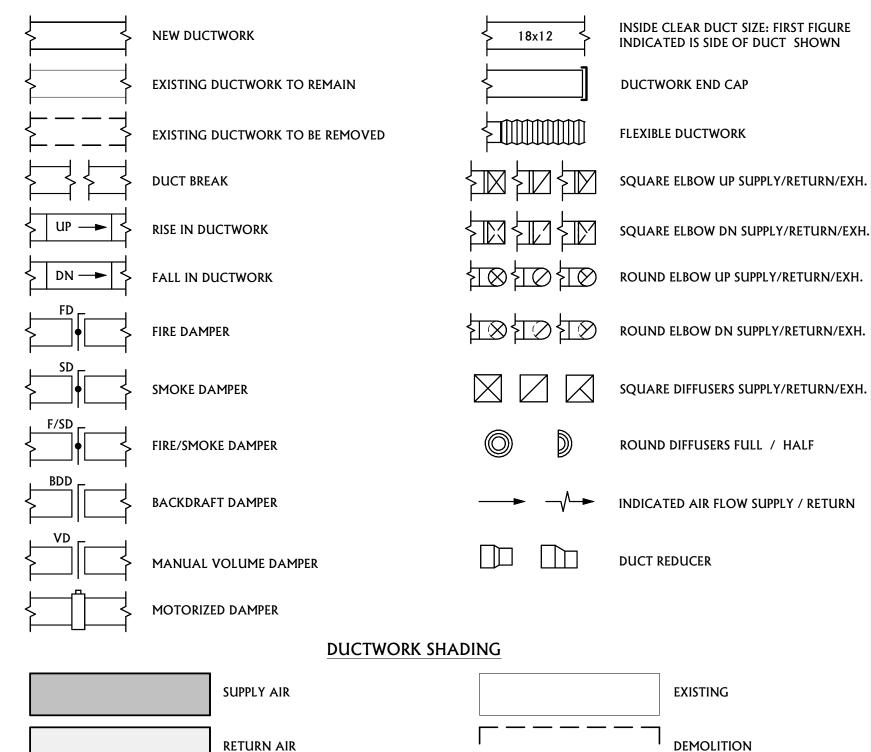

EXHAUST AIR

	HVAC/HYDR	ONIC PIPING	
	CHILLED WATER SUPPLY	STM	STEAM
	CHILLED WATER RETURN	LPS	LOW PRESSURE STEAM
	HOT WATER SUPPLY	MPS	MEDIUM PRESSURE STEAM
HWR	HOT WATER RETURN	———HPS———	HIGH PRESSURE STEAM
		— — — ·CD· — — —	CONDENSATE DRAIN
		LPC	LOW PRESSURE CONDENSATE
		MPC	MEDIUM PRESSURE CONDENSA
		——————————————————————————————————————	HIGH PRESSURE CONDENSATE
THI	S IS A STANDARDIZED SYMBOL	STEGEND ATT SYMBOLS SHOWN MAY	

MECHANICAL SHEET LIST


NOT APPEAR ON OR WITHIN THIS SET OF CONTRACT DOCUMENTS.

M1.0	MECHANICAL COVER SHEET AND SCHEDULES
M2.1	FIRST FLOOR MECHANICAL DEMO PLAN
M2.2	ROOF MECHANICAL DEMO PLAN
M3.1	FIRST FLOOR MECHANICAL REMODEL PLAN
M3.2	ROOF MECHANICAL REMODEL PLAN
M4.0	MECHANICAL DETAILS

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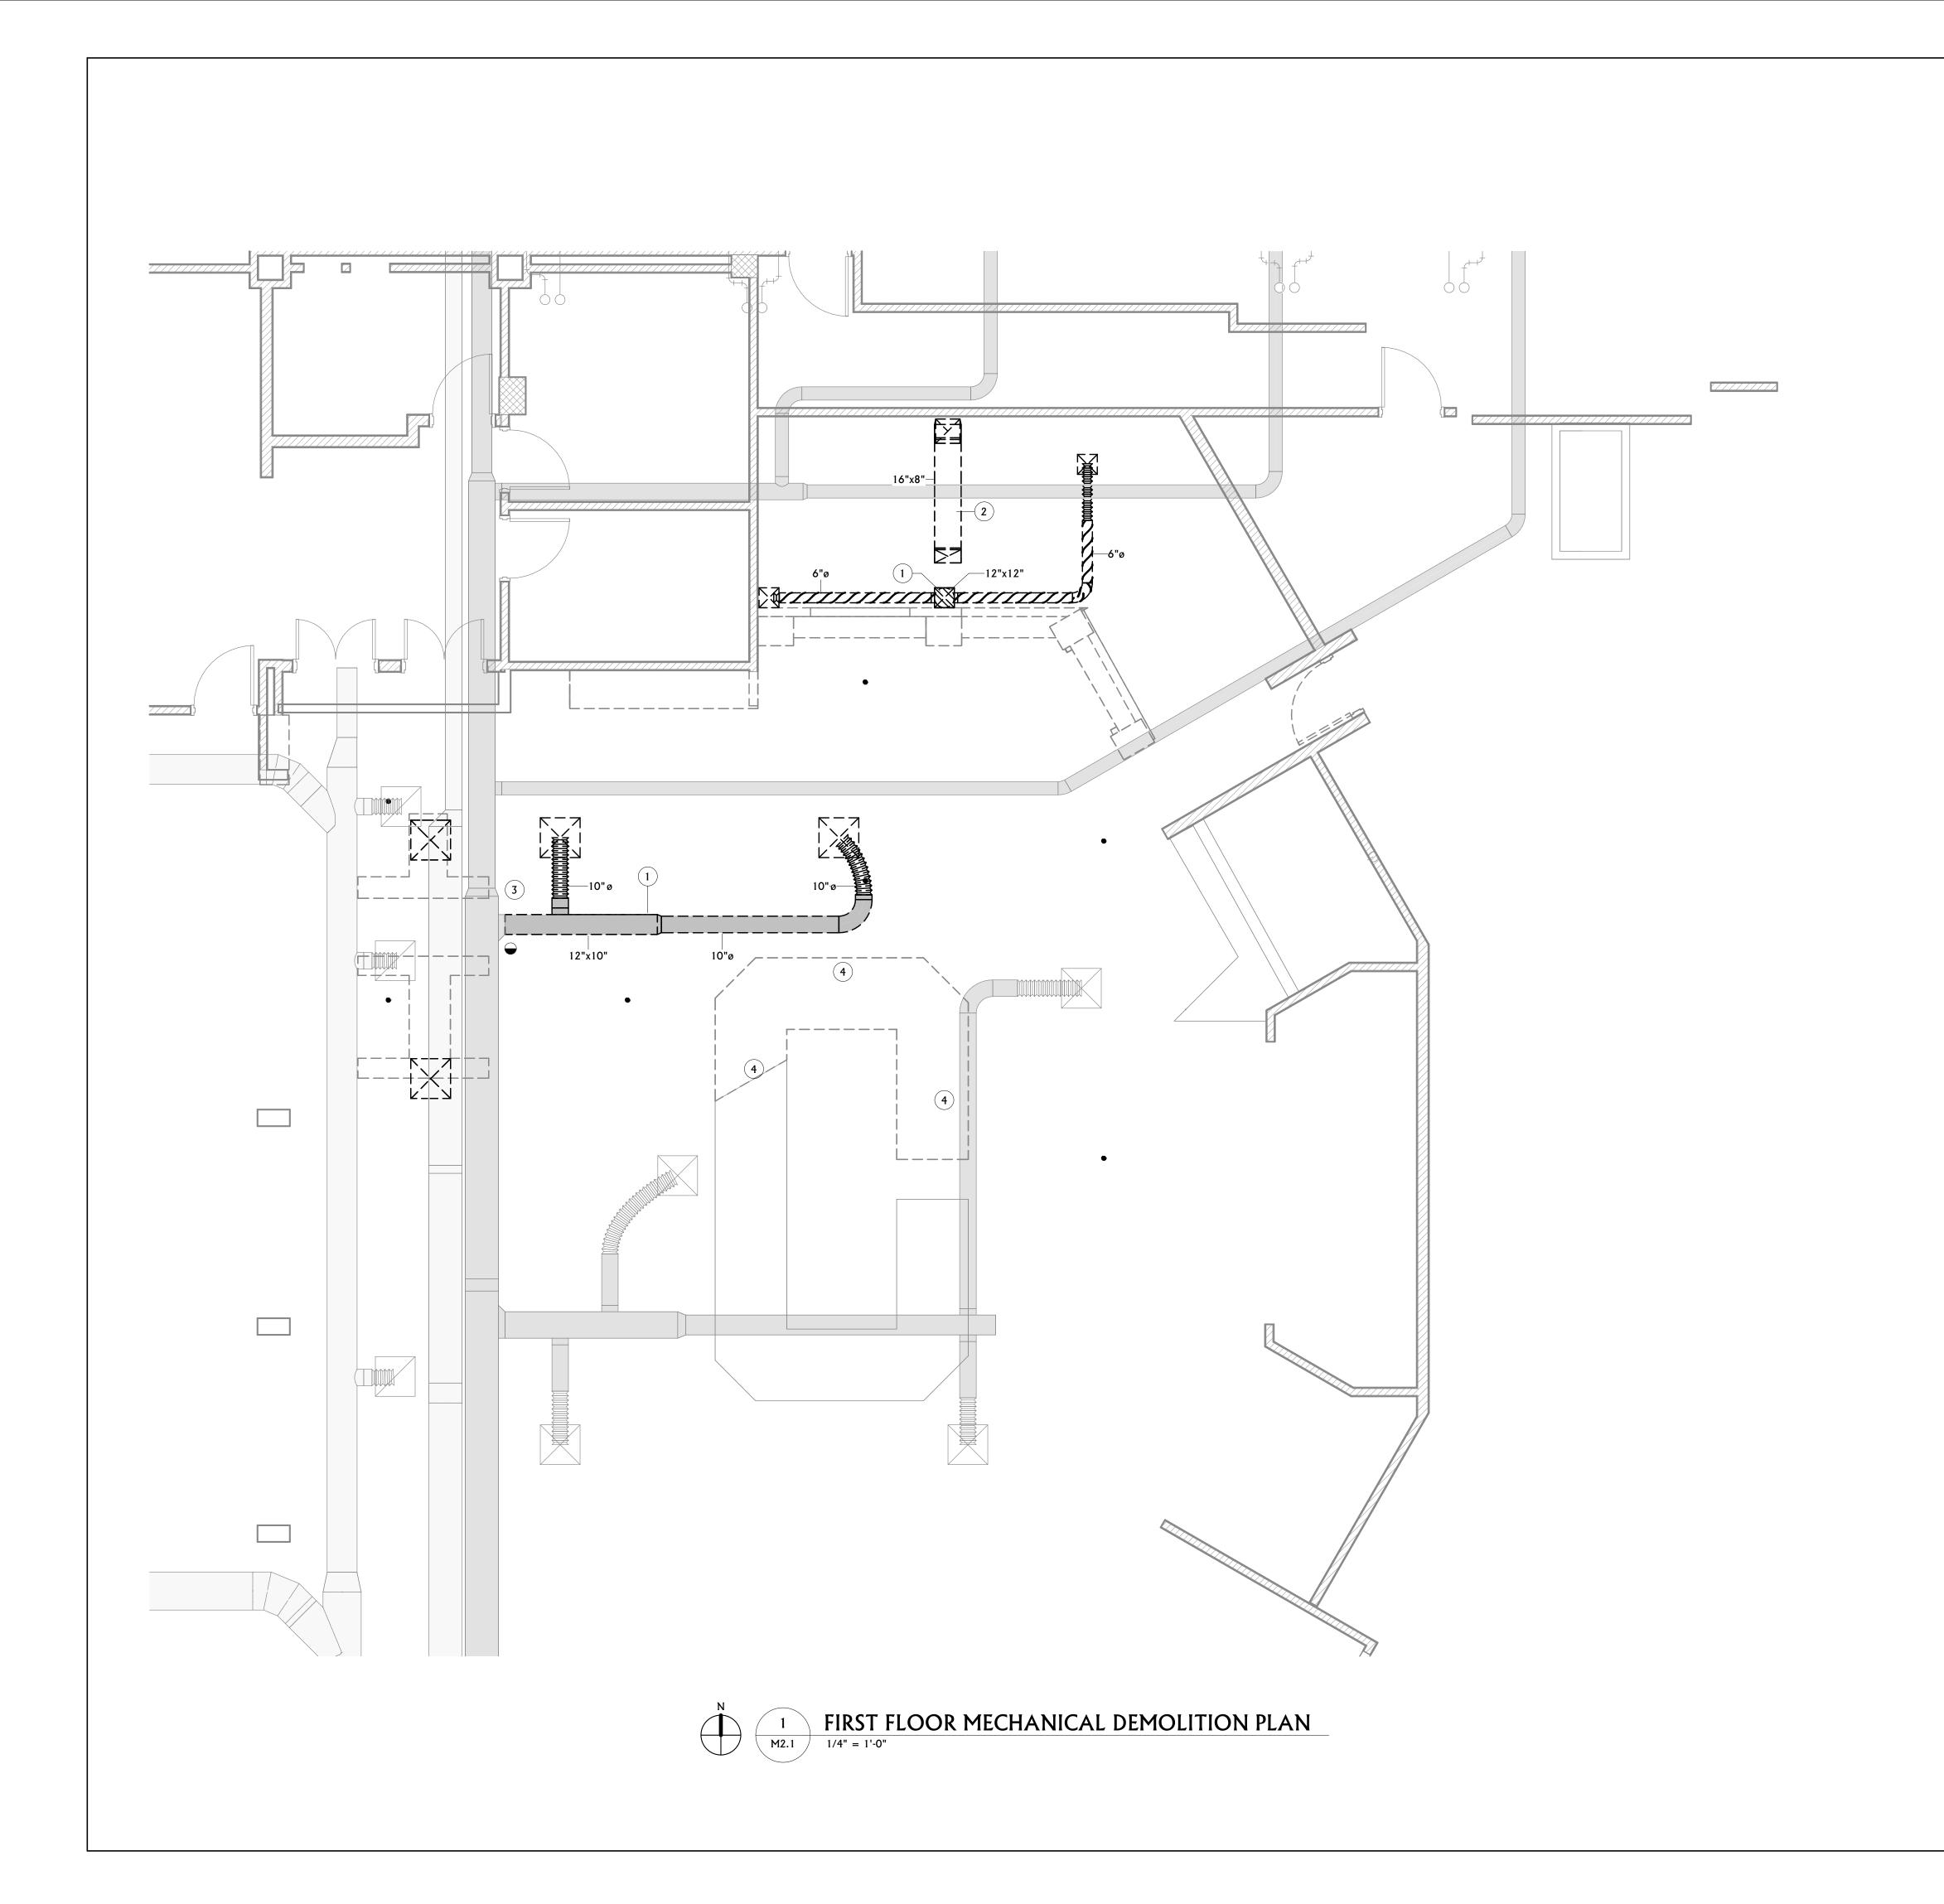
REV. DESCRIPTION DATE MSU COMMENT 05/04/ RESPONSES



PPA#22-0056 A/E#00-00-00 Consultant #:

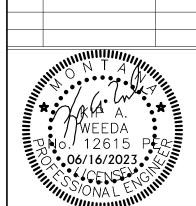SHEET TITLE MECHANICAL COVER SHEET AND

SCHEDULES SHEET




MECHANICAL GENERAL DEMOLITION NOTES

- A CONTRACTOR SHALL CUT ALL FLOORS, WALLS, CEILINGS, AND ROOF AS REQUIRED TO PERFORM THE WORK DEPICTED IN THESE CONTRACT DOCUMENTS AND SPECIFICATIONS. GENERAL CONTRACTOR SHALL PATCH ALL ASSOCIATED FLOORS, WALLS, CEILINGS, AND ROOF AS REQUIRED TO THE SATISFACTION OF THE ARCHITECT/ENGINEER.
- B COORDINATE HVAC AND PLUMBING EQUIPMENT WITH ALL OTHER TRADES AS
- C THE INFORMATION SHOWN ON THIS DRAWING WAS OBTAINED FROM EXISTING DRAWINGS AND FIELD OBSERVATIONS. FIELD VERIFY ALL EXISTING CONDITIONS AND PROVIDE DEMOLITION AS REQUIRED TO ACCOMMODATE EXISTING CONSTRUCTION.
- D NOTIFY THE OWNER OF ANY SYSTEM SHUT-DOWNS AND APPROXIMATE SHUT-DOWN TIME PRIOR TO COMMENCING WITH WORK.
- E CONTRACTOR SHALL REMOVE ALL DEMOLISHED MATERIALS FROM BUILDING, UNLESS SPECIFICALLY NOTED TO BE ABANDONED IN PLACE.
- F DRAWINGS SHOW GENERAL LOCATIONS OF MATERIALS TO BE REMOVED. IT SHALL BE THE CONTRACTORS RESPONSIBILITY TO DETERMINE THE EXTENT OF WORK REQUIRED FOR A COMPLETE SYSTEM REMOVAL
- G OWNER HAS FIRST RIGHT OF REFUSAL FOR ALL EQUIPMENT/MATERIAL CALLED OUT TO BE REMOVED. CONTRACTOR SHALL PRESENT ALL DEMO'D EQUIPMENT/MATERIAL TO OWNER PRIOR TO REMOVING FROM SITE.
- H DEMO ALL T-STATS AND CONTROLS ASSOCIATED WITH DEMO'D MECHANICAL EQUIPMENT.

MECHANICAL KEYNOTES

- DEMOLISH DUCTING LOCATED AT APPROXIMATE LOCATION
- DEMOLISH GREASE DUCTWORK LOCATED AT APPROXIMATE LOCATION. DISCONNECT DUCTWORK AT APPROXIMATE LOCATION.
- FOOD WELL AT APPROXIMATE LOCATION. REMOVE ASSOCIATED REFRIGERANT LIQUID AND SUCTION PIPING AND ASSOCIATED ACCESSORIES BACK TO REMOTE WATER COOLED CONDENSER RACK IN 224A. RECOVER EXISTING REFRIGERANT AS REQUIRED. COORDINATE WITH EXISTING CONDITIONS AS NECESSARY.

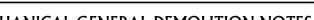




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SHEET TITLE FIRST FLOOR **MECHANICAL DEMO** PLAN

SHEET

M2.1

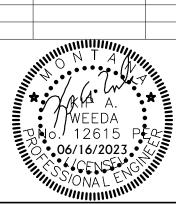

MECHANICAL GENERAL DEMOLITION NOTES

- A CONTRACTOR SHALL CUT ALL FLOORS, WALLS, CEILINGS, AND ROOF AS REQUIRED TO PERFORM THE WORK DEPICTED IN THESE CONTRACT DOCUMENTS AND SPECIFICATIONS. GENERAL CONTRACTOR SHALL PATCH ALL ASSOCIATED FLOORS, WALLS, CEILINGS, AND ROOF AS REQUIRED TO THE SATISFACTION OF THE ARCHITECT/ENGINEER.
- B COORDINATE HVAC AND PLUMBING EQUIPMENT WITH ALL OTHER TRADES AS
- C THE INFORMATION SHOWN ON THIS DRAWING WAS OBTAINED FROM EXISTING DRAWINGS AND FIELD OBSERVATIONS. FIELD VERIFY ALL EXISTING CONDITIONS AND PROVIDE DEMOLITION AS REQUIRED TO ACCOMMODATE EXISTING CONSTRUCTION.
- D NOTIFY THE OWNER OF ANY SYSTEM SHUT-DOWNS AND APPROXIMATE SHUT-DOWN TIME PRIOR TO COMMENCING WITH WORK.
- E CONTRACTOR SHALL REMOVE ALL DEMOLISHED MATERIALS FROM BUILDING, UNLESS SPECIFICALLY NOTED TO BE ABANDONED IN PLACE.

 F DRAWINGS SHOW GENERAL LOCATIONS OF MATERIALS TO BE REMOVED. IT SHALL BE
- THE CONTRACTORS RESPONSIBILITY TO DETERMINE THE EXTENT OF WORK REQUIRED FOR A COMPLETE SYSTEM REMOVAL.

 G OWNER HAS FIRST RIGHT OF REFUSAL FOR ALL EQUIPMENT/MATERIAL CALLED OUT TO BE REMOVED. CONTRACTOR SHALL PRESENT ALL DEMO'D EQUIPMENT/MATERIAL TO
- OWNER PRIOR TO REMOVING FROM SITE.

 H DEMO ALL T-STATS AND CONTROLS ASSOCIATED WITH DEMO'D MECHANICAL

MECHANICAL KEYNOTES

- FAN LOCATED AT APPROXIMATE LOCATION TO BE DEMOLISHED.
- 2 ROOF PENETRATION LOCATED AT APPROXIMATE LOCATION TO BE BLOCKED OFF AND SEALED.
- ROOFTOP EQUIPMENT LOCATED AT APPROXIMATE LOCATION. PROVIDED FOR REFERENCE.

EQUIPMENT.

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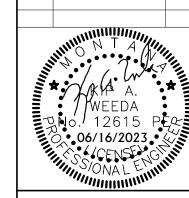
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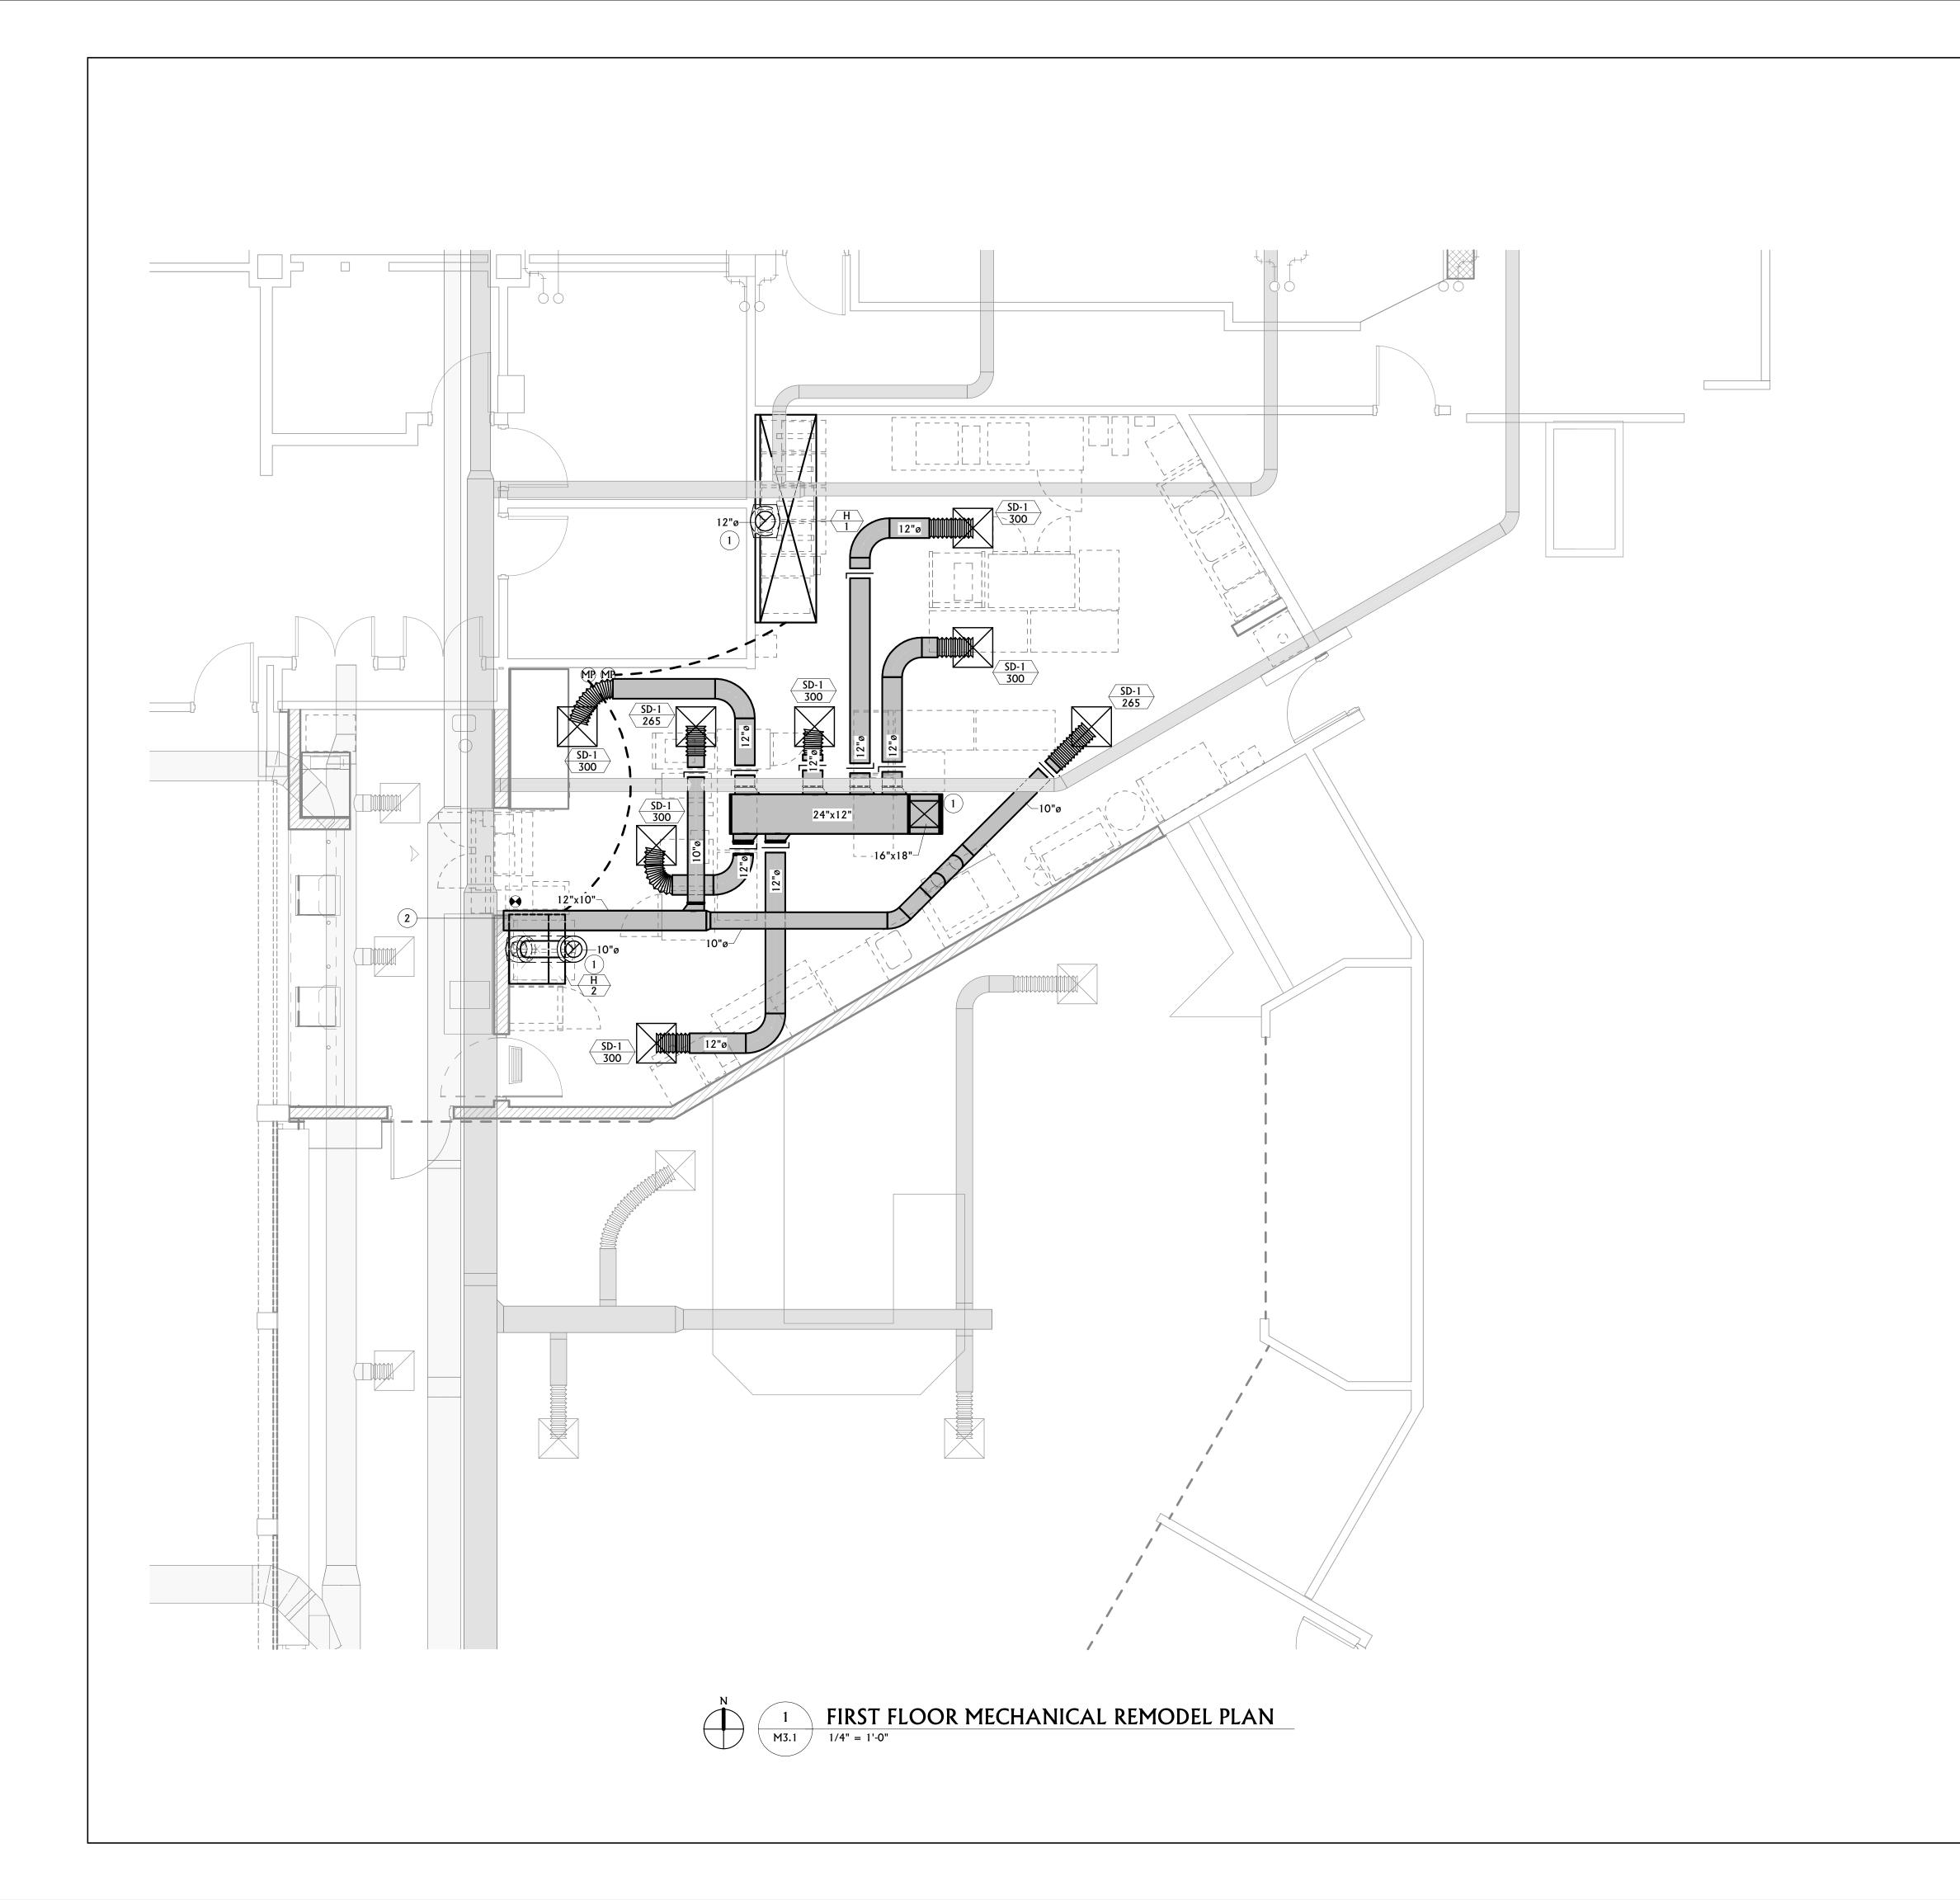


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SHEET TITLE ROOF MECHANICAL DEMO PLAN

SHEET

M2.2



MECHANICAL GENERAL NOTES

- A GENERAL CONTRACTOR SHALL CUT ALL FLOORS, WALLS, CEILINGS, AND ROOF AS REQUIRED TO PERFORM THE WORK DEPICTED IN THESE CONTRACT DOCUMENTS AND SPECIFICATIONS. GENERAL CONTRACTOR SHALL PATCH ALL ASSOCIATED FLOORS, WALLS, CEILINGS, AND ROOF AS REQUIRED TO THE SATISFACTION OF THE ARCHITECT/ENGINEER.
- B COORDINATE EXACT LOCATION OF DIFFUSERS AND GRILLES WITH REFLECTED CEILING PLAN AND LIGHTING LAYOUT.
- C FLEX DUCT RUN OUTS SHALL BE LIMITED TO 5'-0".
- D COORDINATE HVAC AND PLUMBING EQUIPMENT WITH ALL OTHER TRADES AS
- REQUIRED.
 - E ALL CEILING DIFFUSERS TO BE 4-WAY UNLESS OTHERWISE NOTED.
- F DUCT PENETRATIONS THROUGH ROOF TO BE COORDINATED WITH JOIST LAYOUT. G ALL DUCTS ABOVE CORRIDOR AREAS TO BE MINIMUM 24 GAUGE SHEET METAL.
- H PROVIDE FLUSH CUP CONCEALED OPERATORS ON ALL HAND DAMPERS LOCATED ABOVE HARD CEILINGS.
- LINE ALL SUPPLY AND RETURN DUCTS WITH 1" A.L. WITHIN 15' OF FANS. ALL DUCT DIMENSIONS SHOWN ON PLANS ARE CLEAR INTERIOR DIMENSIONS. K PROVIDE LOCKING COVERS FOR ALL THERMOSTATS/SENSORS.
- L PROGRAMMABLE THERMOSTATS SHALL BE PROVIDED WITH NEW BATTERIES AT TIME OF
- SUBSTANTIAL COMPLETION. M PROVIDE ACCESS PANELS FOR EACH FIRE DAMPER PER IMC STANDARDS/REQUIREMENTS.
- N VERIFY EXACT LOCATION OF T-STATS WITH ARCHITECT PRIOR TO INSTALLATION.
- O SEAL ALL MECHANICAL PENETRATIONS THROUGH FIRE RATED ASSEMBLIES WITH UL-APPROVED FIRE RATED SYSTEM.

MECHANICAL KEYNOTES

EXTEND DUCT UP THROUGH ROOF ABOVE. SEE 1/M3.2 FOR COORDINATION. CONNECT NEW DUCTWORK AT APPROXIMATE LOCATION.




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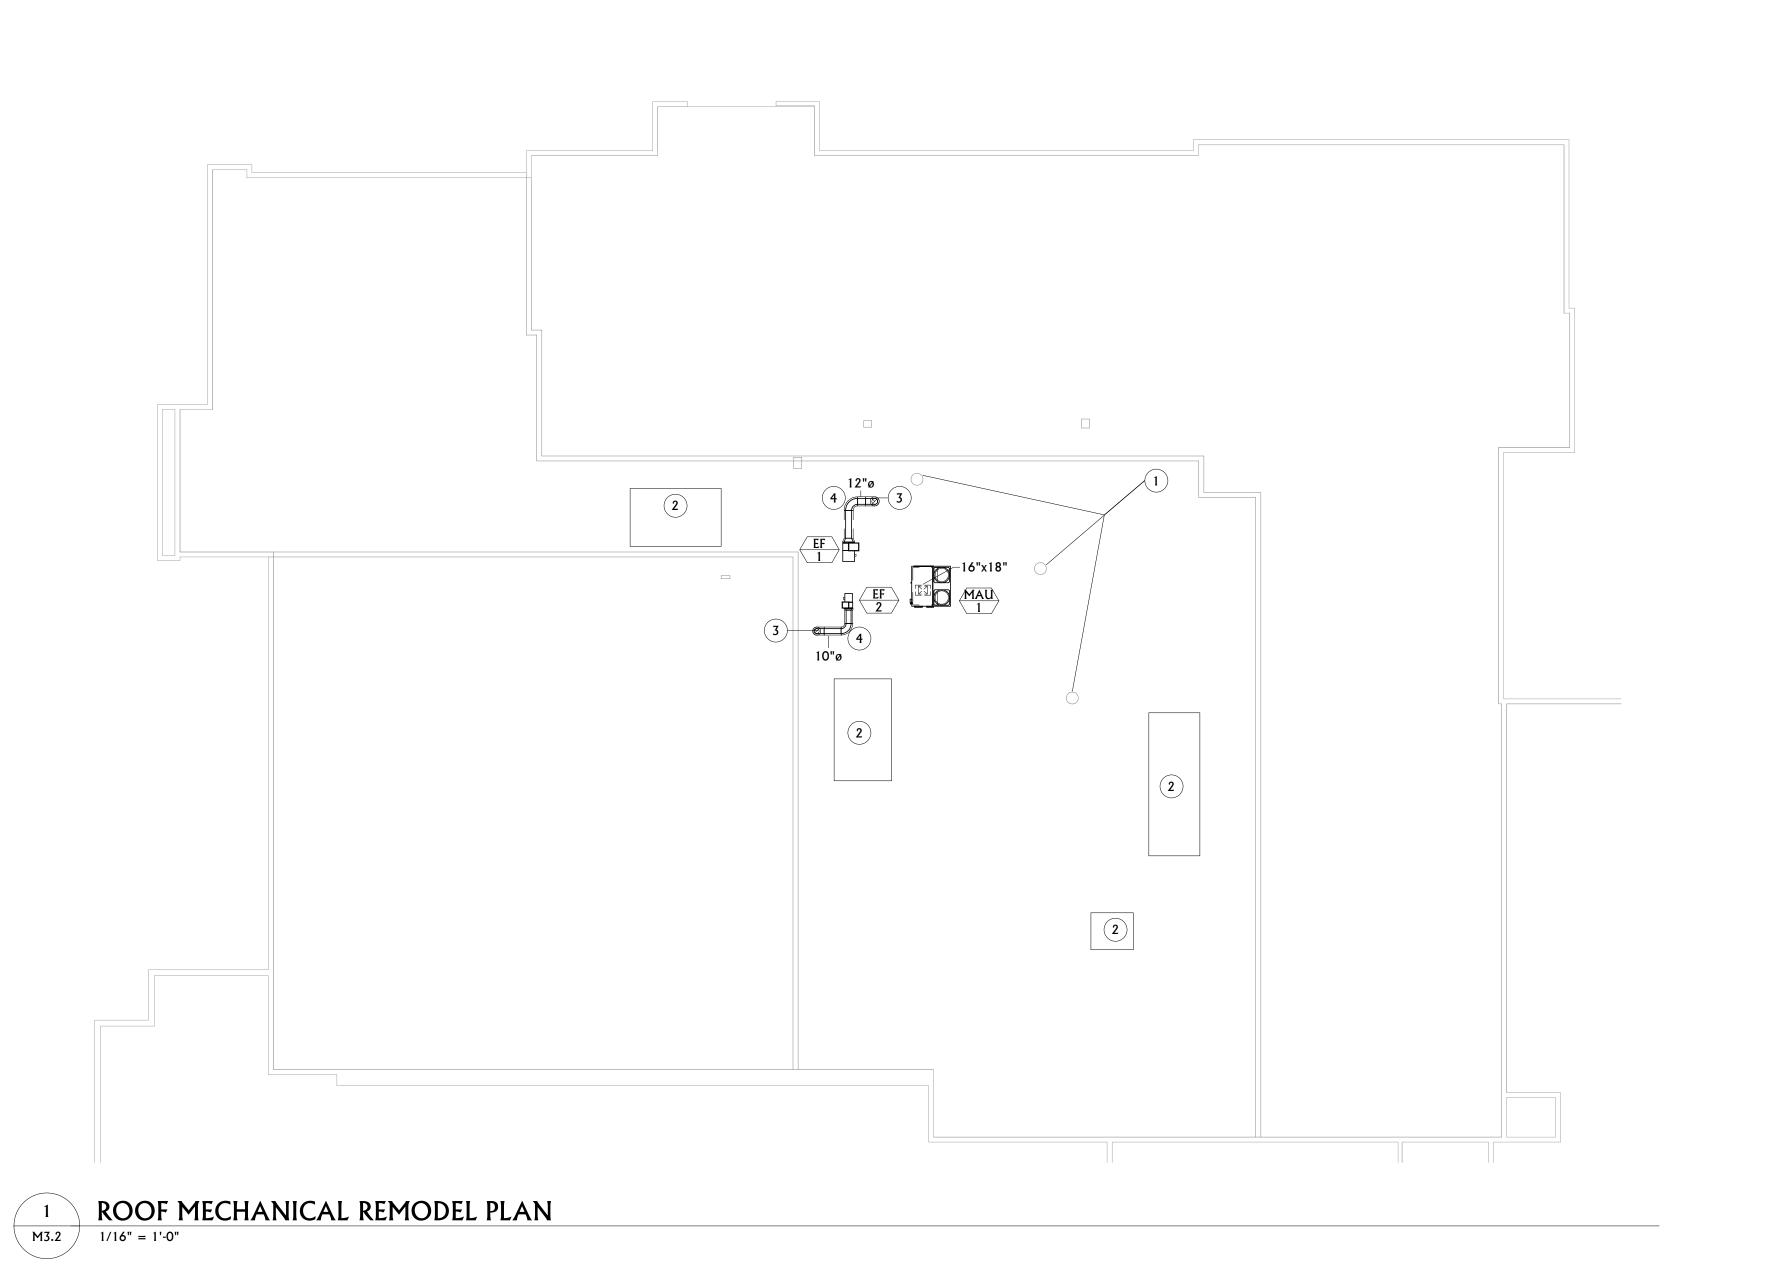


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SHEET TITLE FIRST FLOOR **MECHANICAL**

REMODEL PLAN SHEET

M3.1

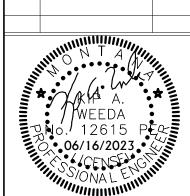

MECHANICAL GENERAL NOTES

- A GENERAL CONTRACTOR SHALL CUT ALL FLOORS, WALLS, CEILINGS, AND ROOF AS REQUIRED TO PERFORM THE WORK DEPICTED IN THESE CONTRACT DOCUMENTS AND SPECIFICATIONS. GENERAL CONTRACTOR SHALL PATCH ALL ASSOCIATED FLOORS, WALLS, CEILINGS, AND ROOF AS REQUIRED TO THE SATISFACTION OF THE ARCHITECT/ENGINEER.
- B COORDINATE EXACT LOCATION OF DIFFUSERS AND GRILLES WITH REFLECTED CEILING PLAN AND LIGHTING LAYOUT.
- C FLEX DUCT RUN OUTS SHALL BE LIMITED TO 5'-0".
- D COORDINATE HVAC AND PLUMBING EQUIPMENT WITH ALL OTHER TRADES AS
- REQUIRED.
- E ALL CEILING DIFFUSERS TO BE 4-WAY UNLESS OTHERWISE NOTED.
- F DUCT PENETRATIONS THROUGH ROOF TO BE COORDINATED WITH JOIST LAYOUT. G ALL DUCTS ABOVE CORRIDOR AREAS TO BE MINIMUM 24 GAUGE SHEET METAL.
- H PROVIDE FLUSH CUP CONCEALED OPERATORS ON ALL HAND DAMPERS LOCATED ABOVE HARD CEILINGS.
- I LINE ALL SUPPLY AND RETURN DUCTS WITH 1" A.L. WITHIN 15' OF FANS. ALL DUCT DIMENSIONS SHOWN ON PLANS ARE CLEAR INTERIOR DIMENSIONS.
- K PROVIDE LOCKING COVERS FOR ALL THERMOSTATS/SENSORS. L PROGRAMMABLE THERMOSTATS SHALL BE PROVIDED WITH NEW BATTERIES AT TIME OF
- SUBSTANTIAL COMPLETION. M PROVIDE ACCESS PANELS FOR EACH FIRE DAMPER PER IMC STANDARDS/REQUIREMENTS.
- N VERIFY EXACT LOCATION OF T-STATS WITH ARCHITECT PRIOR TO INSTALLATION. O SEAL ALL MECHANICAL PENETRATIONS THROUGH FIRE RATED ASSEMBLIES WITH UL-APPROVED FIRE RATED SYSTEM.

MECHANICAL KEYNOTES

- EXISTING PLUMBING VENT LOCATED AT APPROXIMATE LOCATION.
- ROOFTOP EQUIPMENT LOCATED AT APPROXIMATE LOCATION. PROVIDED FOR REFERENCE.
- PROVIDE DUCT CLEAN OUT AT TOP AND ELBOW AT APPROXIMATE LOCATION.
- PROVIDE GREASE DUCT CLEAN OUT AT ELBOW.



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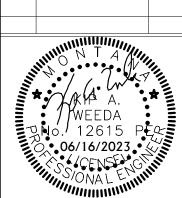
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CONSTRUCTION DOCUMENTS



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1 MSU COMMENT 05/04/
RESPONSES 23




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SHEET TITLE ROOF MECHANICAL **REMODEL PLAN**

SHEET

M3.2

CEILING GRILLE SUPPORT DETAIL

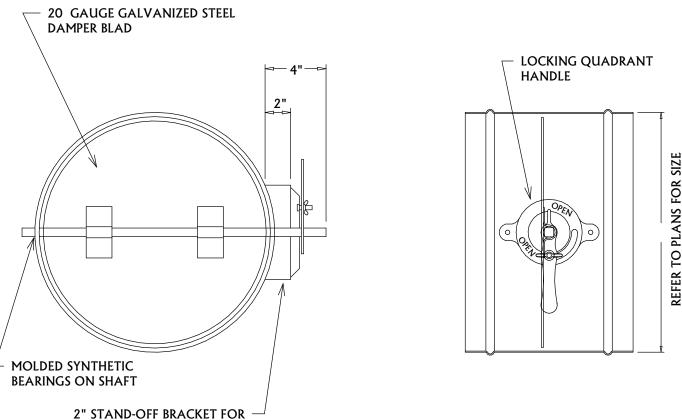

THE MAKEUP AIR UNIT MANUFACTURER/SUPPLIER SHALL FURNISH THE MAKEUP AIR HEATING AND COOLING UNIT WITH CONTROLS FOR INTEGRATION INTO THE EXISTING BUILDING DDC SYSTEM. THE TEMPERATURE CONTROLS CONTRACTOR SHALL PROVIDE WIRING AND PROGRAMMING AS REQUIRED FOR PROPER OPERATION OF THE MAKEUP AIR SYSTEM.

THE SYSTEM CONTROLS SHALL INCLUDE, AT A MINIMUM, THE FOLLOWING DEVICES, OPTIONS, AND SAFETIES:

- A SPACE THERMOSTAT.
- 2. AN OUTDOOR AIR TEMPERATURE SENSOR. DISCHARGE DUCT THERMOSTAT.
- BUILDING AUTOMATION SYSTEM CONNECTION.

CONTROL SEQUENCE:

KITCHEN HOODS/EXHAUST FANS:

1. EXHAUST FAN (EF-#) SHALL BE ENABLED FROM ITS RESPECTIVE HOOD CONTROL PANEL OR HOOD TEMPERATURE SENSOR.

MAKEUP AIR UNIT:

- MAKEUP AIR UNIT (MAU-1) SHALL BE CALLED TO RUN BY ANY RESPECTIVE HOOD EXHAUST FAN IN THE SPACE IT FEEDS AS SENSED THROUGH A SET OF CONTACTS AT ITS ASSOCIATED
- BEFORE ENABLING THE MAKEUP AIR UNIT SUPPLY FAN, ITS ASSOCIATED LOUVER DAMPER SHALL BE OPENED. PROOF OF DAMPER OPENING WILL ENABLE MAKEUP AIR SUPPLY FANS. PROVIDE MAKEUP AIR UNIT WITH A ROOM TEMPERATURE SENSOR. ROOM THERMOSTAT WILL DETERMINE UNIT HEATING OR COOLING MODE. ROOM SETPOINT SHALL BE ADJUSTABLE THROUGH THE BAS ONLY. HEATING/COOLING SWITCHOVER WILL OCCUR UPON A CONTINUOUS CALL FOR HEATING/COOLING FOR 10 MINUTES (ADJ.).

HEATING MODE:


A. THE MAKEUP AIR UNIT SCR ELECTRIC HEAT WILL ENABLE AND MODULATE TO MAINTAIN THE COMMANDED DISCHARGE AIR TEMPERATURE.

- A. THE MAKEUP AIR UNIT WILL OPERATE IT'S PACKAGED DX COOLING SYSTEM TO MAINTAIN THE COMMANDED DISCHARGE AIR TEMPERATURE.
- 4. IF NO EXHAUST FANS IN THE SPACE ARE IN OPERATION, MAKEUP AIR UNIT SHALL BE OFF AND OUTSIDE AIR DAMPER SHALL BE CLOSED.

SAFETIES:

- AN INLET DUCT THERMOSTAT WILL SENSE THE OUTDOOR AIR TEMPERATURE AND LOCKOUT THE MAKEUP AIR ELECTRIC ELEMENT WHEN THE OUTDOOR AIR IS ABOVE 60F
- A DISCHARGE THERMOSTAT WILL SENSE THE SUPPLY AIR TEMPERATURE AND SHALL PROVIDE LOW LIMIT CONTROL. IF SUPPLY AIR TEMPERATURE DROPS BELOW 40F (ADJUSTABLE) FOR 2 MINUTES (ADJUSTABLE), UNIT SHALL STOP AND OUTSIDE AIR DAMPER SHALL CLOSE. SYSTEM SHALL AUTO RESET WITH FOR TWO ATTEMPTS WITHIN 30 MINUTES. UPON A THIRD FAILURE WITHIN 30 MINUTES, AN ALARM SHALL BE GENERATED AND RESET SHALL BE MANUAL THROUGH THE BUILDING DDC SYSTEM.
- THE OUTSIDE AIR DAMPER SHALL SPRING CLOSE ON A LOSS OF POWER. UPON ACTIVEATION OF A HOOD FIRE SUPPRESSION SYSTEM, THE ASSOCIATED MAKEUP AIR UNIT SHALL DISABLE. ALL EHXUAST FANS ASSOCIATED WITH THE SAME CONTROL SYSTEM
- SHALL ENABLE IF OFF AND RUN AT MAXIMUM SETPOINT UNITL THE SYSTEM IS RESET.

MAKE-UP AIR UNIT CONTROLS DETAIL

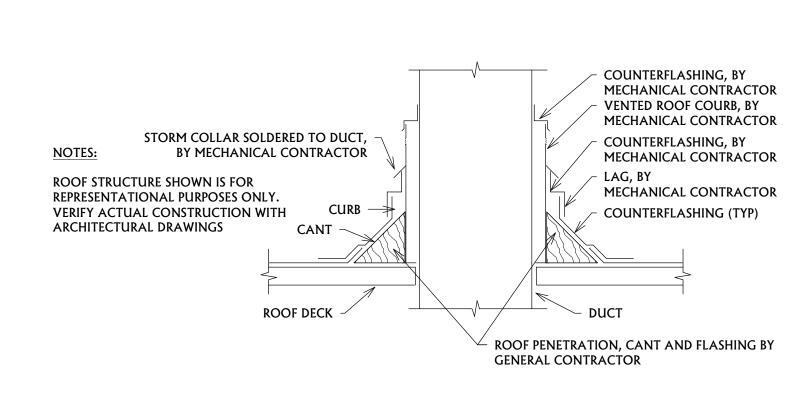


MANUAL DAMPER DETAIL

EXTERNAL INSULATED DUCT

VENTED ROOF DUCT PENETRATION DETAIL

TYPICAL ANSUL R102 SYSTEM LAYOUT WITH MOUNTED AUTOMAN

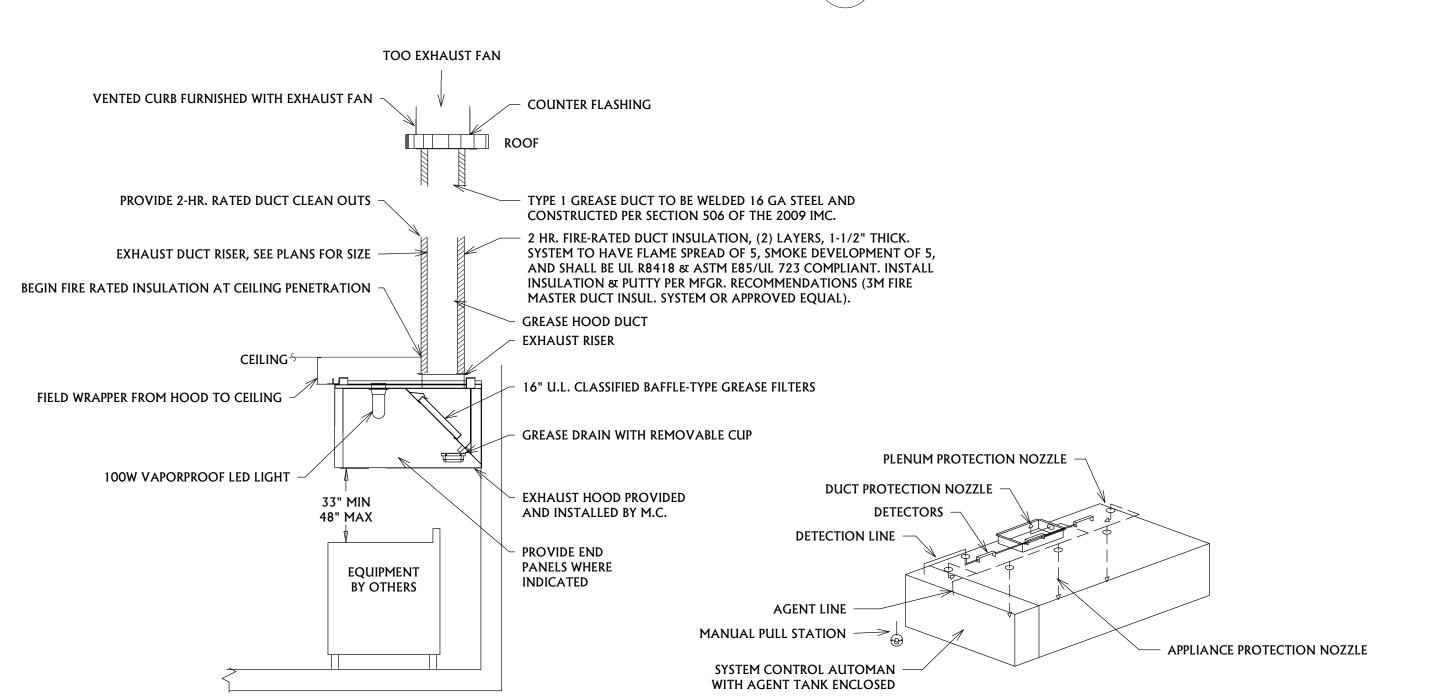

← EXHAUST FAN - KITCHEN GREASE HOOD ANSUL R102 FIRE EXHAUST SEE 5/M4.0 SUPPRESSION SYSTEM - HEAT DETECTOR FACTORY INSTALLED FIELD WIRED (BY MECHANICAL CONTRACTOR) MAKE-UP / AIR UNIT **EXHAUST SYSTEM** DIGITAL CONTROL PANEL DISCHARGE DUCT -

THERMOSTAT


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A/E#00-00-00 Consultant #:

SHEET TITLE **MECHANICAL DETAILS**

SHEET

06.16.2023

PIPING MATERIALS SCHEDULE

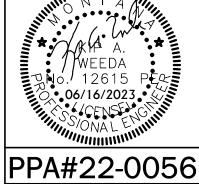DOMESTIC WATER PIPING (DOMESTIC COLD WATER, HOT WATER, HOT WATER RECIRCULATION): FOR ABOVE GROUND DOMESTIC SERVICE WATER PIPING CONTRACTOR SHALL PROVIDE ANY OF THE FOLLOWING:

-HARD COPPER TUBE, TYPE L; CAST-OR WROUGHT-COPPER, SOLDER-JOINT FITTINGS; AND SOLDERED JOINTS. -HARD COPPER TUBE, TYPE L; COPPER PRESSURE-SEALED-JOINT FITTINGS, AND PRESSURE SEALED JOINTS.

FOR BELOW GROUND DOMESTIC WATER PIPING CONTRACTOR SHALL PROVIDE ANY OF THE FOLLOWING:

-SOFT COPPER TUBE, TYPE K; CAST-OR WROUGHT-COPPER, SOLDER-JOINT FITTINGS; AND SOLDERED JOINTS. -SOFT COPPER TUBE. TYPE K: COPPER PRESSURE-SEALED-JOINT FITTINGS. AND PRESSURE SEALED JOINTS.

INDOOR DOMESTIC COLD WATER PIPING 2" AND SMALLER SHALL BE PROVIDED WITH 1" FIBERGLASS INSULATION WITH ASJ VAPOR BARRIER. INDOOR DOMESTIC HOT WATER PIPING 1 1/2" AND SMALLER SHALL BE PROVIDED WITH 1" FIBERGLASS INSULATION WITH ASJ VAPOR RAPPIER

INDOOR DOMESTIC HOT WATER RECIRCULATION PIPING SHALL BE PROVIDE WITH 1" FIBERGLASS INSULATION WITH ASJ VAPOR BARRIER.

CEILING SPACE IS UTILIZED AS A RETURN AIR PLENUM. ALL PIPING INSULATION SHALL HAVE A FLAME SPREAD NOT EXCEEDING 25, A SMOKE DEVELOPMENT RATING NOT EXCEEDING 50, AND CONDUCTIVITY (K) NOT EXCEEDING 0.27 BTU PER INCH/H-SQ FT-°F.

SANITARY WASTE AND VENT PIPING:

CONTRACTOR SHALL PROVIDE ANY OF THE FOLLOWING FOR UNDERGROUND SANITARY WASTE AND VENT PIPING:

-SOLID-WALL CPVC PIPE, DWV PATTERN CPVC SOCKET FITTINGS, AND SOLVENT-CEMENTED JOINTS.

CONTRACTOR SHALL PROVIDE ANY OF THE FOLLOWING FOR ABOVE GROUND SANITARY WASTE AND VENT:

-SOLID-WALL CPVC PIPE, DWV PATTERN CPVC SOCKET FITTINGS, AND SOLVENT-CEMENTED JOINTS.

CONTRACTOR SHALL PROVIDE ANY OF THE FOLLOWING FOR ABOVE GROUND GREASE WASTE AND VENT PIPING.

-SOLID-WALL CPVC PIPE, DWV PATTERN CPVC SOCKET FITTINGS, AND SOLVENT-CEMENTED JOINTS.

CEILING SPACE IS UTILIZED AS A RETURN AIR PLENUM. ALL PIPING INSULATION SHALL HAVE A FLAME SPREAD NOT EXCEEDING 25, A SMOKE DEVELOPMENT RATING NOT EXCEEDING 50, AND CONDUCTIVITY (K) NOT EXCEEDING 0.27 BTU PER INCH/H-SQ FT-°F.

FIRE CAULKING

FIRE CAULK/SEAL ALL PENETRATIONS THROUGH RATED WALLS AND FLOORS AS NEEDED TO PREVENT THE PASSAGE OF SMOKE. SEE M5-02 FOR FIRE CAULKING DETAILS.

GENERAL PLUMBING NOTES

- 1. ALL NEW PIPING, FITTINGS, VALVES, AND FIXTURES FOR DOMESTIC WATER SERVICE SHALL COMPLY WITH THE REDUCTION OF LEAD IN DRINKING WATER ACT OF 2011 WHICH IS BEING ENFORCED AS OF JANUARY 4, 2014.
- 2. PLUMBING CONTRACTOR SHALL PROVIDE FOR FIRE STOPPING OF ALL PLUMBING PENETRATIONS OF RATED WALLS & FLOORS. SEE X/PX.X FOR FIRE STOP DETAILS.
- 3. ALL FLOOR DRAINS AND FLOOR SINKS SHALL BE INSTALLED FLUSH WITH THE FINISHED FLOOR. FLOOR SINIKS SHALL BE UTILIZED AS INDIRECT DRAINS AND AREA DRAINS.
- 4. PROVIDE WATER HAMMER ARRESTORS ON ALL LINES SERVING WASHING MACHINES AND/OR FLUSH VALVE FIXTURES.

FOOD SERVICE NOTES

ALL FOOD SERVICE EQUIPMENT INDICATED ON THE FOOD SERVICE DRAWINGS IS TO BE PROVIDED BY OTHERS AND PLUMBED BY THE PLUMBING CONTRACTOR. PROVIDE ALL REQUIRED VALVES AND ACCESSORIES TO PROVIDE A COMPLETE AND WORKABLE SYSTEM. PLUMBING CONTRACTOR SHALL BE RESPONSIBLE FOR PROVIDING AND INSTALL ALL FLOOR DRAINS AND FLOOR SINKS AS SHOWN AND LOCATED ON THE FOOD SERVICE DRAWINGS. INSTALL ALL EQUIPMENT PER THE MANUFACTURER'S INSTRUCTIONS/RECOMMENDATIONS. PLUMBING LINES SERVING FOOD SERVICE EQUIPMENT SHALL BE SECURED TO WALLS OR EQUIPMENT WHEN RECOMMENDED BY THE FOOD SERVICE CONTRACTOR. PLUMBING LINES SHALL NOT BE SECURED TO THE KITCHEN FLOORS. CONTRACTOR SHALL REFER TO THE FOOD SERVICE DRAWINGS FOR ADDITIONAL PLUMBING REQUIREMENTS.

PROJECT SEISMIC RESTRAINT NOTES

- 1. MECHANICAL/PLUMBING SYSTEMS AND EQUIPMENT ON THIS PROJECT SHALL BE INSTALLED WITH SEISMIC RESTRAINTS IN ACCORDANCE WITH THE 2021 INTERNATIONAL BUILDING CODE (SEISMIC USE GROUP 'III', SEISMIC DESIGN CATEGORY 'D', COMPONENT IMPORTANCE FACTOR 1.5) AND THE LATEST EDITION OF SMACNA'S SEISMIC RESTRAINT MANUAL. SPRINKLER SYSTEMS AND EQUIPMENT SHALL BE INSTALLED WITH SEISMIC RESTRAINTS IN ACCORDANCE WITH THE LATEST EDITION OF NFPA 13.
- 2. THE CONTRACTOR SHALL BE RESPONSIBLE TO PROVIDE SHOP DRAWINGS AND PROFESSIONAL STRUCTURAL ENGINEER SEISMIC RESTRAINT DRAWINGS FOR REVIEW AND APPROVAL. SUBMIT SHOP DRAWING INFORMATION ON EACH MAJOR PIECE OF EQUIPMENT AND FOR EACH MAJOR CATEGORY OF COMMONLY INSTALLED EQUIPMENT.
- 3. SEE SPECIFICATION SECTION 220548 AND 230548.

FIRE SPRINKLER NOTES & LEGEND

FIRE SPRINKLER PERFORMANCE SPECIFICATION NOTES:

- 1. THE INTENT OF THESE DRAWINGS ARE TO PROVIDE PERFORMANCE BASED GUIDELINES FOR FIRE SPRINKLER HEAD PLACEMENT AND PIPE ROUTING IN CRITICAL AREAS. THE FIRE SPRINKLER CONTRACTOR IS RESPONSIBLE DESIGN OF THE NEW FIRE SPRINKLER SYSTEMS, PREPARATION OF FINAL SHOP DRAWINGS BASED ON THE PROCEEDING NOTES, DRAWINGS, AND THE PROJECT SPECIFICATIONS, AND THE COMPLETE INSTALLATION OF THE FIRE SPRINKLER SYSTEM WHICH MEETS ALL OF THE REQUIREMENTS OUTLINED WITHIN THESE DRAWINGS, SPECIFICATIONS, AND CODE(S). THE FIRE SPRINKLER CONTRACTOR SHALL PROVIDE AS-BUILT DRAWINGS UPON COMPLETION OF WORK WHICH REFLECT ACTUAL INSTALLATION CONDITIONS.
- 2. FIRE SPRINKLER CONTRACTOR SHALL DEVELOP, PRODUCE, AND SUBMIT ENGINEERED FIRE SPRINKLER DESIGN CALCULATIONS AND DRAWINGS (SHOP DRAWINGS) TO THE AUTHORITY HAVING JURISDICTION (AHJ) FOR REVIEW AND APPROVAL. AFTER AHJ HAS REVIEWED AND APPROVED THE CALCULATIONS AND DRAWINGS, FIRE SPRINKLER CONTRACTOR SHALL SUBMIT THE DRAWINGS AND CALCULATIONS TO THE ENGINEER FOR REVIEW AND APPROVAL PRIOR TO ANY FIRE SPRINKLER INSTALLATION.
- REFER TO ARCHITECTURAL PLANS AND FIRE SPRINKLER PLANS FOR COMPLETE SECTIONS, ELEVATIONS, AND FLOOR PLAN DETAILS/NOTES. COORDINATE WITH FULL DRAWING PACKAGE FOR SCOPE OF WORK REQUIRED BY THIS CONTRACT.
- 4. UPON THE CONTRACTORS REQUEST, ELECTRONIC DRAWING FILES OF THE PROJECTS FLOOR PLANS /
 REFLECTIVE CEILING PLANS CAN BE PROVIDED FOR CONVENIENCE AND USE IN THE PREPARATION OF SHOP
 DRAWINGS RELATED TO THE PROJECT SUBJECT TO AGREED UPON TERMS AND CONDITIONS. CONTRACTOR
 SHALL BE REQUIRED TO SUBMIT AN ACCEPTANCE LETTER OF THE TERMS AND CONDITIONS PRIOR TO RELEASE
 OF THE ELECTRONIC DRAWINGS. COORDINATE WITH THE PROJECT ENGINEER FOR ADDITIONAL
 REQUIREMENTS.
- 5. THE PREPARATION OF ALL SHOP DRAWINGS AND HYDRAULIC CALCULATIONS SHALL BE ACCOMPLISHED BY A REGISTERED ENGINEER, LICENSED IN THE STATE OF MONTANA, IF REQUIRED BY LOCAL AUTHORITIES. AT A MINIMUM, WORK MUST BE DONE BY A NICET LEVEL 3 TECHNICIAN.

FIRE SPRINKLER PROJECT NOTES:

- 1. FIRE SPRINKLER SYSTEM SHALL COMPLY WITH THE INSURANCE SERVICES OFFICE REQUIREMENTS, NFPA 13, ALL OTHER APPLICABLE STATE AND LOCAL CODES. REFER TO ALL NEW ARCHITECTURAL, STRUCTURAL, ELECTRICAL, MECHANICAL, AND PLUMBING PLANS AND SPECIFICATIONS FOR COMPLETE SECTIONS, ROOM NAMES, DETAILS, AND BUILDING PLANS.
- 2. FIRE SPRINKLER SYSTEM SHALL BE DESIGNED TO PROVIDE A HYDRAULIC DENSITY AS REQUIRED BY CODE.
- 3. 1" THRU 2" PIPES SHALL BE SCHEDULE 40 WITH SCREWED FITTINGS. 2-1/2" THRU 4" PIPES SHALL BE SCHEDULE 10 WITH GROOVED FITTINGS.
- 4. FIRE SPRINKLER SYSTEM TEST SHALL BE WITNESSED BY THE AUTHORITY HAVING JURISDICTION PRIOR TO ANY PORTION BEING CONCEALED. GIVE 48 HOURS NOTICE PRIOR TO SYSTEM TEST.
- NO INSTALLATION OF ANY PIPING OR EQUIPMENT IS TO BEGIN PRIOR TO APPROVAL OF THE PLANS AND ISSUANCE OF A PERMIT BY THE AUTHORITY HAVING JURISDICTION.
- 6. COORDINATE ROUTING AND LOCATION OF FIRE SPRINKLER SYSTEM WITH ALL OTHER TRADES PRIOR TO SHOP DRAWING PREPARATION. DUCTWORK INSTALLATION SHALL HAVE ROUTING PRIORITY.
- PROTECT BUILDING OVERHANGS AND COMBUSTIBLE CONCEALED SPACES AS REQUIRED BY APPLICABLE CODES. REVIEW ALL ARCHITECTURAL SECTIONS AND PROVIDE PROTECTION AS REQUIRED AS PART OF THIS PROJECT. PROVIDE DRY PENDENT OR SIDEWALL HEADS IN AREAS SUBJECT TO FREEZING AS REQUIRED.
- FIRE SPRINKLER HEADS SHALL BE CENTERED IN THE LENGTH AND WIDTH OF 2'X2' AND 2'X4' OR OTHER SIZES OF CEILING TILES. THE USE OF NFPA APPROVED STAINLESS STEEL BRAIDED FLEXIBLE SPRINKLER HOSE ASSEMBLIES WITH CEILING MOUNTING BRACKET IS PERMISSIBLE.
- 9. DO NOT INSTALL FIRE PROTECTION MAIN OR BRANCH LINES THROUGH ELECTRICAL, IT, OR DATA ROOMS. USE SIDEWALL HEADS IN THESE ROOMS.
- FIRE SPRINKLER HEADS SHALL BE FULLY-CONCEALED WITH WHITE ESCUTCHEON IN ALL NEW LAY-IN AND HARD LID CEILING CONFIGURATIONS. FIRE SPRINKLER HEADS SHALL BE BRASS, UPRIGHT STYLE HEADS IN ALL AREAS OPEN TO STRUCTURE. REFER TO DETAILS #FX/#.# AND #FX/#.# ON THIS SHEET AND THE PROJECT SPECIFICATIONS FOR FURTHER REQUIREMENTS.
- 11. ROUTE FIRE SPRINKLER PIPING AS HIGH AS FEASIBLE IN ALL EXPOSED AREAS. COORDINATE ALL EXPOSED PIPING IN FINISHED AREAS WITH THE ARCHITECT AS REQUIRED. PIPING SHALL BE LEFT CLEAN FOR PAINTING BY
- UPON THE CONTRACTORS REQUEST, ELECTRONIC DRAWING FILES OF THE PROJECTS FLOOR PLANS /
 REFLECTIVE CEILING PLANS CAN BE PROVIDED FOR CONVENIENCE AND USE IN THE PREPARATION OF SHOP
 DRAWINGS RELATED TO THE PROJECT SUBJECT TO AGREED UPON TERMS AND CONDITIONS. CONTRACTOR
 SHALL BE REQUIRED TO SUBMIT AN ACCEPTANCE LETTER OF THE TERMS AND CONDITIONS PRIOR TO RELEASE
 OF THE ELECTRONIC DRAWINGS. COORDINATE WITH THE PROJECT ENGINEER FOR ADDITIONAL
 REQUIREMENTS.

FIRE SPRINKLER HAZARD CLASSIFICATIONS:

LIGHT: OFFICES, COMMON SPACES, RESTROOMS, CONFERENCE ROOMS, ETC.

ORDINARY GROUP I: MECHANICAL ROOMS, STORAGE ROOMS, JANITOR'S CLOSETS

PLUMBING SYMBOLS LEGEND GENERAL PIPING DIRECTION OF FLOW TEE IN HORIZ. RUN **→**or**→** ---- or----**REDUCER FITTING** BRANCH TEE W/ OFFSET —η—— or——η— **ELBOW TURNED UP** ——— or———— BRANCH TEE TURNED UP ELBOW TURNED DN. BRANCH TEE TURNED DN. DROP IN HORIZ. RUN CROSS IN HORIZ. RUN TEE TURNED UP 90° AND 45° ELBOWS TEE TURNED DN. END CAP CONNECTION BELL AND SPIGOT UNION FITTING PIPING PHASE **EXISTING PIPING** TEMPORARY PIPING NEW UNDERFLOOR PIPING DEMOLISHED PIPING **NEW ABOVE FLOOR PIPING** — — — — — — DOMESTIC COLD WATER SANITARY WASTE STORM DRAINAGE - PRIMARY STORM DRAINAGE - OVERFLOW **ACID WASTE GREASE WASTE ACID VENT** TEMPERED WATER — — — — CW-F — — — FILTERED COLD WATER MISCELLANEOUS/MECHANICAL PIPING TYPES — - — - CWS- — - — CHILLED WATER SUPPLY — - — - CWR- — - — CHILLED WATER RETURN LOW PRESSURE STEAM MEDIUM PRESSURE STEAM — - — - — -HWS- — - — - HOT WATER SUPPLY HIGH PRESSURE STEAM MEDICAL AIR CONDENSATE DRAIN NITROGEN LOW PRESSURE CONDENSATI NITROUS OXIDE NITROUS DIOXIDE MEDIUM PRESSURE CONDENSATE HIGH PRESSURE CONDENSATE OXYGEN REFRIGERANT LIQUID FUEL OIL RETURN REFRIGERANT SUCTION FUEL OIL SUPPLY **HOT GAS BYPASS** VACUUM WASTE ANESTHETIC GAS NATURAL GAS DISPOSAL **CARBON DIOXIDE** —F-WET——— FIRE PROTECTION WET F-DRY FIRE PROTECTION DRY PIPING FITTINGS, VALVES & SPECIALTIES EXIST. FIXTURE TO REMAIN EXIST. FIXT. TO BE REMOVED **NEW PLUMBING FIXTURE** P-1 or P1 FIXT. NUMBER - SEE SCHED. ANGLE VALVE <u> — Б</u>— or — Ь— BALL VALVE **BUTTERFLY VALVE** ——⋈—or ——↓— GATE VALVE PRESS. REDUCING ——> or — \ \ **GLOBE VALVE** 2-WAY (ELECTRIC) _____**>** PLUG VALVE 2-WAY (PNEU. MTR.) ______or _____ CHECK VALVE 2-WAY (SOLENOID) **SOLENOID GATE VALVE** PNEUMATIC MOTOR **BALANCING VALVE** 3-WAY (ELECTRIC) FLOAT VALVE 3-WAY (PNEUMATIC) DRAIN 3-WAY (PNEU. MTR.) ——— or ——— WALL HYDRANT OR HOSE BIBB STRAINER FLEX. CONNECTION — w— or — ∞ — STRAINER W/ BLOW-OFF SENSOR (TEMP./FLOW) **VENT THRU ROOF** TEMP. GAUGE PRESSURE GAUGE P.O.D.C. - POINT OF DISCONNECTION FIRE EXTINGUISHER P.O.C. - POINT OF FIRE SPRINKLER HEAD CONNECTION THIS IS A STANDARDIZED SYMBOLS LEGEND, ALL SYMBOLS SHOWN MAY

	PLUMBING SHEET LIST											
P1.0	PLUMBING COVER SHEET											
P1.1	PLUMBING SCHEDULES											
P2.0	BASEMENT PLUMBING DEMO PLAN											
P2.1	FIRST FLOOR PLUMBING DEMOLITION PLAN											
P2.2	ROOF PLUMBING DEMO PLAN											
P3.0	BASEMENT PLUMBING REMODEL PLAN											
P3.1	FIRST FLOOR PLUMBING REMODEL PLAN											
P3.2	ROOF PLUMBING REMODEL PLAN											
P4.0	PLUMBING DETAILS											

NOT APPEAR ON OR WITHIN THIS SET OF CONTRACT DOCUMENTS.



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plan one / architects

DRAWN BY: Author
REVIEWED BYChecker
REV. DESCRIPTION DATE

WEEDA 12615 PEQ-06/16/2023

PPA#22-0056 A/E#00-00-00 Consultant #:

SHEET TITLE
PLUMBING COVER
SHEET

SHEET

				PLUMBING	G FIXTURE SCHEDULE					
PLAN CODE	ITEM	MFGR.	MODEL NUMBER	MATERIAL & FINISH	TRIM		ROU	GH-IN SIZE		REMARKS
PLAN CODE	I I EIYI	MFGK.	MODEL NUMBER	MATERIAL & FINISH	IRIM		HW	SAN	VENT	REMARKS
FCO	FLOOR CLEAN OUT	JAY R SMITH	#4103S	CAST IRON BODY BRONZE PLUG				SEE PLANS		HEAVY DUTY CLEANOUT WITH TAPER THREAD BRONZE PLUG AND NICKEL BRONZE TOP.
FD-1	FLOOR DRAIN	JAY R SMITH	#2005Y-A	CAST IRON BODY NICKLE BRONZE STRAINER	TRAP GUARD			SEE PLANS	SEE PLANS	GENERAL PURPOSE FLOOR DRAIN WITH 5" DIAMETER NICKEL BRONZE STRAINER AND TRAP PRIMER CONNECTION.
FS-1	FLOOR SINK	JAY R SMITH	#3430Y-12	CAST IRON BODY W/ ARC INTERIOR CAST IRON GRATE W/ ARC	1/2" GRATE AND TRAP GUARD			SEE PLANS	SEE PLANS	FLOOR SINK WITH A.R.C. CAST IRON BODY AND GRATE. PROVIDE WITH TRAP PRIMER CONNECTION.
TD-1	TRENCH DRAIN	JAY R SMITH	9675-1236	STAINLESS STEEL				SEE PLANS	SEE PLANS	STAINLESS STEEL TRENCH DRAIN BODY WITH NO HUB OUTLET, SEDIMENT BUCKET, AND STAINLESS STEEL GRATE. PROVIDE WITH TRAP PRIMER CONNECTION.
wco	WALL CLEAN OUT	JAY R SMITH	#4472T	BRONZE PLUG				SEE PLANS		WALL CLEAN-OUT WITH BRASS TAPERED THREAD PLUG AND COVER PLATE. PROVIDE WITH STAINLESS STEEL COVER PLATE IN TILE FINISH APPLICATIONS. PROVIDE WITH PRIME COATED STEAL COVER PLATE IN PAINTED WALL FINISH APPLICATIONS AND FIELD PAINT TO MATCH WALL COVERING.

FIXTURE ROUGH-IN SIZES LISTED ABOVE FOR CW, HW, SAN, AND VENT ARE THE BRANCH RUN-OUT LINE SIZES TO THE FIXTURE. THE POINT-OF-CONNECTION AT THE FIXTURE MAY BE SMALLER OR LARGER PENDING ON THE SPECIFIC FIXTURE'S CONNECTION SIZES. CONTRACTOR TO MAKE THE APPROPRIATE CONNECTION SIZE TRANSITION AT THE FIXTURE. VERIFY FLOOR FINISH AND FINISH THICKNESS BEFORE SETTING ANY FIXTURES.

PROVIDE FLUSH MOUNTED LOCKABLE ACCESS PANELS AS NEEDED FOR PLUMBING ACCESSORY ACCESS. COORDINATE LOCATION WITH ARCHITECT AND G.C. PRIOR TO ACCESSORY AND DOOR INSTALLATION. REFER TO ARCHITECTURAL SPECIFICATIONS FOR ACCESS DOOR REQUIREMENTS.

				Kľ	TCHEN EQUIP	MENT PLUMB	ING CON	NECTION	SCHEDULE					
VITCUEN FOLUDADAT CODE	WATER SANITARY WASTE GREASE WASTE EN EQUIPMENT CODE ITEM - FIXTURES PROVIDED BY OTHERS WATER SANITARY WASTE PLUMBING CONTRACTOR FURNISHED & INSTALLED ITEMS (UNLESS OTHERWISE NOTED)													
KITCHEN EQUIPMENT CODE	TIEM - FIXTURES PROVIDED BY OTHERS	COLD	COLD	HOT 140°	DIRECT	INDIRECT	DIRECT	INDIRECT	Plumbing Contractor Furnished & Installed Hems (unless Otherwise Noted)	REMARKS				
E-305	TEA BREWER		1/2"						DC WITH VENT	SEE NOTES				
E-318a	8 STOP WATER MANIFOLD PANEL		3/4"						DC WITH VENT	SEE NOTES				
E-350	WATER FILTERATION SYSTEM	3/4"								SEE NOTES				
E-380A	AIR COOLED ICE MACHINE		1/2"			3/4"			DC WITH VENT	ROUTE INDIRECT DRAIN TO NEAREST FLOOR RECEPTOR AND AIR GA				
F-308	FUTURE SINGLE COFFEE MAKER		1/2"						DC WITH VENT	SEE NOTES				
F-380AB	FUTURE ICE MACHINE WITH RIDE SYSTEM		1/2"			3/4"			DC WITH VENT	ROUTE INDIRECT DRAIN TO NEAREST FLOOR RECEPTOR AND AIR GAI				
S-111	UNDERMOUNT HAND SINK	1/2"		1/2"	2"				ASSE 1070 THERMOSTATIC MIX VALVE	SEE NOTES				
S-360	HAND SINK	1/2"		1/2"	2"				ASSE 1070 THERMOSTATIC MIX VALVE	SEE NOTES				
S-360e	HAND SINK	1/2"		1/2"	2"				ASSE 1070 THERMOSTATIC MIX VALVE	SEE NOTES				
S-364	THREE COMPARTMENT UTENSIL SINK	3/4"		3/4"				4"	INLET CHECK VALVES	ROUTE INDIRECT DRAINS INDEPENDENTLY TO NEAREST FLOOR RECEPT AND AIR GAP.				
S-366	SINGLE BOWL VEGETABLE PREP SINK	1/2"	1/2"	1/2"				4"	INLET CHECK VALVES	ROUTE INDIRECT DRAIN TO NEAREST FLOOR RECEPTOR AND AIR GA				
MS-370B	MOP SINK	1/2"		1/2"	2"				INLET CHECK VALVES	SEE NOTES				

SEE FOOD SERVICE DRAWINGS FOR KITCHEN EQUIPMENT LOCATIONS AND ADDITIONAL REQUIRMENTS.

CONNECTION SIZE NOTED FOR REFERENCE ONLY. COORDINATE WITH FOOD SERVICE DRAWINGS AND EQUIPMENT INSTALLATION GUIDLINES FOR FURTHER REQUIREMENTS.




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REPORT OF A SECTION DOCUMENTS

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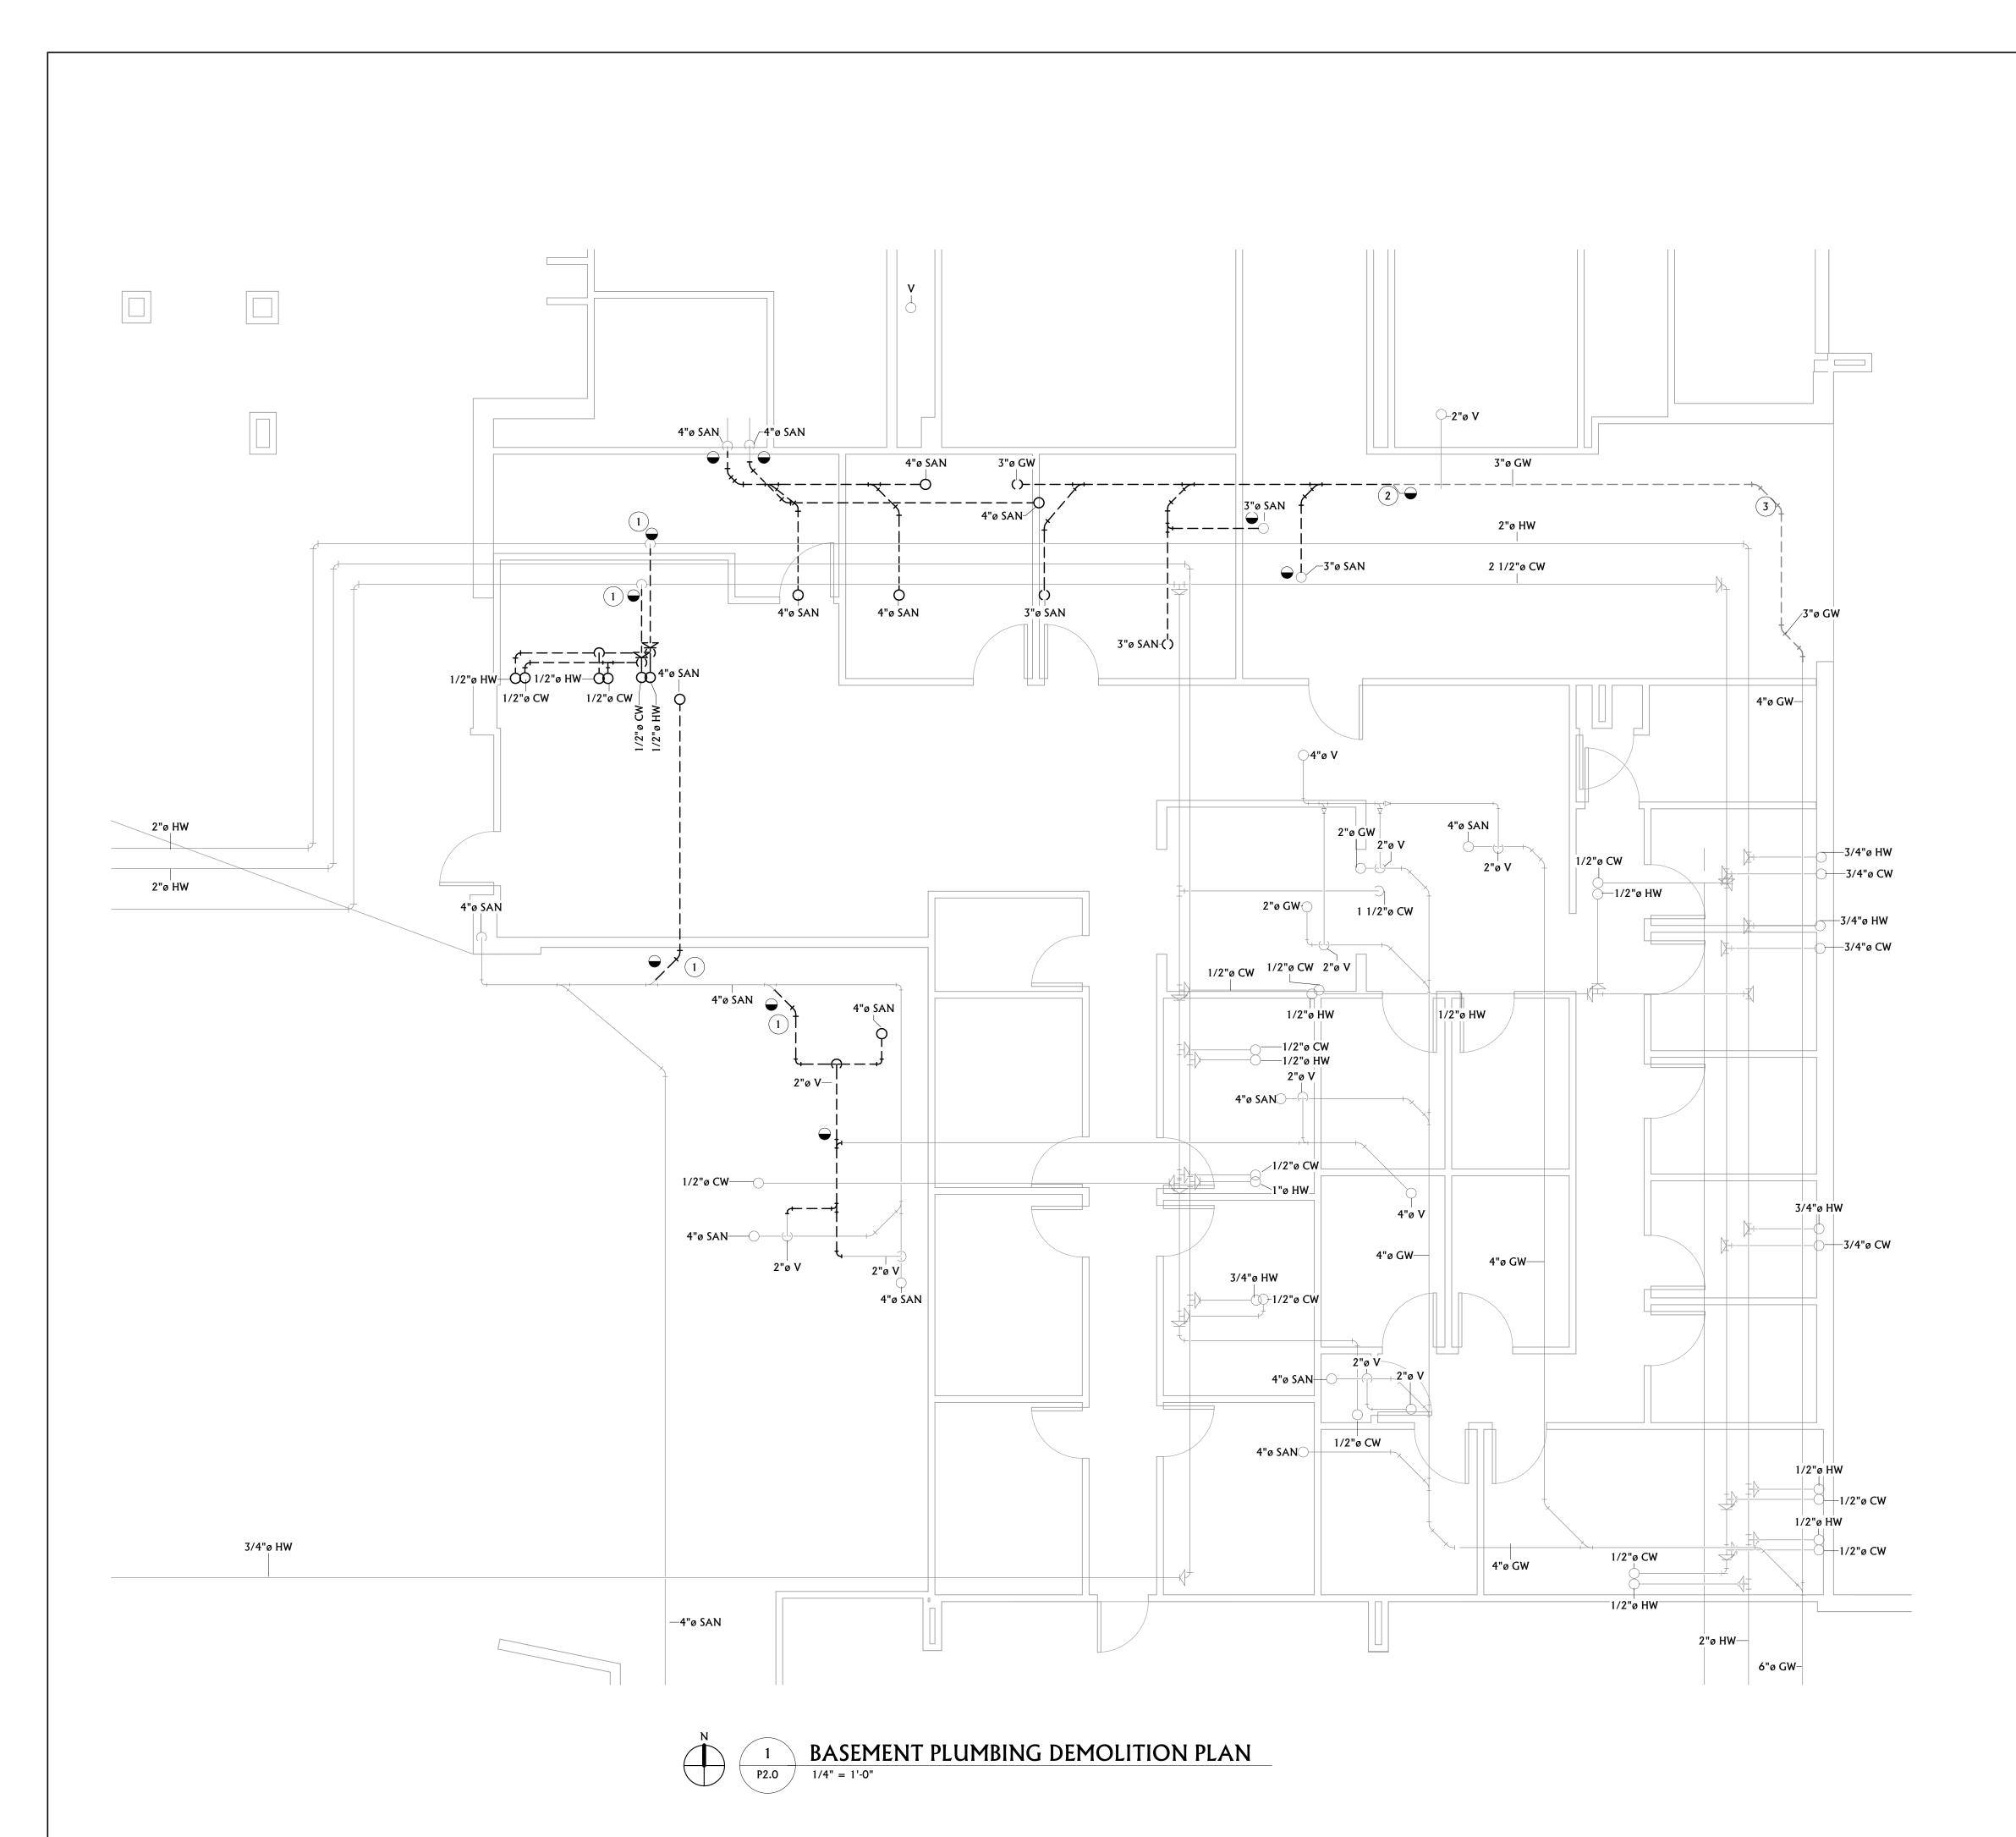
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PPA#22-0056 A/E#00-00-00 Consultant #:

SHEET TITLE **PLUMBING SCHEDULES**

SHEET

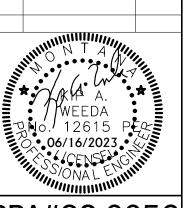

PLUMBING GENERAL DEMOLITION NOTES

- A CONTRACTOR SHALL CUT ALL FLOORS, WALLS, CEILINGS, AND ROOF AS REQUIRED TO PERFORM THE WORK DEPICTED IN THESE CONTRACT DOCUMENTS AND SPECIFICATIONS. GENERAL CONTRACTOR SHALL PATCH ALL ASSOCIATED FLOORS, WALLS, CEILINGS, AND ROOF AS REQUIRED TO THE SATISFACTION OF THE ARCHITECT/ENGINEER.
- B COORDINATE HVAC AND PLUMBING EQUIPMENT WITH ALL OTHER TRADES AS
- C THE INFORMATION SHOWN ON THIS DRAWING WAS OBTAINED FROM EXISTING DRAWINGS AND VISUAL FIELD OBSERVATIONS WHICH SHALL BE INCLUDED IN THE SCOPE OF WORK. FIELD VERIFY ALL EXISTING CONDITIONS AND PROVIDE DEMOLITION AS REQUIRED TO ACCOMMODATE CONSTRUCTION.
- D NOTIFY THE OWNER OF ANY SYSTEM SHUT-DOWNS AND APPROXIMATE SHUT-DOWN TIME PRIOR TO COMMENCING WITH WORK.
- E CONTRACTOR SHALL REMOVE ALL DEMO'D MATERIALS FROM BUILDING, UNLESS SPECIFICALLY NOTED TO BE ABANDONED IN PLACE OR RE-USED.
- F DRAWINGS SHOW GENERAL LOCATIONS OF MATERIALS TO BE REMOVED. IT SHALL BE THE CONTRACTORS RESPONSIBILITY TO DETERMINE THE EXTENT OF WORK REQUIRED FOR A COMPLETE SYSTEM REMOVAL.
- G OWNER HAS FIRST RIGHT OF REFUSAL FOR ALL EQUIPMENT/MATERIAL CALLED OUT TO BE REMOVED. CONTRACTOR SHALL PRESENT ALL DEMO'D EQUIPMENT/MATERIAL TO OWNER PRIOR TO REMOVING FROM SITE.
- H SEAL ALL ABANDONED PLUMBING PENETRATIONS THROUGH FIRE RATED ASSEMBLIES WITH UL-APPROVED FIRE RATED SYSTEM.
- CONTRACTOR SHALL REMOVE ALL HANGERS AND SUPPORTS SERVING EQUIPMENT AND PIPING DEMO'D IN THIS PROJECT. HANGERS WHICH ARE PERMANENTLY ATTACHED TO THE EXISTING STRUCTURE SHALL BE CUT BACK TO A MINIMUM OF NO LESS THAN 1" FROM THEIR EXISTING CONNECTION POINT TO THE EXISTING STRUCTURE. DEMO ALL ACCESSIBLE SEWER AND WATER LINES BACK TO AN ACTIVE MAIN. DEAD END LINES ARE NOT ACCEPTABLE.

PLUMBING KEYNOTES

DISCONNECT EXISTING PIPING AT APPROXIMATE LOCATION AND CAP.

DISCONNECT PIPING AT APPROXIMATE LOCATION AND REMOVE AS INDICATED.
DOWNSTREAM PIPING TO BE REMOVED AND REPLACED UNDER SEPARATE PROJECT BY OWNER. COORDINATE WITH OWNER AS REQUIRED.

PIPING TO BE REPLACED UNDER SEPARATE PROJECT BY OWNER. COORDINATE EXTENT AND MATERIAL AND COORDINATE CONNECTION AS REQUIRED.


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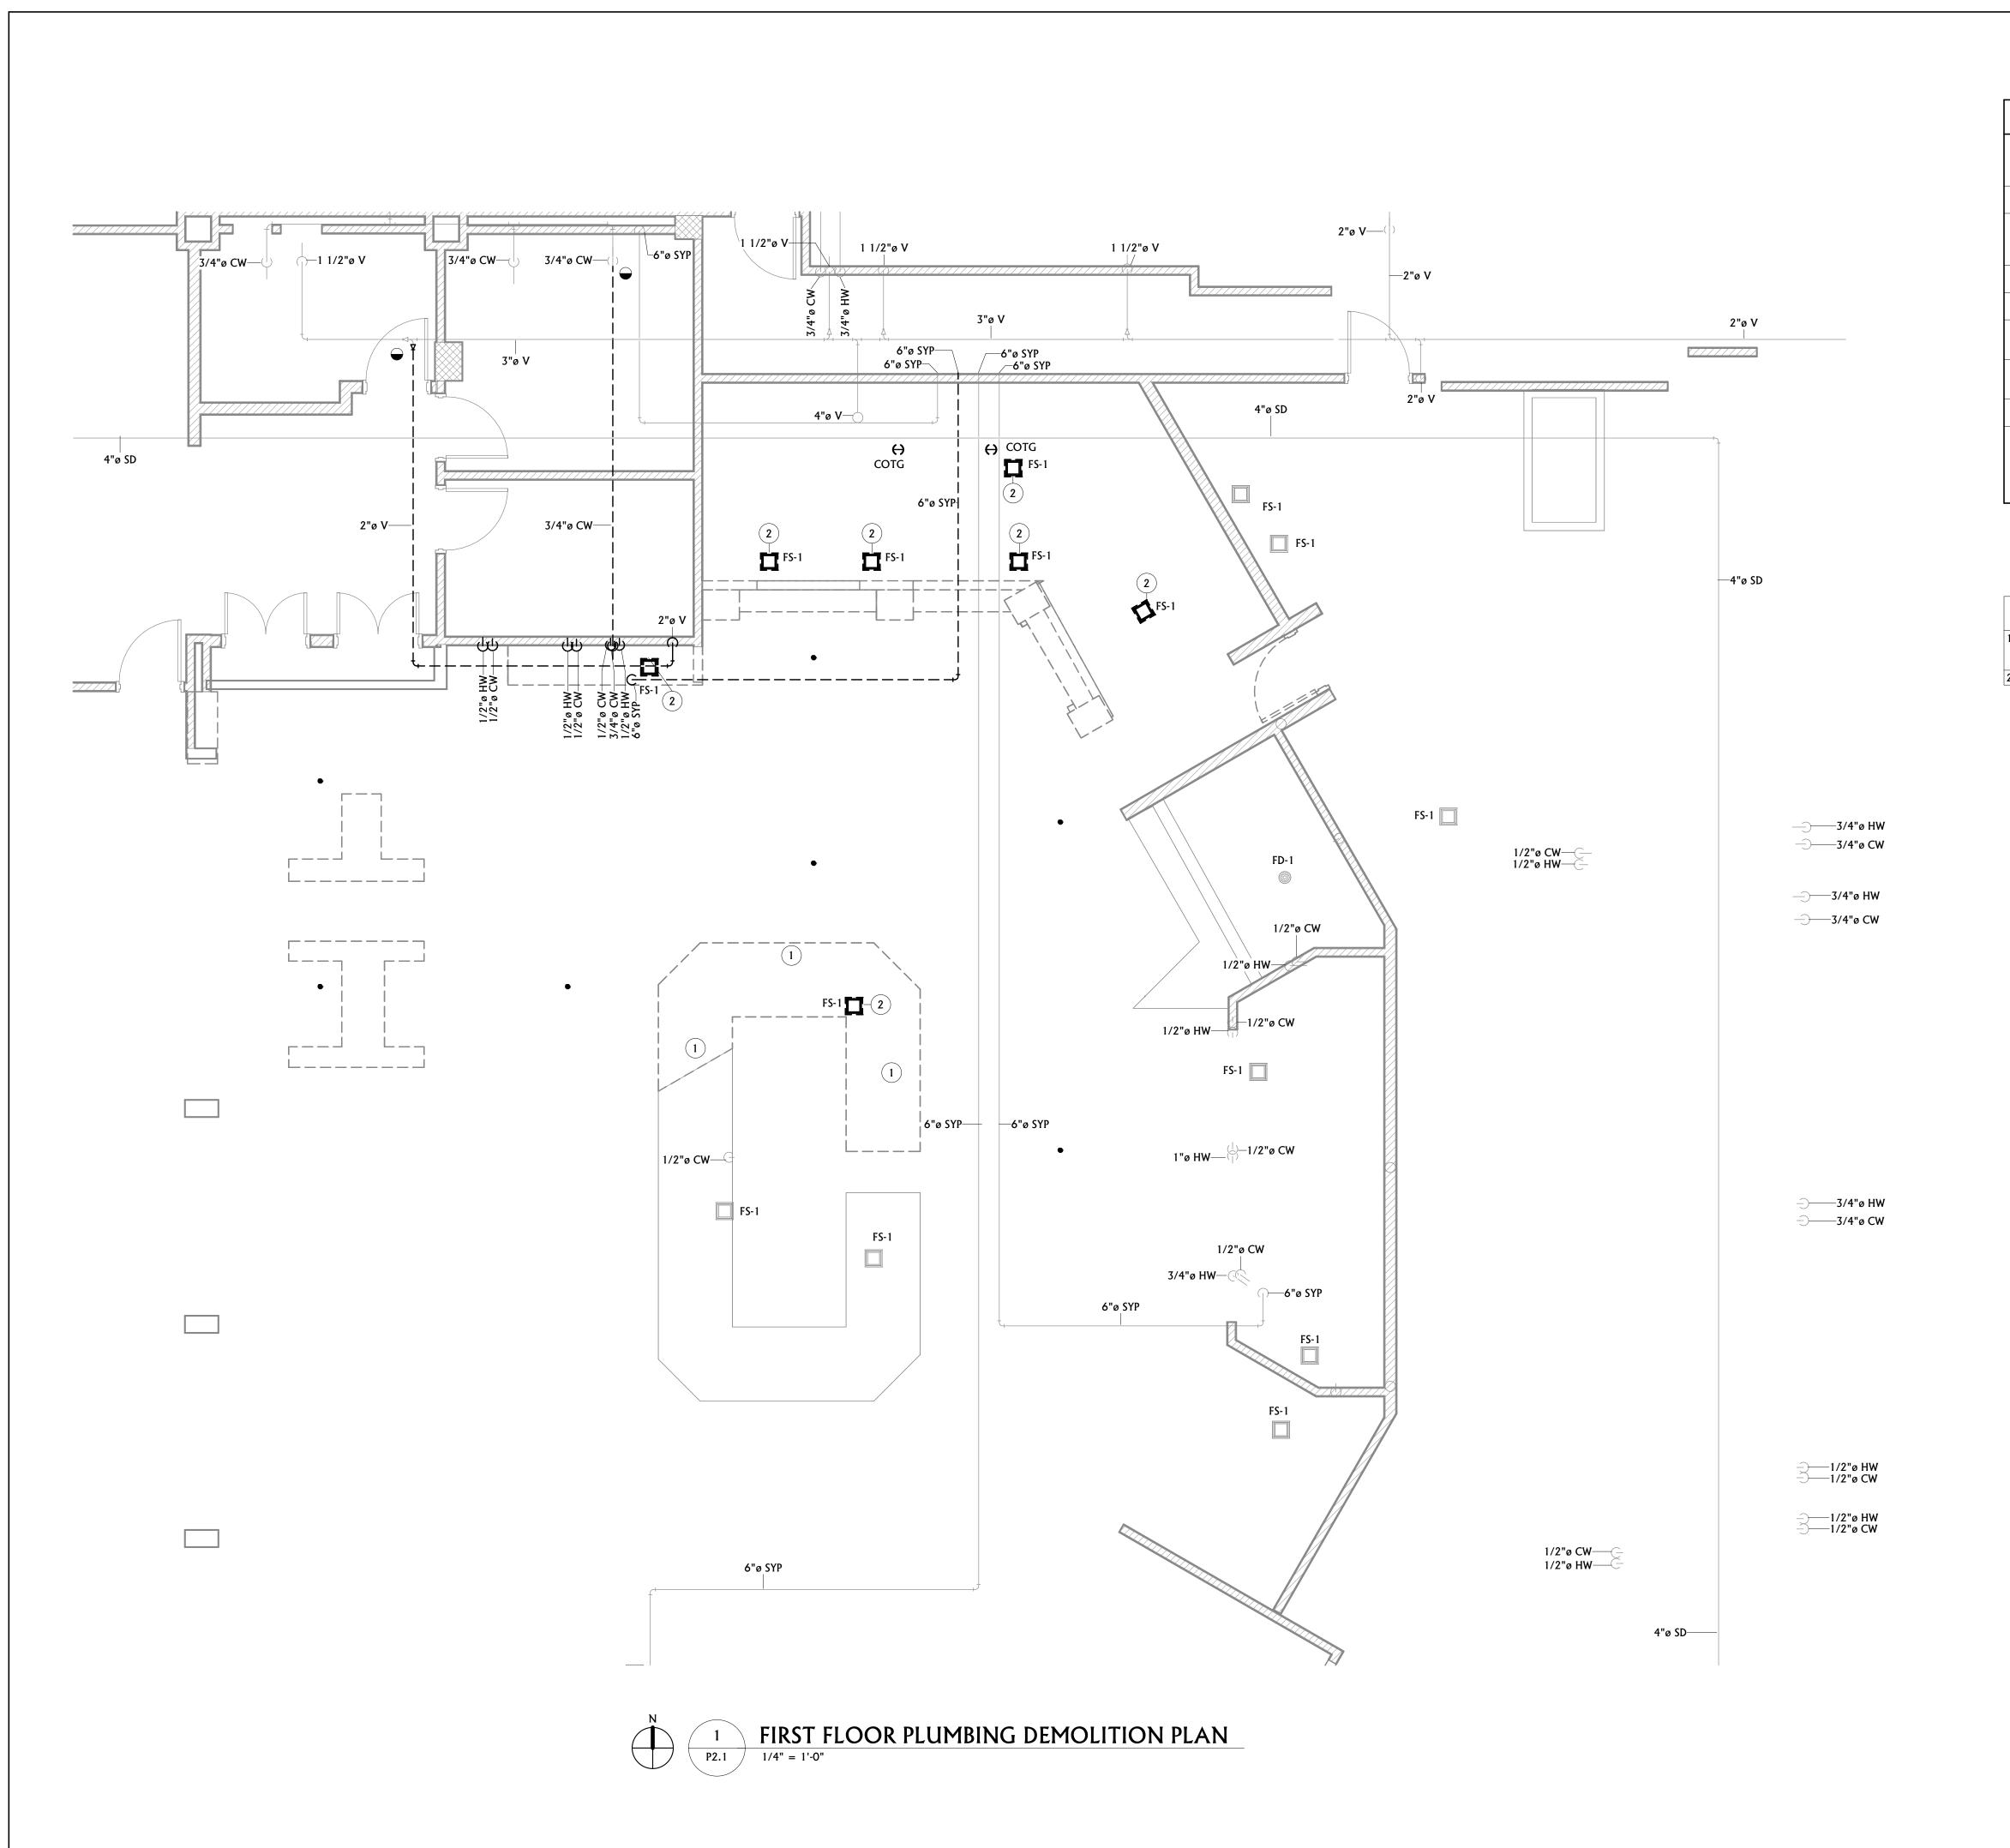
PPA#22-0056 A/E#00-00-00 Consultant #:

SHEET TITLE **BASEMENT PLUMBING DEMO**

PLAN

SHEET

P2.0

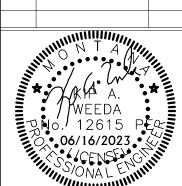

PLUMBING GENERAL DEMOLITION NOTES

- A CONTRACTOR SHALL CUT ALL FLOORS, WALLS, CEILINGS, AND ROOF AS REQUIRED TO PERFORM THE WORK DEPICTED IN THESE CONTRACT DOCUMENTS AND SPECIFICATIONS. GENERAL CONTRACTOR SHALL PATCH ALL ASSOCIATED FLOORS, WALLS, CEILINGS, AND ROOF AS REQUIRED TO THE SATISFACTION OF THE ARCHITECT/ENGINEER.
- B COORDINATE HVAC AND PLUMBING EQUIPMENT WITH ALL OTHER TRADES AS
- C THE INFORMATION SHOWN ON THIS DRAWING WAS OBTAINED FROM EXISTING DRAWINGS AND VISUAL FIELD OBSERVATIONS WHICH SHALL BE INCLUDED IN THE SCOPE OF WORK. FIELD VERIFY ALL EXISTING CONDITIONS AND PROVIDE DEMOLITION AS REQUIRED TO ACCOMMODATE CONSTRUCTION.
- D NOTIFY THE OWNER OF ANY SYSTEM SHUT-DOWNS AND APPROXIMATE SHUT-DOWN TIME PRIOR TO COMMENCING WITH WORK.
- E CONTRACTOR SHALL REMOVE ALL DEMO'D MATERIALS FROM BUILDING, UNLESS SPECIFICALLY NOTED TO BE ABANDONED IN PLACE OR RE-USED.
- F DRAWINGS SHOW GENERAL LOCATIONS OF MATERIALS TO BE REMOVED. IT SHALL BE THE CONTRACTORS RESPONSIBILITY TO DETERMINE THE EXTENT OF WORK REQUIRED FOR A COMPLETE SYSTEM REMOVAL.
- G OWNER HAS FIRST RIGHT OF REFUSAL FOR ALL EQUIPMENT/MATERIAL CALLED OUT TO BE REMOVED. CONTRACTOR SHALL PRESENT ALL DEMO'D EQUIPMENT/MATERIAL TO OWNER PRIOR TO REMOVING FROM SITE.
- H SEAL ALL ABANDONED PLUMBING PENETRATIONS THROUGH FIRE RATED ASSEMBLIES WITH UL-APPROVED FIRE RATED SYSTEM.
- CONTRACTOR SHALL REMOVE ALL HANGERS AND SUPPORTS SERVING EQUIPMENT AND PIPING DEMO'D IN THIS PROJECT. HANGERS WHICH ARE PERMANENTLY ATTACHED TO THE EXISTING STRUCTURE SHALL BE CUT BACK TO A MINIMUM OF NO LESS THAN 1" FROM THEIR EXISTING CONNECTION POINT TO THE EXISTING STRUCTURE. DEMO ALL ACCESSIBLE SEWER AND WATER LINES BACK TO AN ACTIVE MAIN. DEAD END LINES ARE

NOT ACCEPTABLE.

PLUMBING KEYNOTES

FOOD WELL AT APPROXIMATE LOCATION. REMOVE ALL ASSOCIATED DOMESTIC WATER AND WASTE PIPING AND ASSOCIATED ACCESSORIES. FIELD COORDINATE UTILITIES SERVING EQUIPMENT AS REQUIRED.


DEMO FLOOR SINK AT APPROXIMATE LOCATION. PATCH FLOOR AS REQUIRED.

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PPA#22-0056 A/E#00-00-00 Consultant #:

SHEET TITLE **FIRST FLOOR PLUMBING DEMOLITION PLAN**

SHEET

P2.1

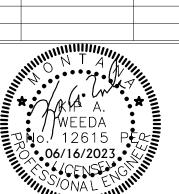

PLUMBING GENERAL DEMOLITION NOTES

- A CONTRACTOR SHALL CUT ALL FLOORS, WALLS, CEILINGS, AND ROOF AS REQUIRED TO PERFORM THE WORK DEPICTED IN THESE CONTRACT DOCUMENTS AND SPECIFICATIONS. GENERAL CONTRACTOR SHALL PATCH ALL ASSOCIATED FLOORS, WALLS, CEILINGS, AND ROOF AS REQUIRED TO THE SATISFACTION OF THE ARCHITECT/ENGINEER.
- B COORDINATE HVAC AND PLUMBING EQUIPMENT WITH ALL OTHER TRADES AS REQUIRED.
- C THE INFORMATION SHOWN ON THIS DRAWING WAS OBTAINED FROM EXISTING DRAWINGS AND VISUAL FIELD OBSERVATIONS WHICH SHALL BE INCLUDED IN THE SCOPE OF WORK. FIELD VERIFY ALL EXISTING CONDITIONS AND PROVIDE DEMOLITION AS REQUIRED TO ACCOMMODATE CONSTRUCTION.
- D NOTIFY THE OWNER OF ANY SYSTEM SHUT-DOWNS AND APPROXIMATE SHUT-DOWN TIME PRIOR TO COMMENCING WITH WORK.
- E CONTRACTOR SHALL REMOVE ALL DEMO'D MATERIALS FROM BUILDING, UNLESS SPECIFICALLY NOTED TO BE ABANDONED IN PLACE OR RE-USED.
- F DRAWINGS SHOW GENERAL LOCATIONS OF MATERIALS TO BE REMOVED. IT SHALL BE THE CONTRACTORS RESPONSIBILITY TO DETERMINE THE EXTENT OF WORK REQUIRED FOR A COMPLETE SYSTEM REMOVAL.
- G OWNER HAS FIRST RIGHT OF REFUSAL FOR ALL EQUIPMENT/MATERIAL CALLED OUT TO BE REMOVED. CONTRACTOR SHALL PRESENT ALL DEMO'D EQUIPMENT/MATERIAL TO OWNER PRIOR TO REMOVING FROM SITE.
- H SEAL ALL ABANDONED PLUMBING PENETRATIONS THROUGH FIRE RATED ASSEMBLIES WITH UL-APPROVED FIRE RATED SYSTEM.
- I CONTRACTOR SHALL REMOVE ALL HANGERS AND SUPPORTS SERVING EQUIPMENT AND PIPING DEMO'D IN THIS PROJECT. HANGERS WHICH ARE PERMANENTLY ATTACHED TO THE EXISTING STRUCTURE SHALL BE CUT BACK TO A MINIMUM OF NO LESS THAN 1" FROM THEIR EXISTING CONNECTION POINT TO THE EXISTING STRUCTURE. DEMO ALL ACCESSIBLE SEWER AND WATER LINES BACK TO AN ACTIVE MAIN. DEAD END LINES ARE NOT ACCEPTABLE.

PLUMBING KEYNOTES

ROOFTOP EQUIPMENT LOCATED AT APPROXIMATE LOCATION. PROVIDED FOR REFERENCE.



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plan one / architects

ACE INC


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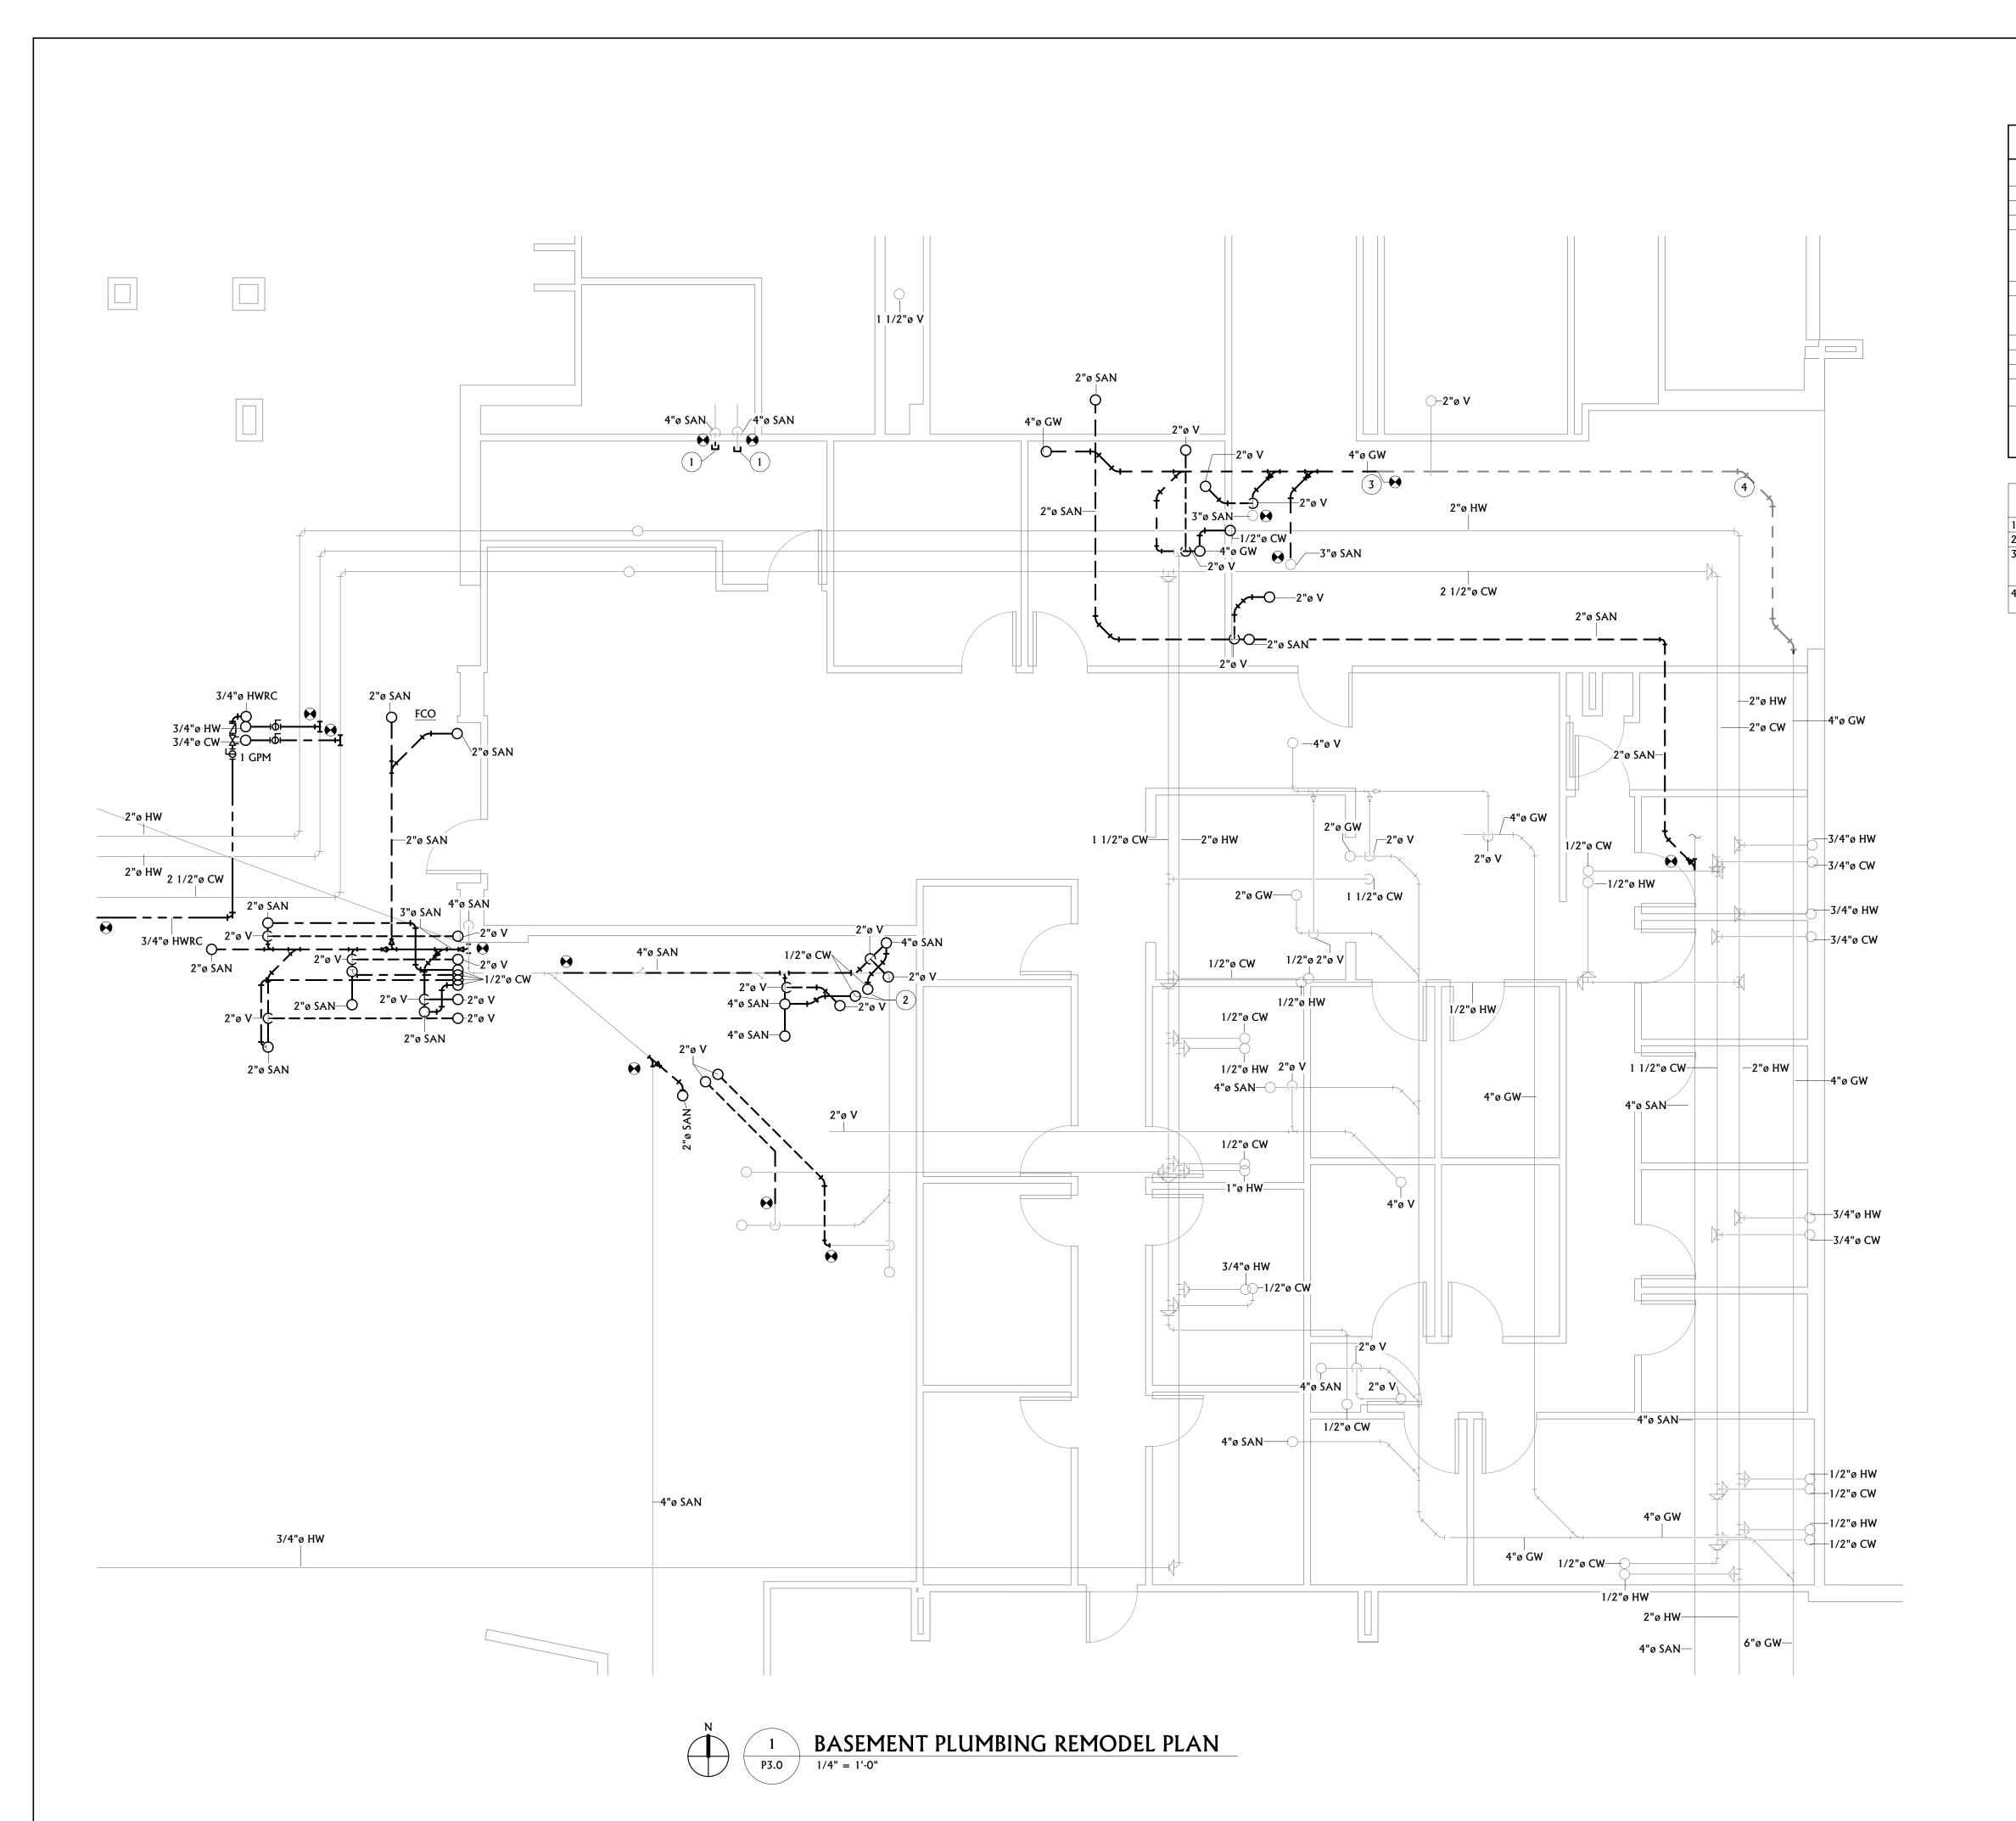


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Consultant #:

SHEET TITLE ROOF PLUMBING DEMO PLAN

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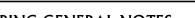
P2.2

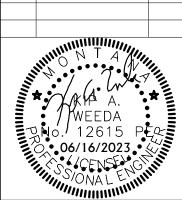

PLUMBING GENERAL NOTES

- A COORDINATE HVAC AND PLUMBING EQUIPMENT WITH ALL OTHER TRADES AS
- INSULATION ON ALL DOMESTIC COLD WATER PIPING SHALL BE PROVIDED WITH A
- CONTINUOUS VAPOR BARRIER. OVERSIZE HANGERS FOR INSULATION SO NO PENETRATION OF THE VAPOR BARRIER OCCURS. PROVIDE INSERTS AND SADDLES AS
- NO DOMESTIC WATER PIPING SHALL BE ROUTED IN ANY EXTERIOR WALLS.
- ACCESS PANEL FOR TRAP PRIMER ACCESS AS REQUIRED. ACCESS PANELS SHALL BE
- H ALL UNDERFLOOR VENT SHALL BE MINIMUM 2".

- K PROVIDE WALL CLEANOUTS ON ALL VENT RISERS SERVING FLOOR RECEPTOR WASTE
- SHALL CUT ALL FLOORS, WALLS, CEILINGS, AND ROOF AS REQUIRED TO PERFORM THE WORK DEPICTED IN THESE CONTRACT DOCUMENTS AND SPECIFICATIONS. GENERAL CONTRACTOR SHALL PATCH ALL ASSOCIATED FLOORS, WALLS, CEILINGS, AND ROOF AS REQUIRED TO THE SATISFACTION OF THE ARCHITECT/ENGINEER.
- MATERIAL AND COORDINATE CONNECTION AS REQUIRED. AND MATERIAL AND COORDINATE CONNECTION AS REQUIRED.



B REFERENCE ARCHITECTURAL PLANS FOR EXACT FIXTURE LOCATIONS.

C ALL VALVES LESS THAN 2" SHALL BE BALL VALVES UNLESS OTHERWISE NOTED. D COORDINATE UNDERSLAB PIPING WITH FOOTINGS AND STEM WALLS.

REQUIRED TO PREVENT INSULATION DAMAGE FROM SUPP

G PROVIDE ALL FLOOR DRAINS AND FLOOR SINKS WITH TRAP PRIMERS. PROVIDE WALL

RATED WHERE REQUIRED.

ALL UNDERFLOOR COPPER SHALL BE TYPE "K" SEAMLESS.

PROVIDE CLEANOUTS ON ALL LINES SERVING SINKS AND URINALS.

PLUMBING KEYNOTES

CAP EXISTING SANITARY WASTE PIPE AT APPROXIMATE LOCATION.

DOMESTIC WATER CONNECTIONS FOR TRAP PRIMERS AT APPROXIMATE LOCATION. CONNECT NEW WASTE PIPING AT APPROXIMATE LOCATION. DOWNSTREAM PIPING TO BE REPLACED UNDER SEPARATE PROJECT BY OWNER. COORDINATE EXTENT AND

PIPING TO BE REPLACED UNDER SEPARATE PROJECT BY OWNER. COORDINATE EXTENT

H CONSTRUCTION DOCUMENTS

MSU-CPDC

MONTANA STATE UNIVERSIT

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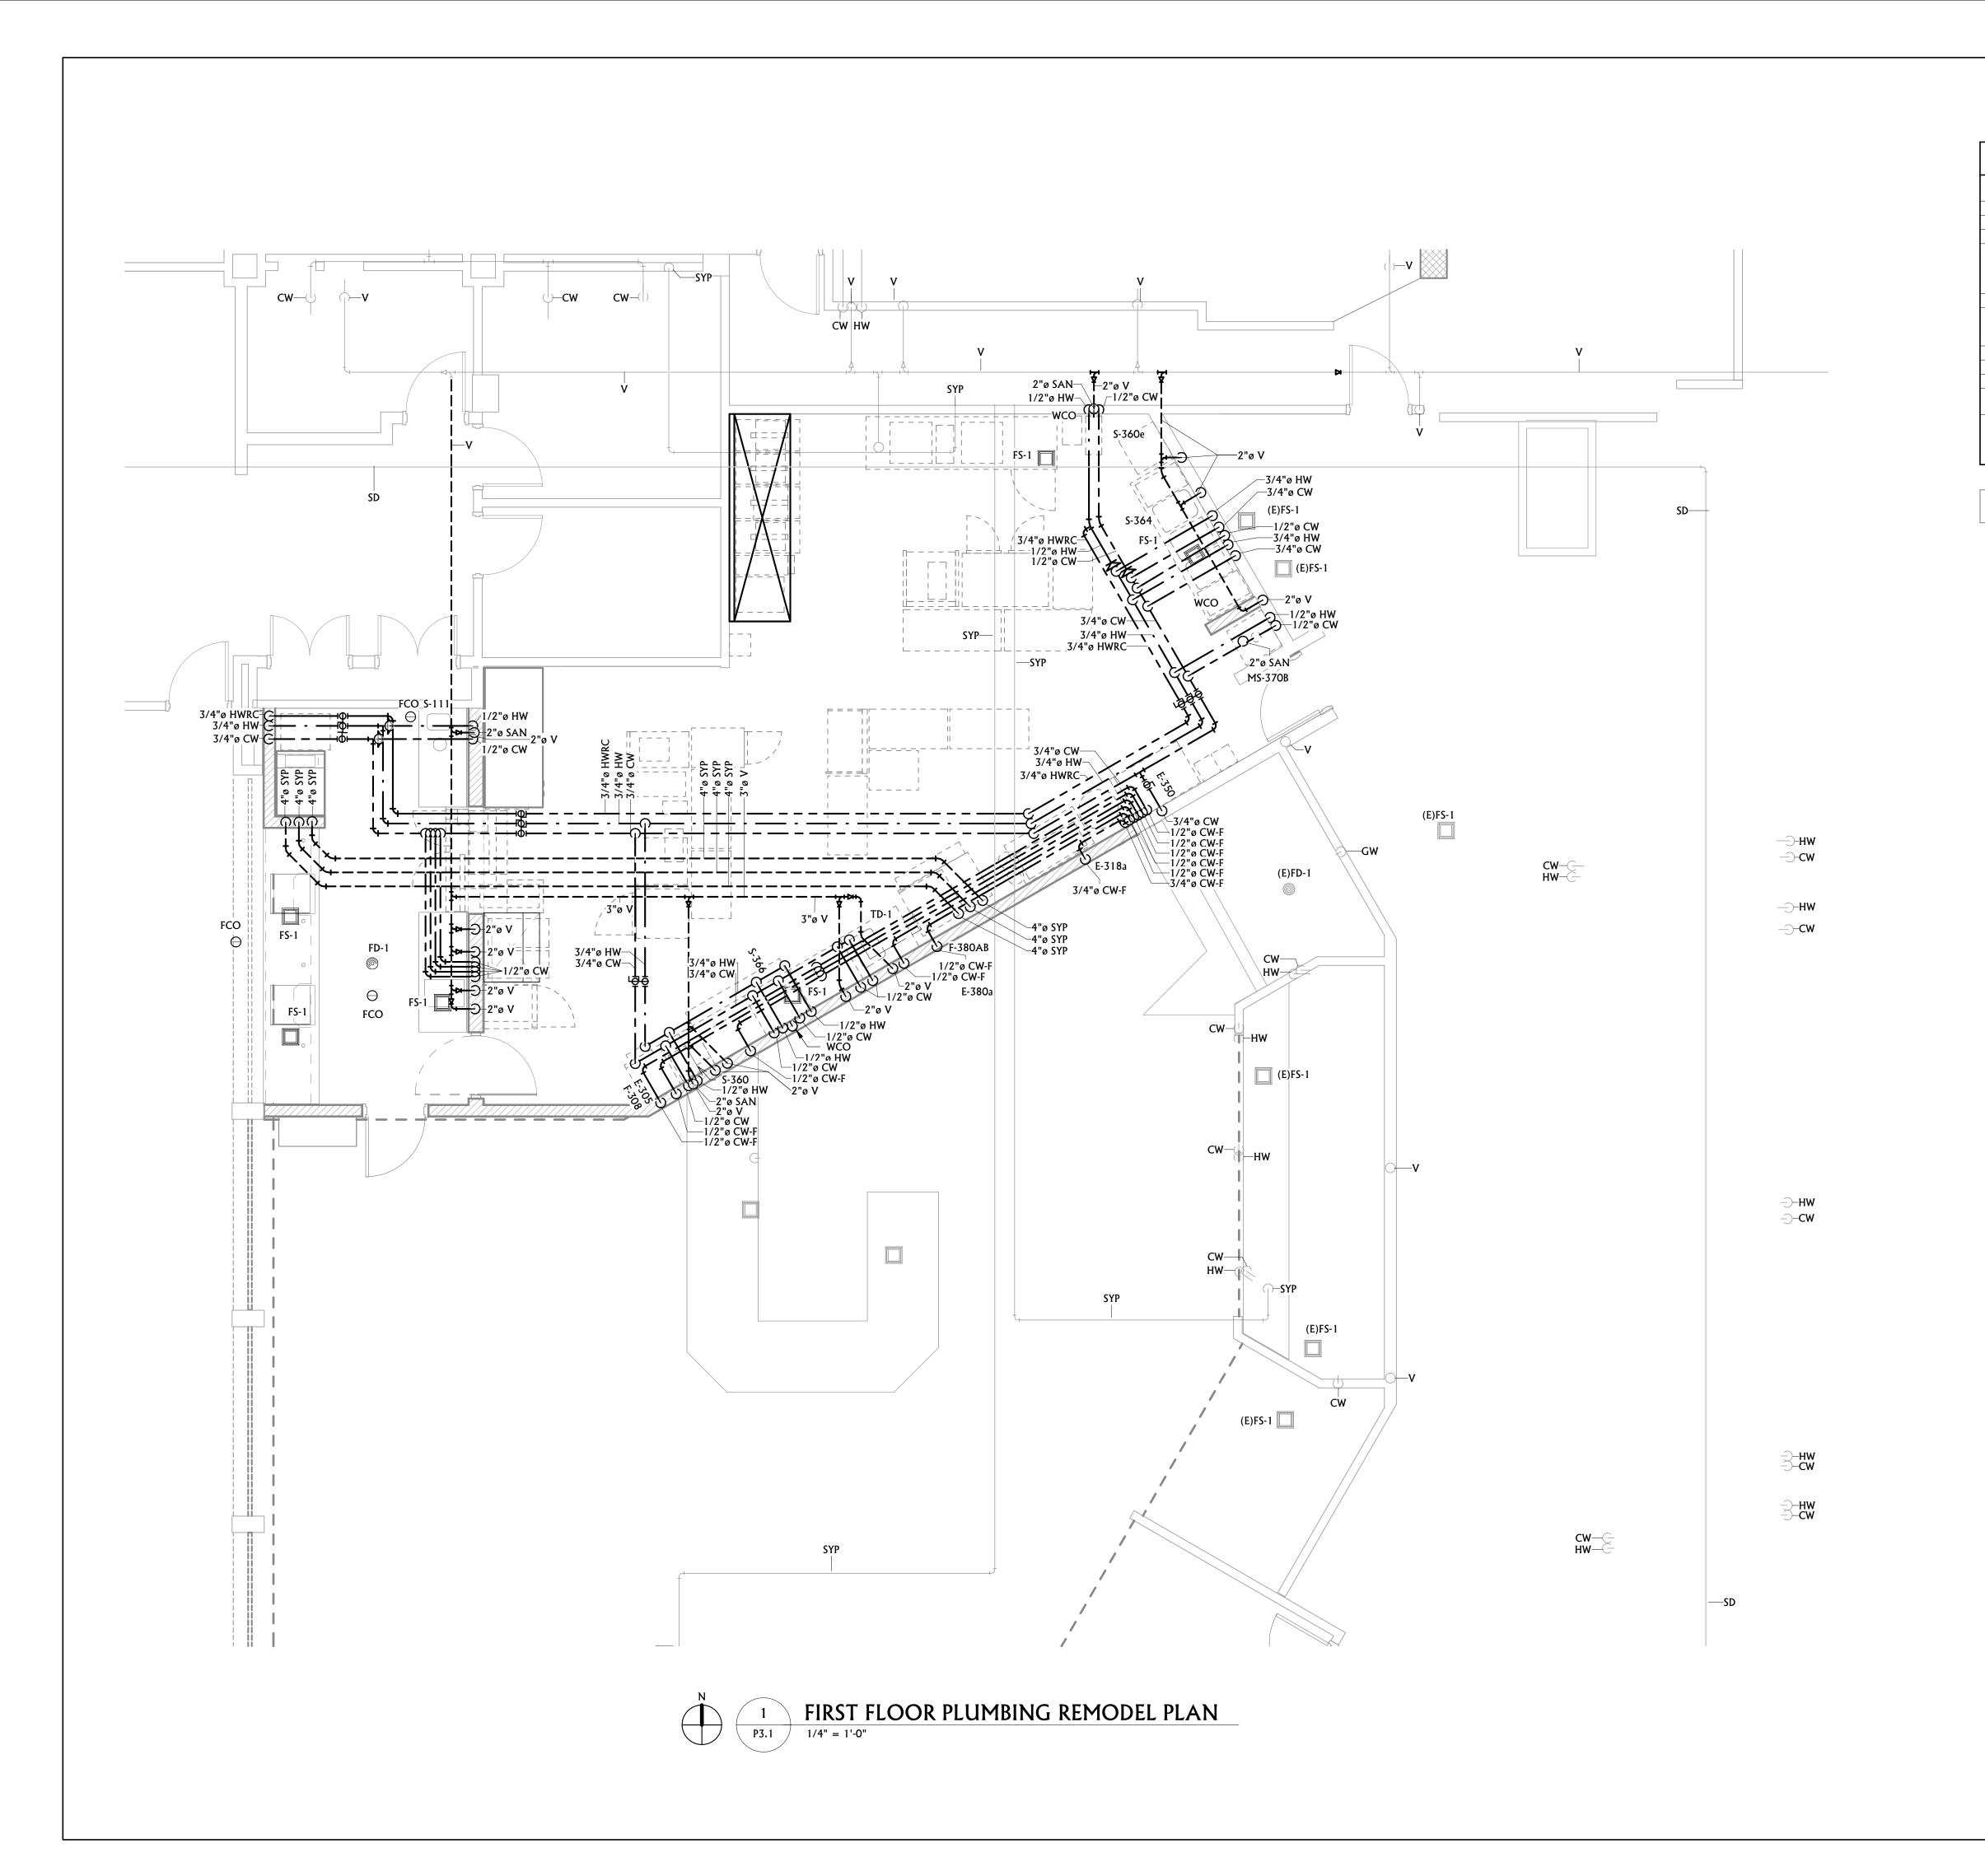


PPA#22-0056 A/E#00-00-00 Consultant #:

SHEET TITLE **BASEMENT** PLUMBING REMODEL

SHEET

P3.0



PLUMBING GENERAL NOTES

- A COORDINATE HVAC AND PLUMBING EQUIPMENT WITH ALL OTHER TRADES AS
- B REFERENCE ARCHITECTURAL PLANS FOR EXACT FIXTURE LOCATIONS.
- C ALL VALVES LESS THAN 2" SHALL BE BALL VALVES UNLESS OTHERWISE NOTED.
- D COORDINATE UNDERSLAB PIPING WITH FOOTINGS AND STEM WALLS. INSULATION ON ALL DOMESTIC COLD WATER PIPING SHALL BE PROVIDED WITH A CONTINUOUS VAPOR BARRIER. OVERSIZE HANGERS FOR INSULATION SO NO PENETRATION OF THE VAPOR BARRIER OCCURS. PROVIDE INSERTS AND SADDLES AS
- REQUIRED TO PREVENT INSULATION DAMAGE FROM SUPP F NO DOMESTIC WATER PIPING SHALL BE ROUTED IN ANY EXTERIOR WALLS.
- G PROVIDE ALL FLOOR DRAINS AND FLOOR SINKS WITH TRAP PRIMERS. PROVIDE WALL ACCESS PANEL FOR TRAP PRIMER ACCESS AS REQUIRED. ACCESS PANELS SHALL BE
- RATED WHERE REQUIRED. H ALL UNDERFLOOR VENT SHALL BE MINIMUM 2".
- ALL UNDERFLOOR COPPER SHALL BE TYPE "K" SEAMLESS.
- PROVIDE CLEANOUTS ON ALL LINES SERVING SINKS AND URINALS.
- K PROVIDE WALL CLEANOUTS ON ALL VENT RISERS SERVING FLOOR RECEPTOR WASTE
- SHALL CUT ALL FLOORS, WALLS, CEILINGS, AND ROOF AS REQUIRED TO PERFORM THE WORK DEPICTED IN THESE CONTRACT DOCUMENTS AND SPECIFICATIONS. GENERAL CONTRACTOR SHALL PATCH ALL ASSOCIATED FLOORS, WALLS, CEILINGS, AND ROOF AS REQUIRED TO THE SATISFACTION OF THE ARCHITECT/ENGINEER.

PLUMBING KEYNOTES




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DOCUMENTS



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PPA#22-0056 A/E#00-00-00 Consultant #:

SHEET TITLE FIRST FLOOR PLUMBING REMODEL PLAN

SHEET

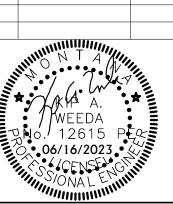P3.1



PLUMBING GENERAL NOTES

- A COORDINATE HVAC AND PLUMBING EQUIPMENT WITH ALL OTHER TRADES AS
- B REFERENCE ARCHITECTURAL PLANS FOR EXACT FIXTURE LOCATIONS.
- C ALL VALVES LESS THAN 2" SHALL BE BALL VALVES UNLESS OTHERWISE NOTED. D COORDINATE UNDERSLAB PIPING WITH FOOTINGS AND STEM WALLS.
- E INSULATION ON ALL DOMESTIC COLD WATER PIPING SHALL BE PROVIDED WITH A CONTINUOUS VAPOR BARRIER. OVERSIZE HANGERS FOR INSULATION SO NO
- PENETRATION OF THE VAPOR BARRIER OCCURS. PROVIDE INSERTS AND SADDLES AS REQUIRED TO PREVENT INSULATION DAMAGE FROM SUPP

ACCESS PANEL FOR TRAP PRIMER ACCESS AS REQUIRED. ACCESS PANELS SHALL BE

- F NO DOMESTIC WATER PIPING SHALL BE ROUTED IN ANY EXTERIOR WALLS. G PROVIDE ALL FLOOR DRAINS AND FLOOR SINKS WITH TRAP PRIMERS. PROVIDE WALL
- RATED WHERE REQUIRED. H ALL UNDERFLOOR VENT SHALL BE MINIMUM 2".
- ALL UNDERFLOOR COPPER SHALL BE TYPE "K" SEAMLESS.
- PROVIDE CLEANOUTS ON ALL LINES SERVING SINKS AND URINALS. K PROVIDE WALL CLEANOUTS ON ALL VENT RISERS SERVING FLOOR RECEPTOR WASTE

REQUIRED TO THE SATISFACTION OF THE ARCHITECT/ENGINEER.

L SHALL CUT ALL FLOORS, WALLS, CEILINGS, AND ROOF AS REQUIRED TO PERFORM THE WORK DEPICTED IN THESE CONTRACT DOCUMENTS AND SPECIFICATIONS. GENERAL CONTRACTOR SHALL PATCH ALL ASSOCIATED FLOORS, WALLS, CEILINGS, AND ROOF AS

PLUMBING KEYNOTES

EXISTING PLUMBING VENT LOCATED AT APPROXIMATE LOCATION.

ROOFTOP EQUIPMENT LOCATED AT APPROXIMATE LOCATION. PROVIDED FOR REFERENCE.




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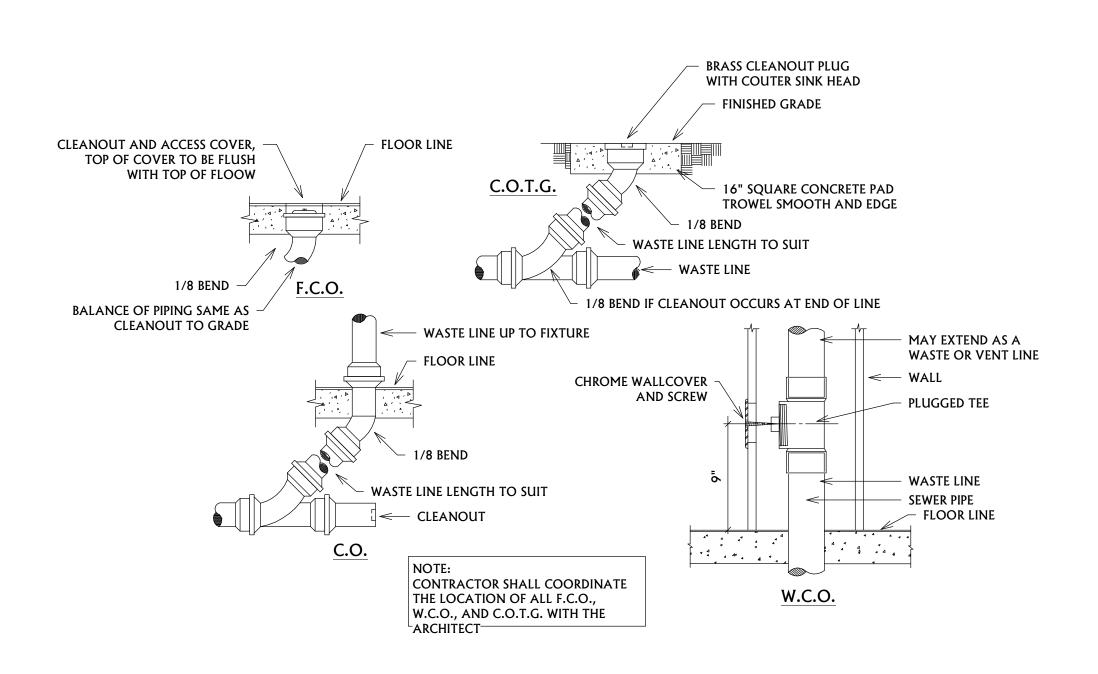
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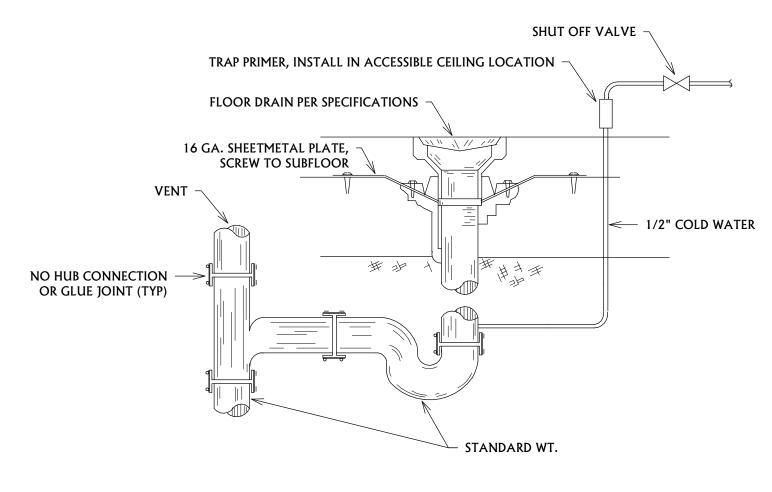



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SHEET TITLE ROOF PLUMBING **REMODEL PLAN**

SHEET



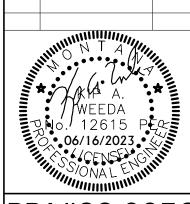


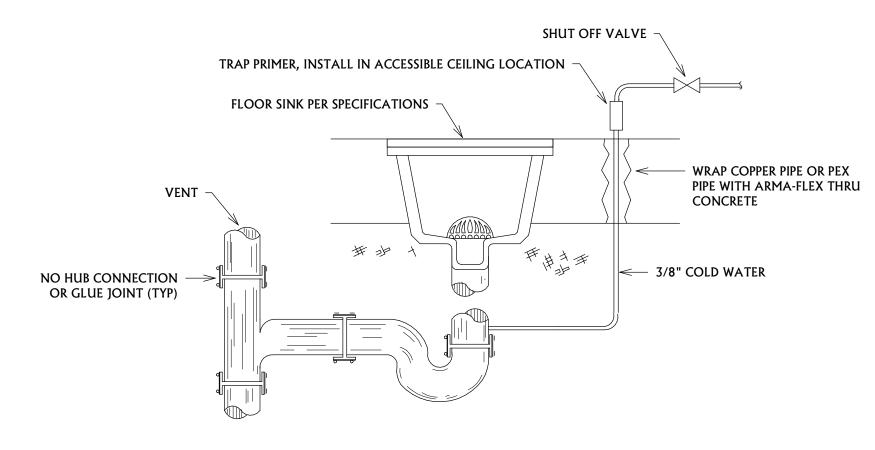

CLEAN OUT DETAILS

FLOOR DRAIN DETAIL

FLOOR SINK DETAIL

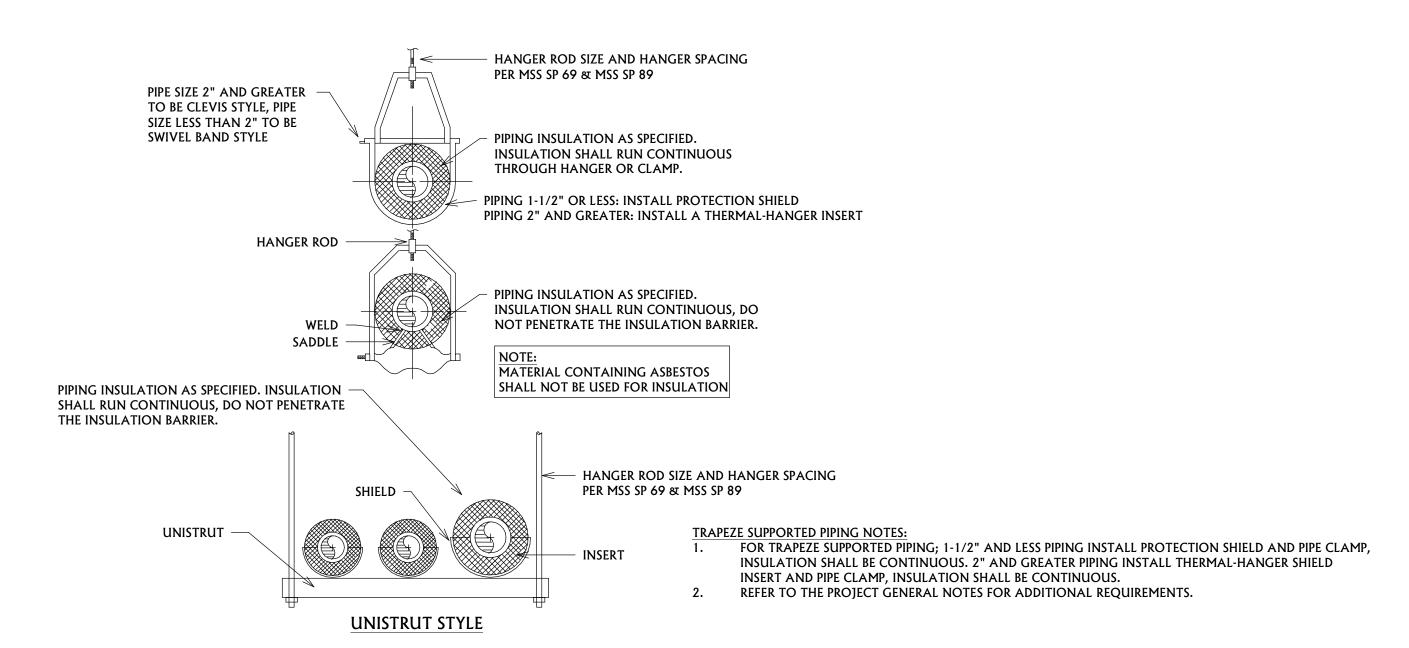





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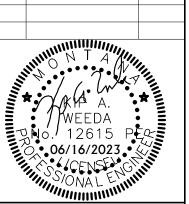
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SHEET TITLE PLUMBING DETAILS

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