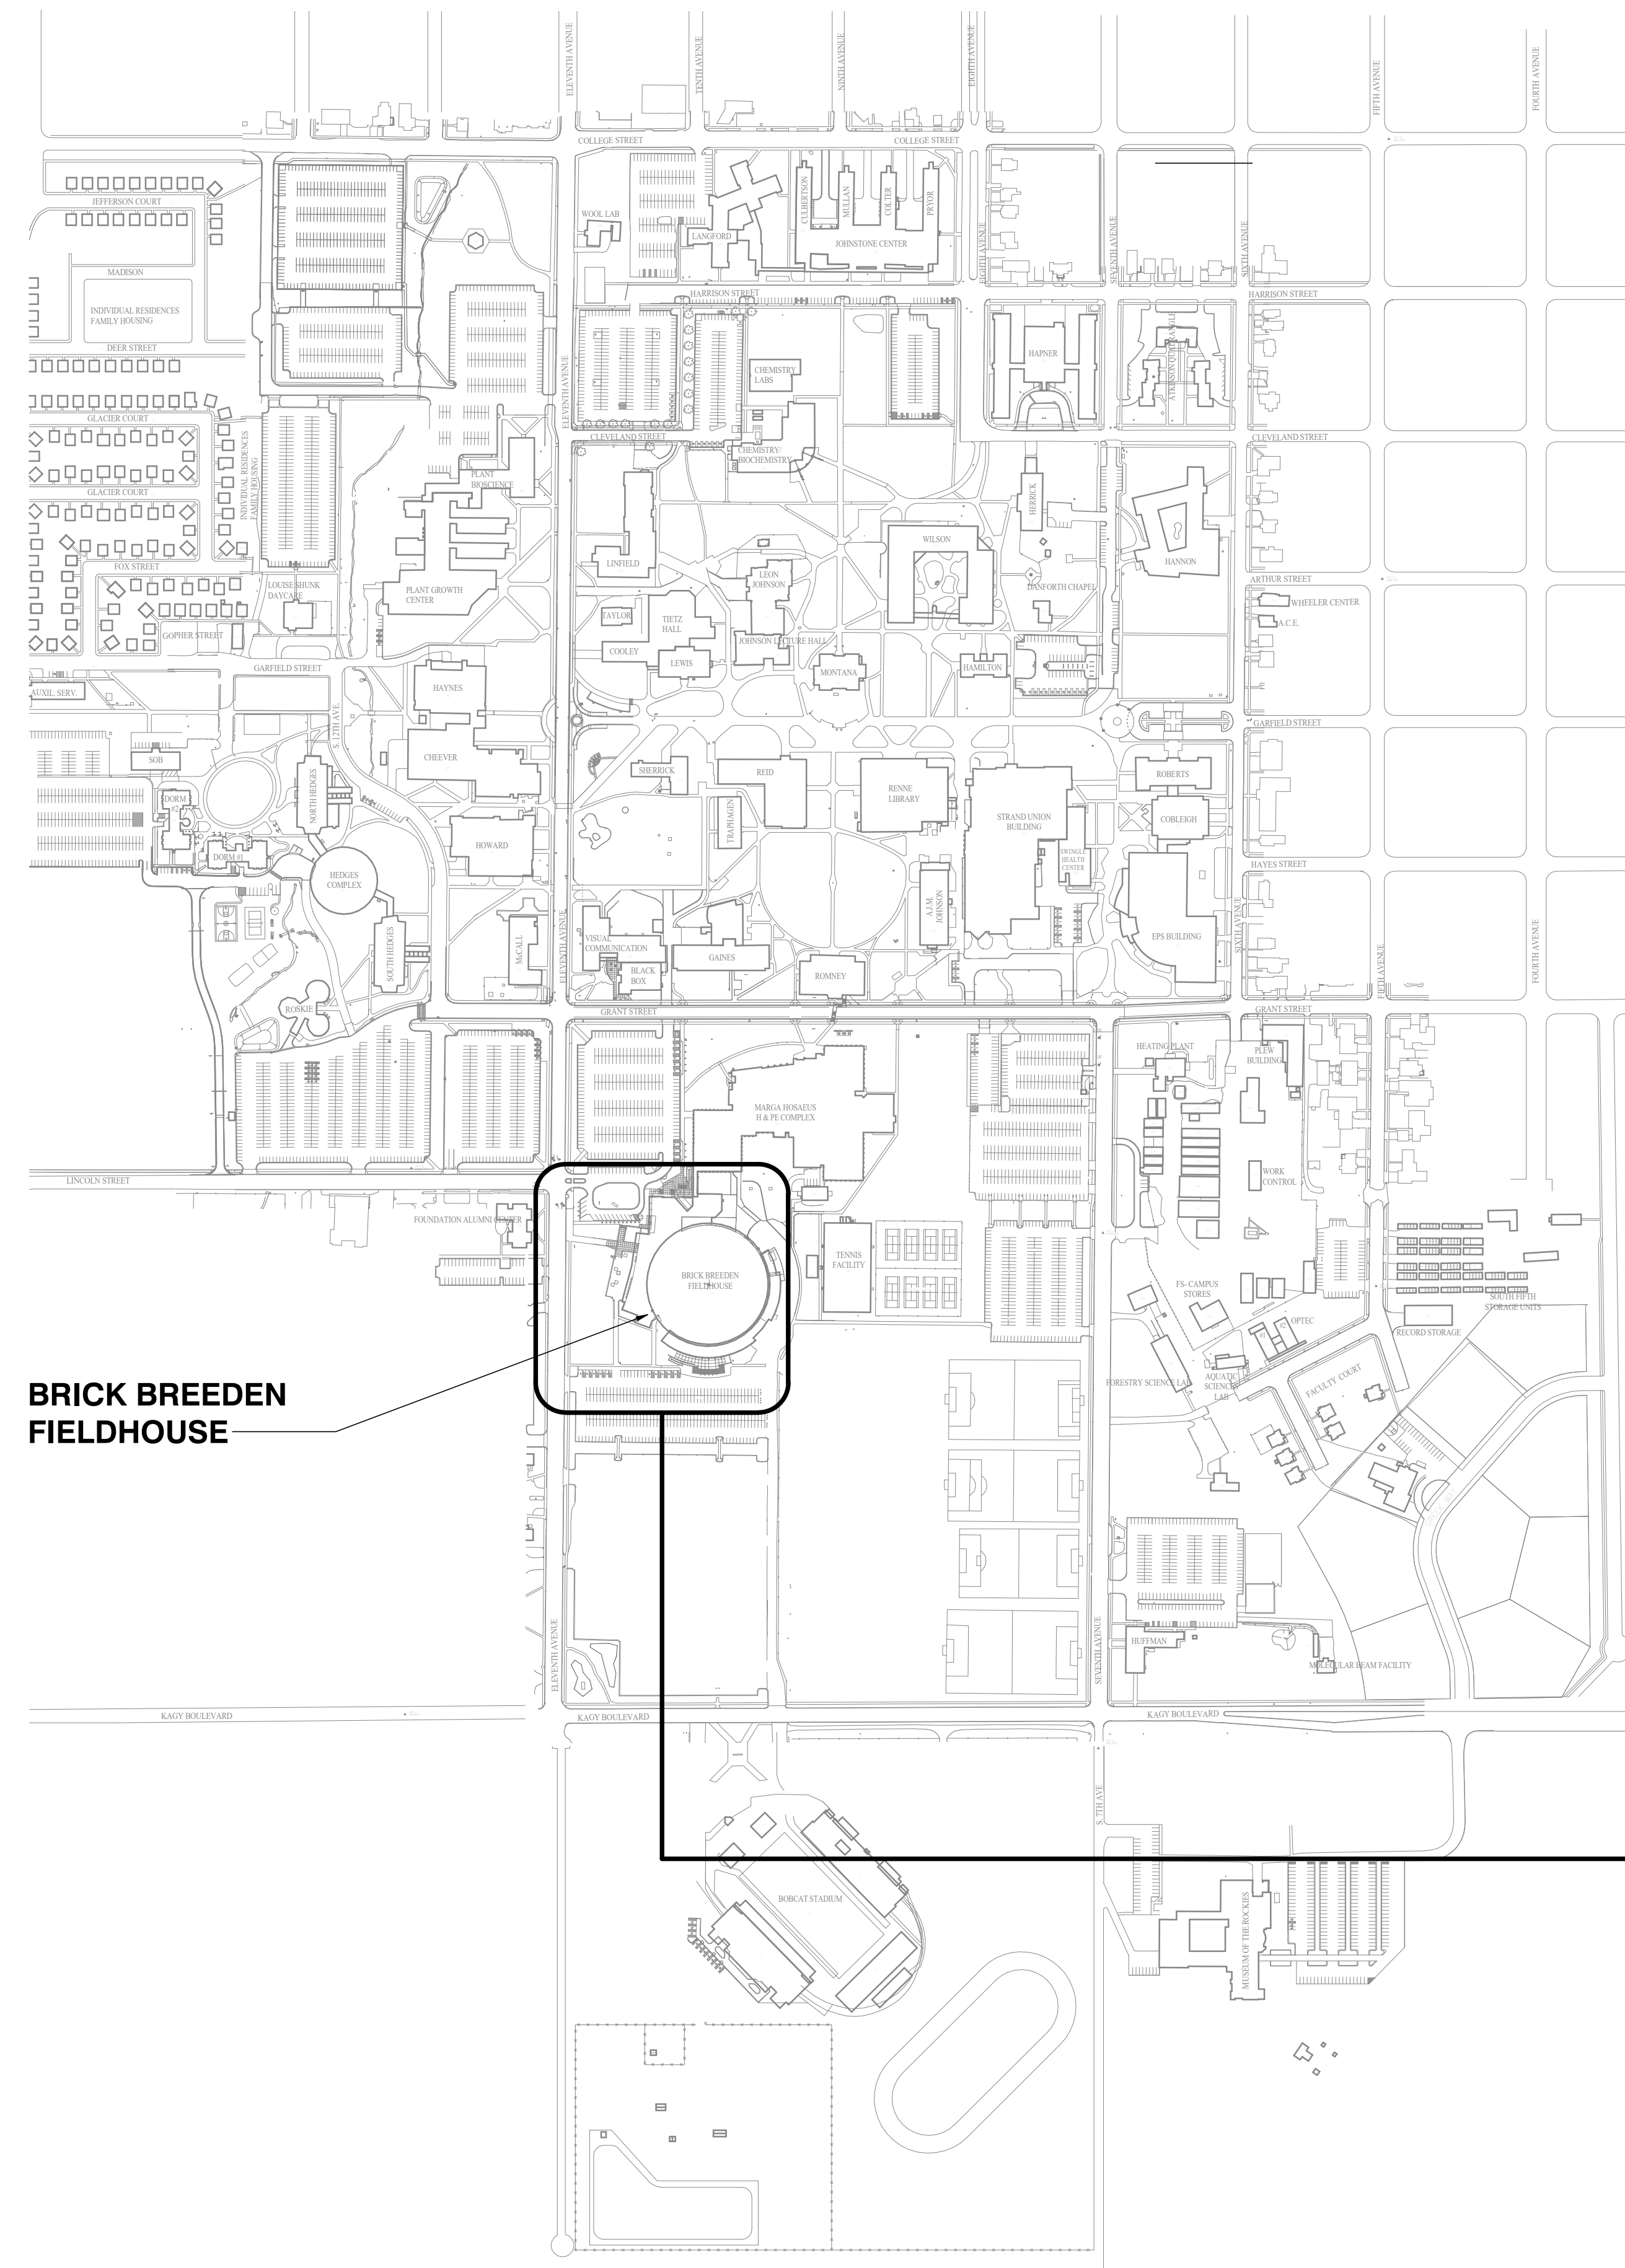


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BRICK BREEDEN FIELDHOUSE

BRICK BREEDEN FIELD HOUSE - WEST ENTRANCE ROOF RETROFIT

STRUCTURAL DRAWINGS

- S0.1 STRUCTURAL - GENERAL NOTES
- S0.2 STRUCTURAL - GENERAL NOTES & SLIDING SNOW LOAD PLAN
- S1.1 STRUCTURAL - (E) & (N) FOUNDATION PLANS
- S2.1 STRUCTURAL - (E) & (N) ROOF FRAMING PLANS
- S5.1 STRUCTURAL - FRAMING DETAILS
- S5.2 STRUCTURAL - FRAMING DETAILS

ARCHITECTURAL DRAWINGS


- A1.0 ARCHITECTURAL FLOOR PLAN
- A1.1 ARCHITECTURAL ROOF PLAN
- A1.2 ARCHITECTURAL ROOF DETAILS
- A5.1 ARCHITECTURAL FINISH PLAN
- A9.1 ARCHITECTURAL REFLECTED CEILING PLAN

MECHANICAL DRAWINGS

- M1.1 ARENA LEVEL PLAN WEST - PIPING
- M1.2 ROOF PLAN WEST
- M2.1 ARENA LEVEL PLAN WEST - HVAC
- M3.1 ARENA LEVEL PLAN WEST - FIRE SPRINKLER
- M4.1 MECHANICAL DETAILS, SCHEDULES AND LEGEND

ELECTRICAL DRAWINGS

- E1.1 ARENA LEVEL PLAN WEST - POWER
- E2.2 ARENA LEVEL PLAN WEST - LIGHTING

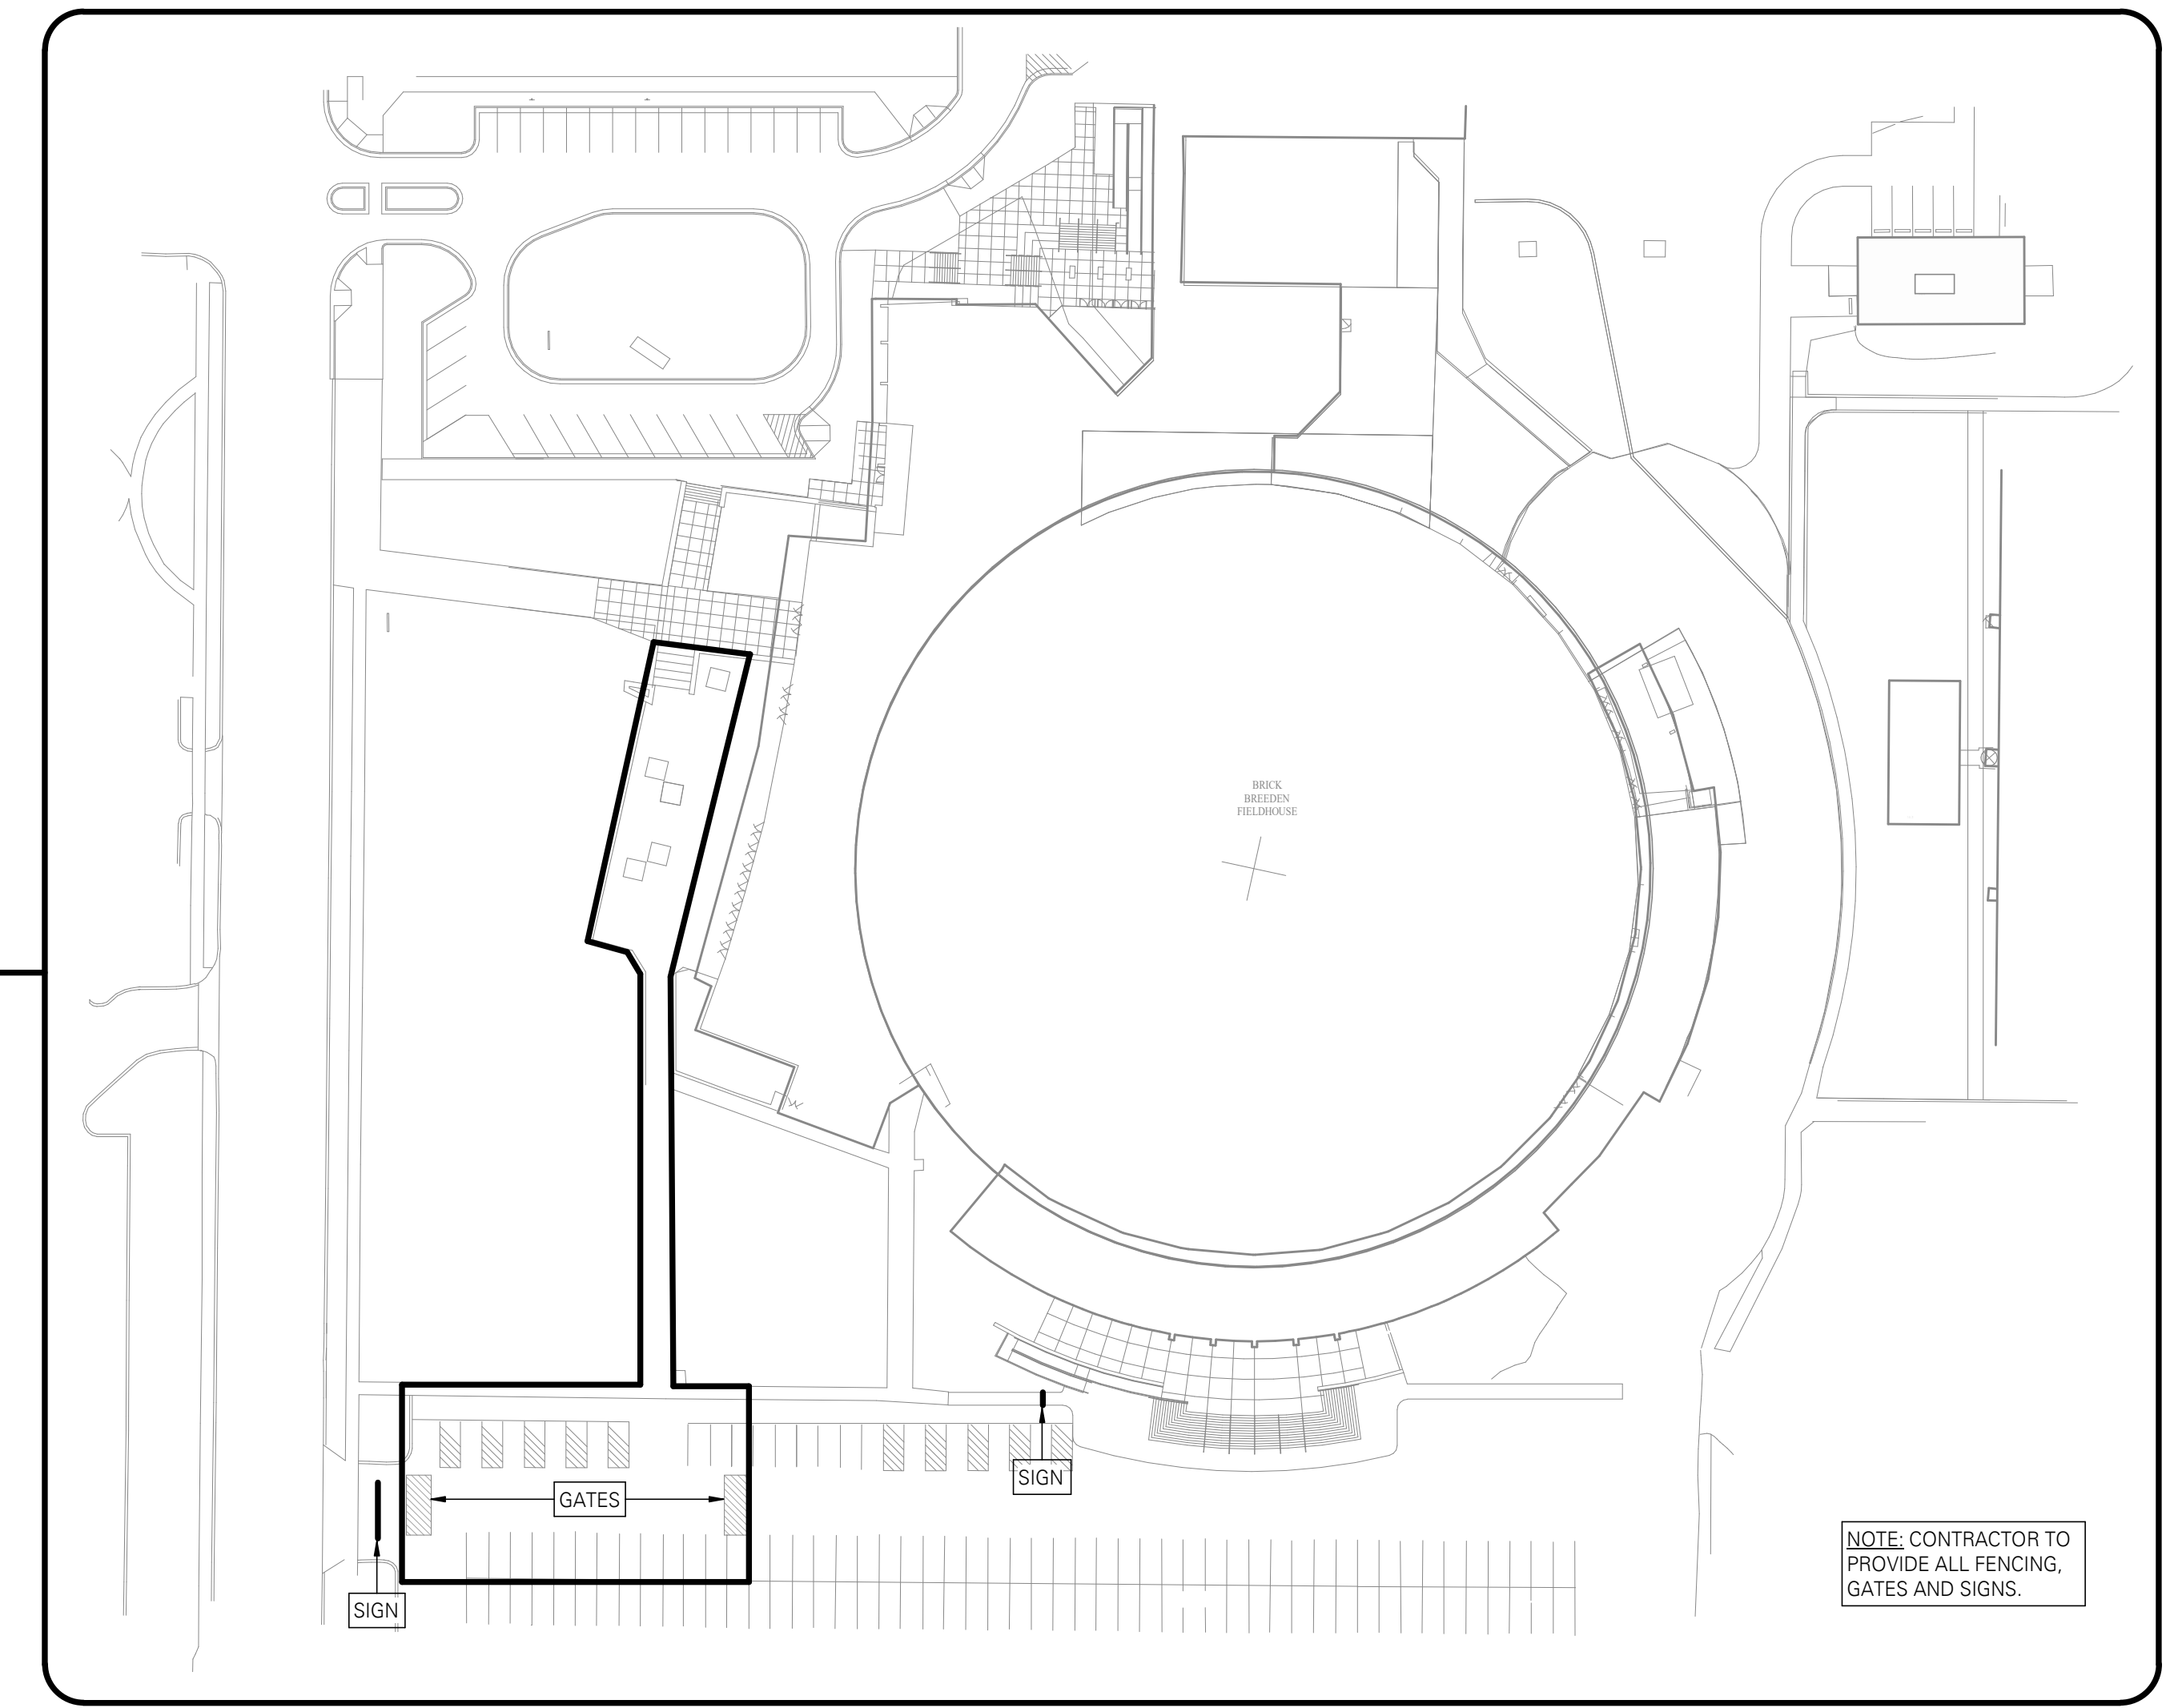

STAGING AREA

NOTE: CONTRACTOR TO PROVIDE ALL FENCING, GATES AND SIGNS.

BRICK BREEDEN FIELDHOUSE WEST ENTRANCE ROOF RETROFIT PPA#19-0172 MONTANA STATE UNIVERSITY, BOZEMAN, MONTANA


MONTANA STATE UNIVERSITY
 CAMPUS PLANNING DESIGN & CONSTRUCTION DIVISION
 PO BOX 172760
 BOZEMAN, MONTANA 59717.2760
 PHONE: 406-994-5413

STRUCTURAL
 DCI ENGINEERS
 1060 FOWLER AVE
 SUITE 202
 BOZEMAN, MONTANA 59715
 WWW.DCI-ENGINEERS.COM
 PHONE: 406-556-8600
 CONTACT PERSON: JAMI LORENZ, PE

ARCHITECTURAL
 CUSHING TERRELL
 411 EAST MAIN STREET #101
 BOZEMAN, MONTANA 59715
 WWW.CUSHINGTERRELL.COM
 PHONE: 406-556-7100
 CONTACT PERSON: CHELSEA HOLLING,
 HISTORIC PRESERVATION DESIGN PROFESSIONAL

MECHANICAL
 CONSULTING DESIGN SOLUTIONS, INC
 7540 CHURCHILL RD
 MANHATTAN, MONTANA 59741
 WWW.CDSIENGINEERING.COM
 PHONE: 406-282-7082
 CONTACT PERSON: CURTIS L. SMIT, PE

ELECTRICAL
 CONSULTING DESIGN SOLUTIONS, INC
 7540 CHURCHILL RD
 MANHATTAN, MONTANA 59741
 WWW.CDSIENGINEERING.COM
 PHONE: 406-282-7082
 CONTACT PERSON: SCOTT ELDERS, PE

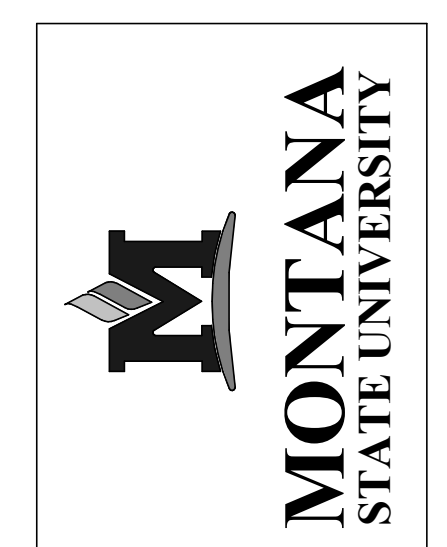

MSU-CPDC
 MONTANA STATE UNIVERSITY
 BOZEMAN, MONTANA
 PHONE: 406-994-5413
 FAX: 406-994-5665

DCI ENGINEERS
 1060 Fowler Ave, Suite 202
 Bozeman, Montana 59715
 P: 406.556.8600
 F: 406.556.8600
 WWW.DCI-ENGINEERS.COM
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Brick Breeden Fieldhouse West Entrance Roof Retrofit





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CD	95% REVIEW	07/28/20
CD	100% CD	11/01/20

PPA# 19-0172

20151-0060
 SHEET TITLE
 STRUCTURAL - COVER SHEET

SHEET
COVER

DATE
11/01/20

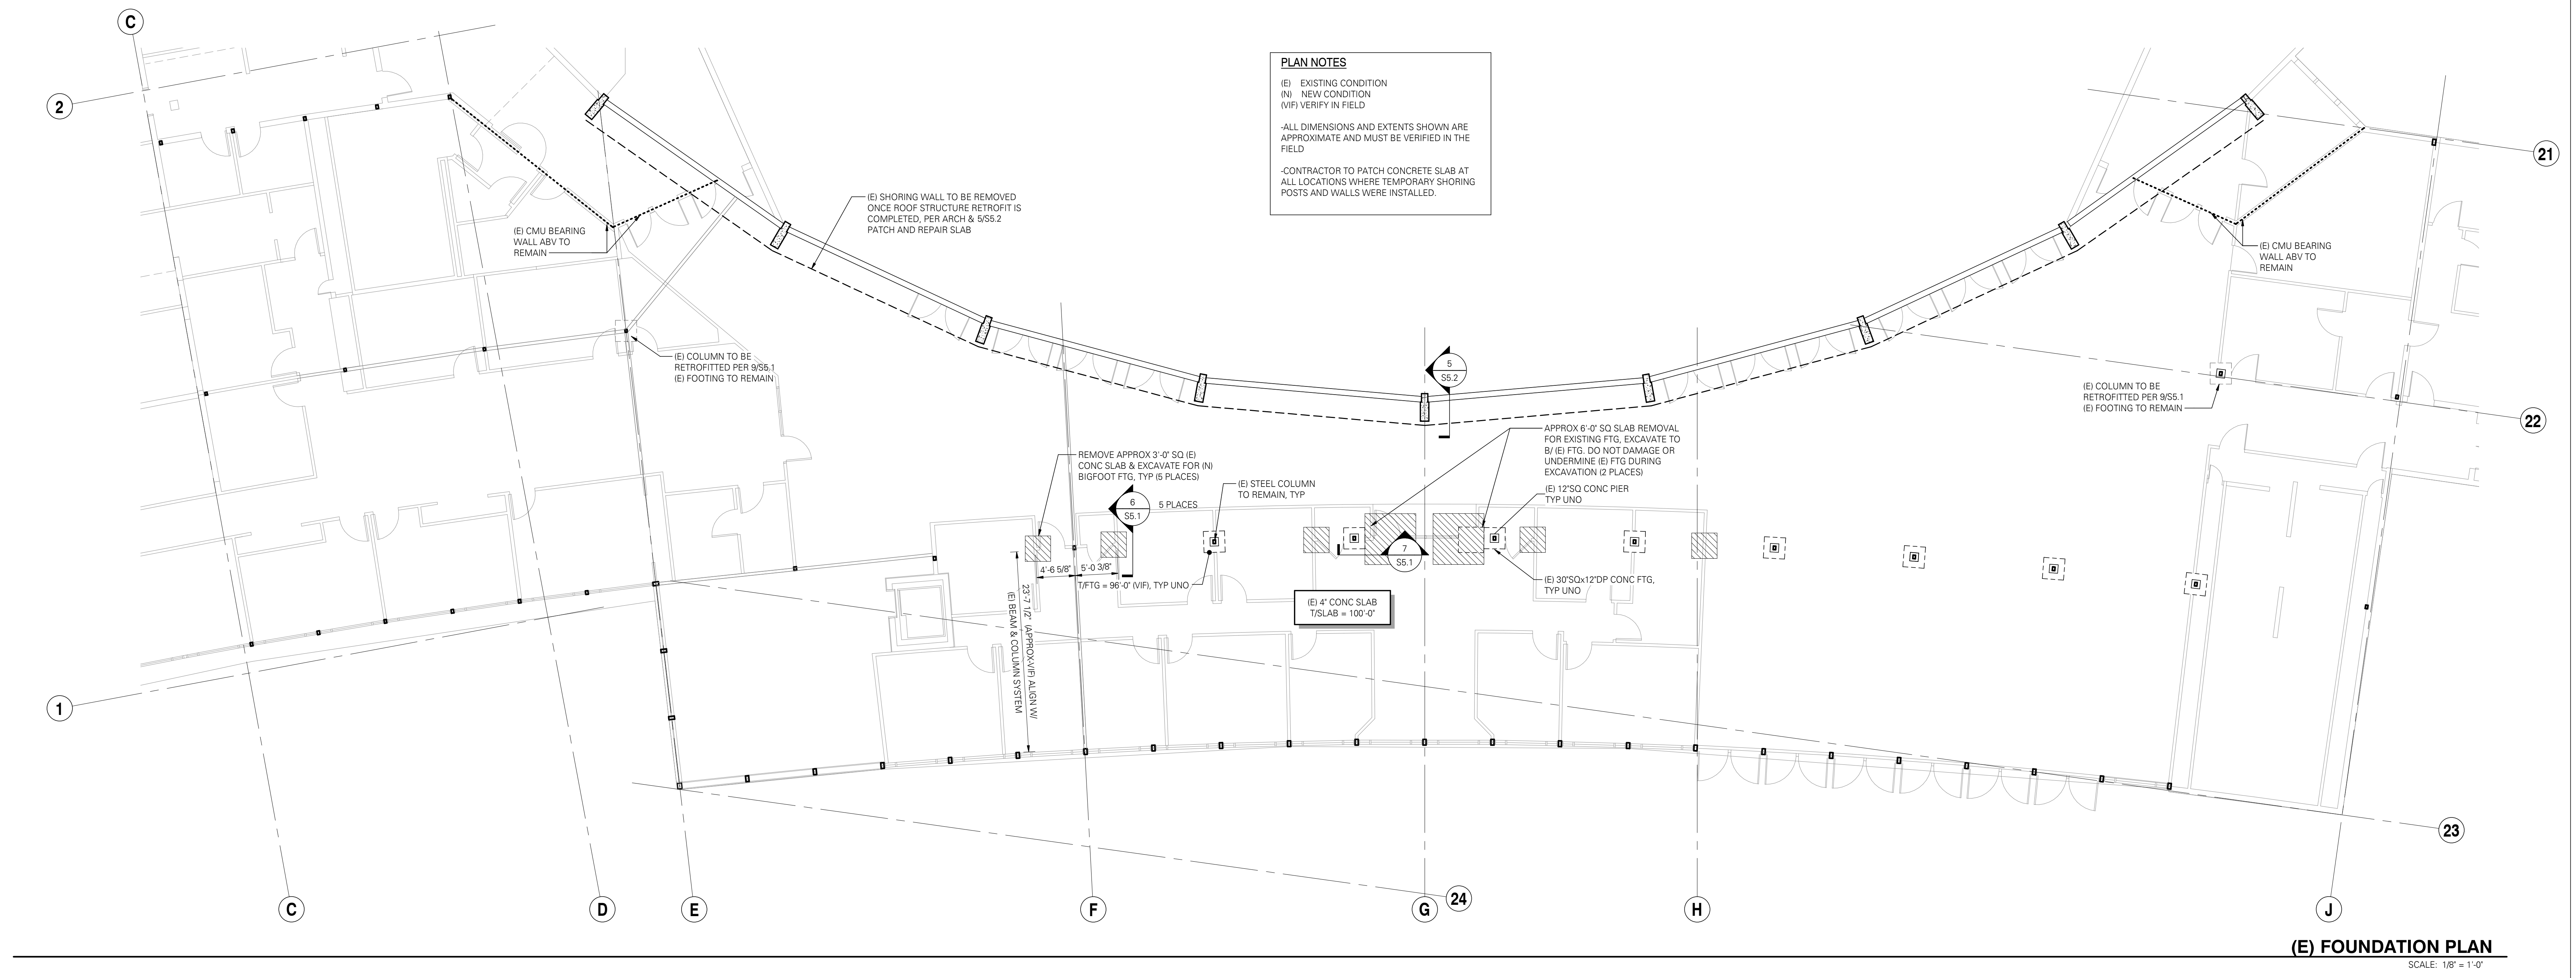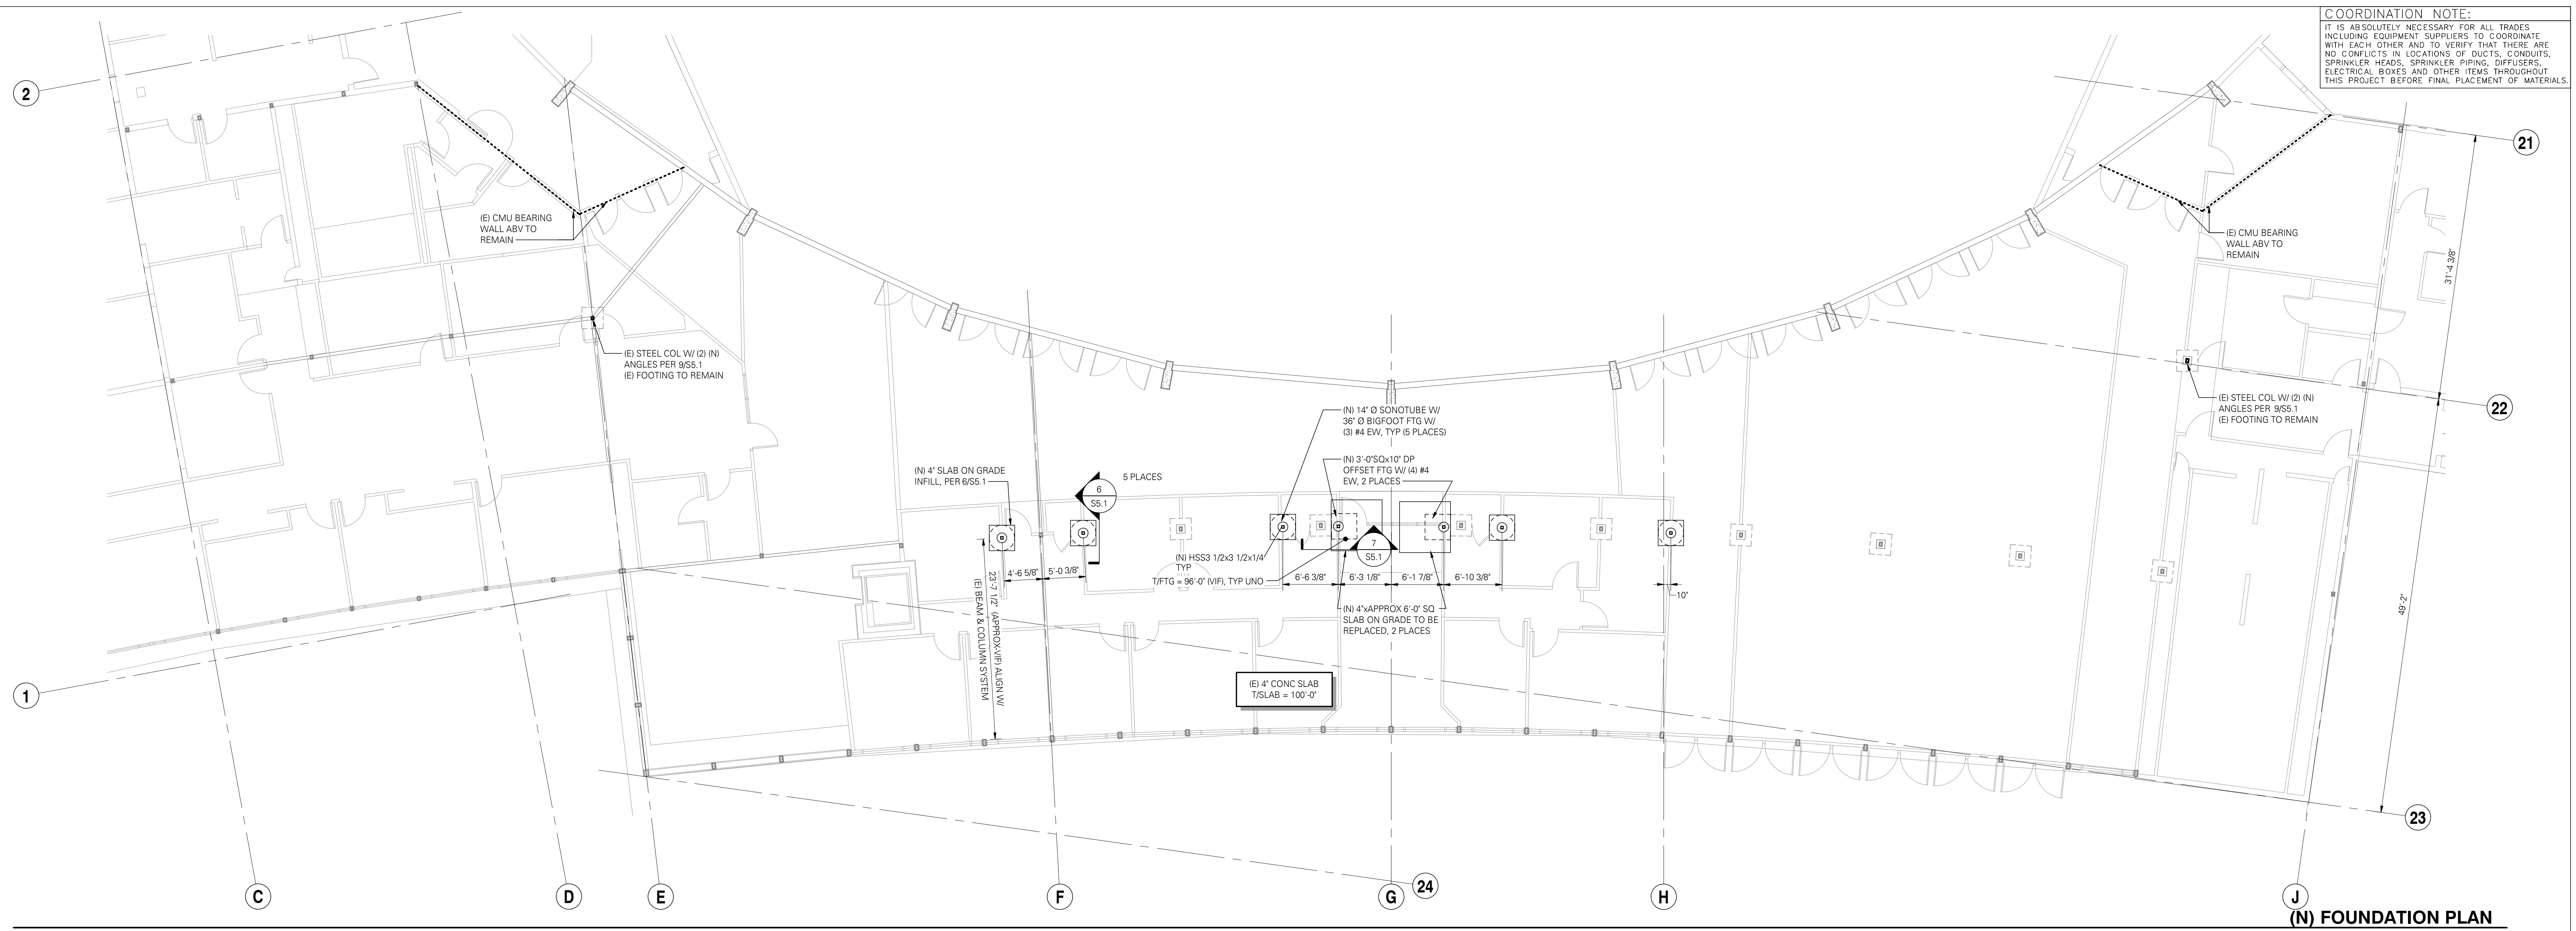


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REV	DESCRIPTION	DATE
#	DESCRIPTION	DD/MM
SD	SCHEMATIC DESIGN	04/10/20
CD	95% REVIEW	07/28/20
CD	100% CD	11/01/20

PPA# 19-0172

20151-0060

SHEET TITLE
STRUCTURAL - (E) & (N)
FOUNDATION PLANS

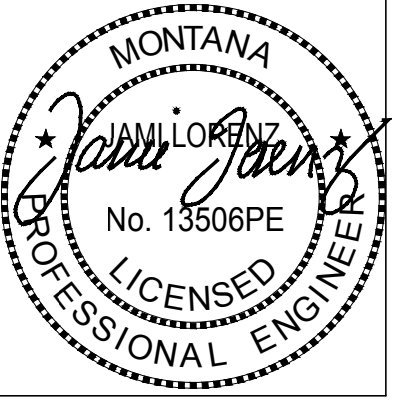SHEET
S1.1

DATE
11/01/20

DRAWN BY	JNH	
REVIEWED BY	JML	
REV#	DESCRIPTION	DATE
#	DESCRIPTION	DD/MM
SD	SCHEMATIC DESIGN	04/10/20
CD	95% REVIEW	07/28/20
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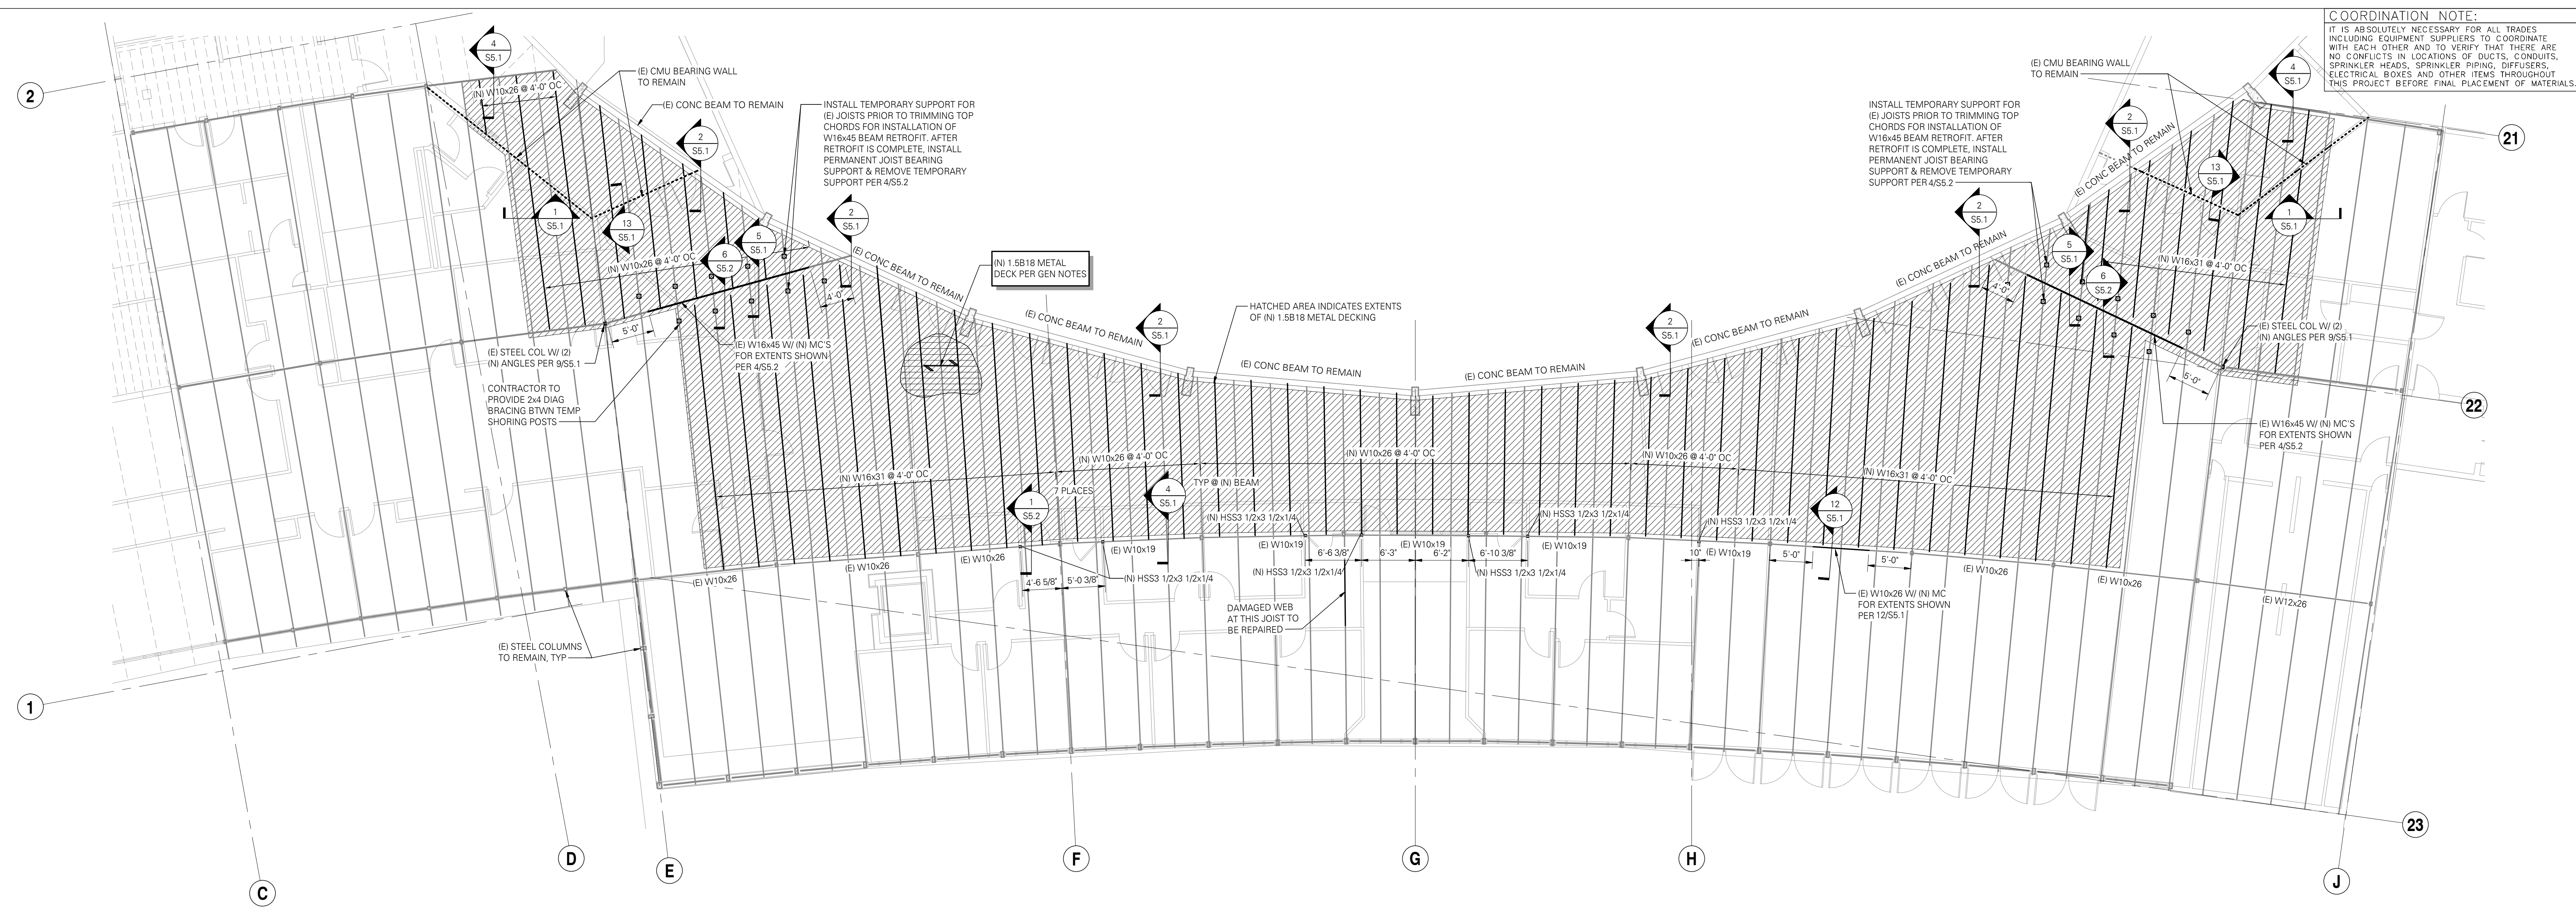
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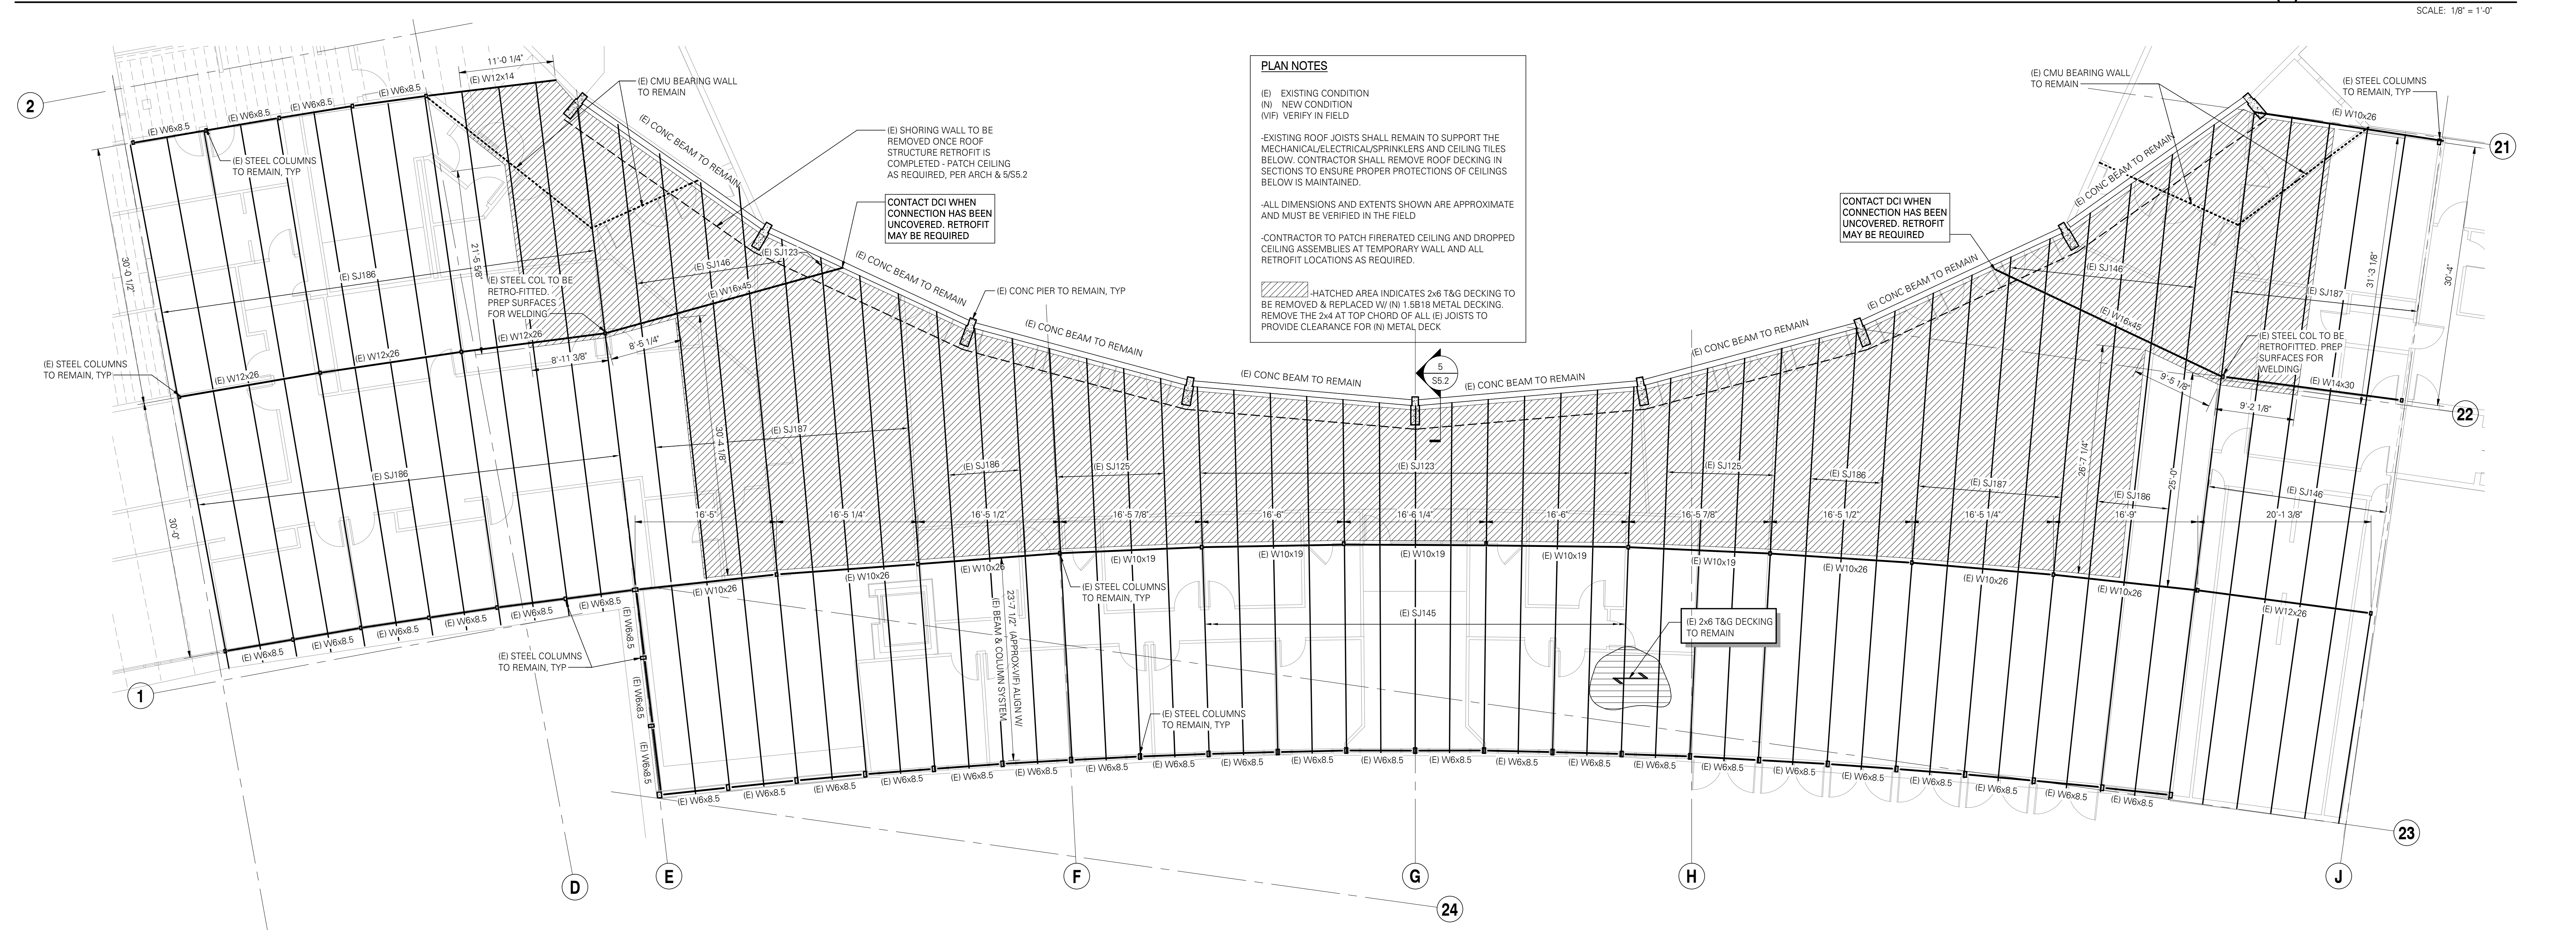
SHEET TITLE
 STRUCTURAL - (E) & (N) ROOF FRAMING PLANS

SHEET
S2.1

DATE
11/01/20



(N) ROOF FRAMING PLAN
 SCALE: 1/8" = 1'-0"



(E) ROOF FRAMING PLAN
 SCALE: 1/8" = 1'-0"

PLAN NOTES

(E) EXISTING CONDITION
 (N) NEW CONDITION
 (VF) VERIFY IN FIELD

-EXISTING ROOF JOISTS SHALL REMAIN TO SUPPORT THE MECHANICAL/ELECTRICAL/SPRINKLERS AND CEILING TILES BELOW. CONTRACTOR SHALL REMOVE ROOF DECKING IN SECTIONS TO ENSURE PROPER PROTECTIONS OF CEILING BELOW IS MAINTAINED.

-ALL DIMENSIONS AND EXTENTS SHOWN ARE APPROXIMATE AND MUST BE VERIFIED IN THE FIELD

-CONTRACTOR TO PATCH FIBERED CEILING AND DROPPED CEILING ASSEMBLIES AT TEMPORARY WALL AND ALL RETROFIT LOCATIONS AS REQUIRED.

HATCHED AREA INDICATES 2x6 T&G DECKING TO BE REMOVED & REPLACED W/ (N) 1.5B18 METAL DECKING. REMOVE THE 2x4 AT TOP CHORD OF ALL (E) JOISTS TO PROVIDE CLEARANCE FOR (N) METAL DECK

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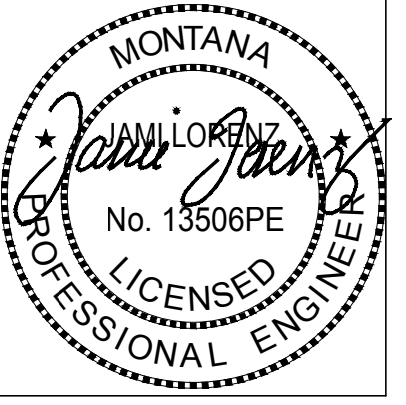


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 MONTANA STATE UNIVERSITY
 BOZEMAN, MONTANA
 PHONE: 406.994.5413
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EDCI
 ENGINEERING
 1080 Fowler Ave., Suite 202
 Bozeman, Montana 59717
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 F: 406.994.5653
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**Brick Breeden Fieldhouse
 West Entrance Roof Retrofit**



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REVIEWED BY: JML		
REV#	DESCRIPTION	DATE
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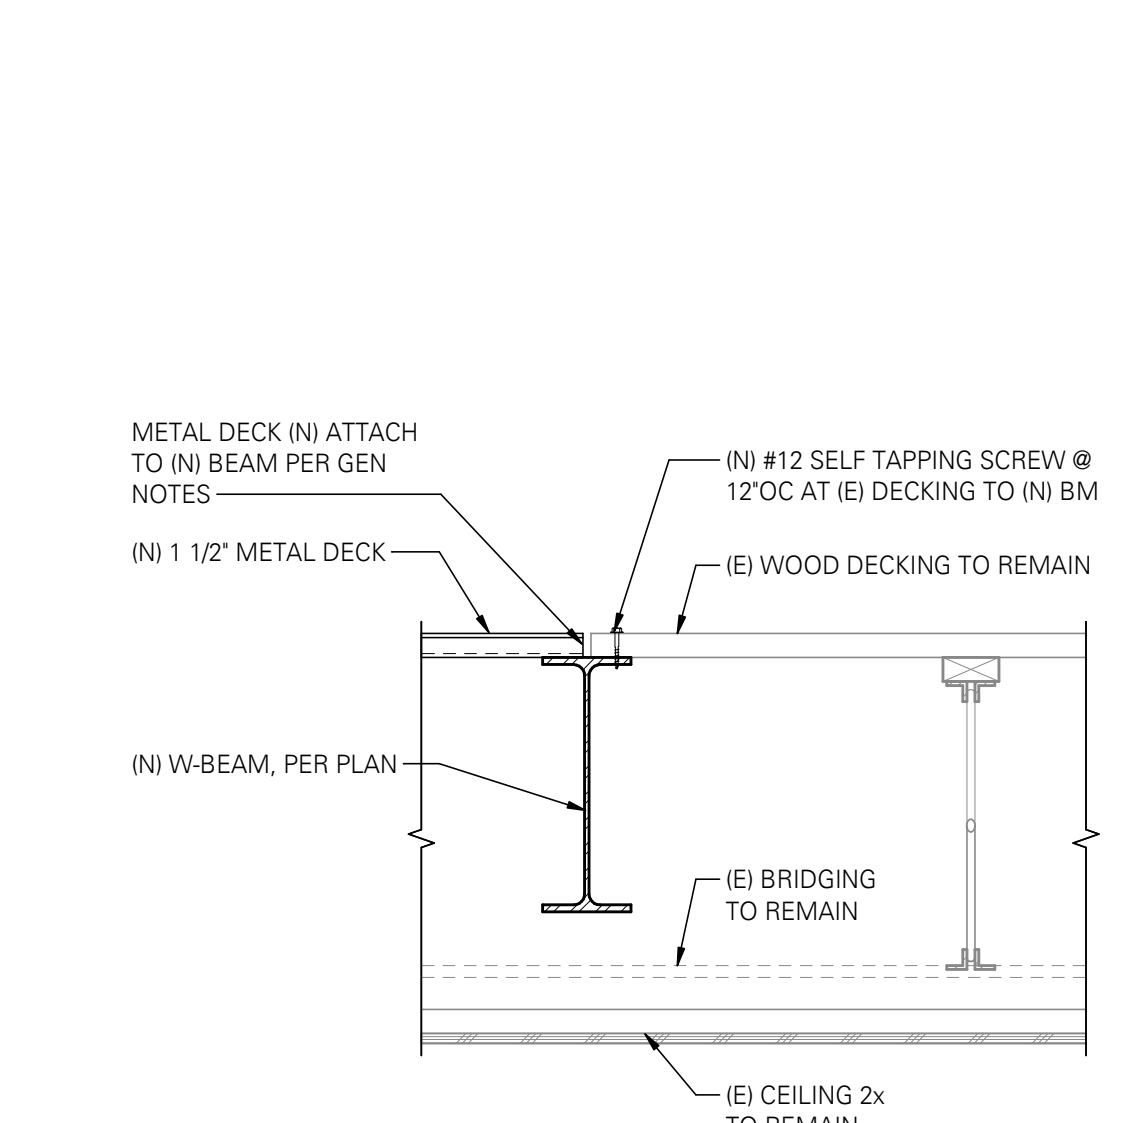
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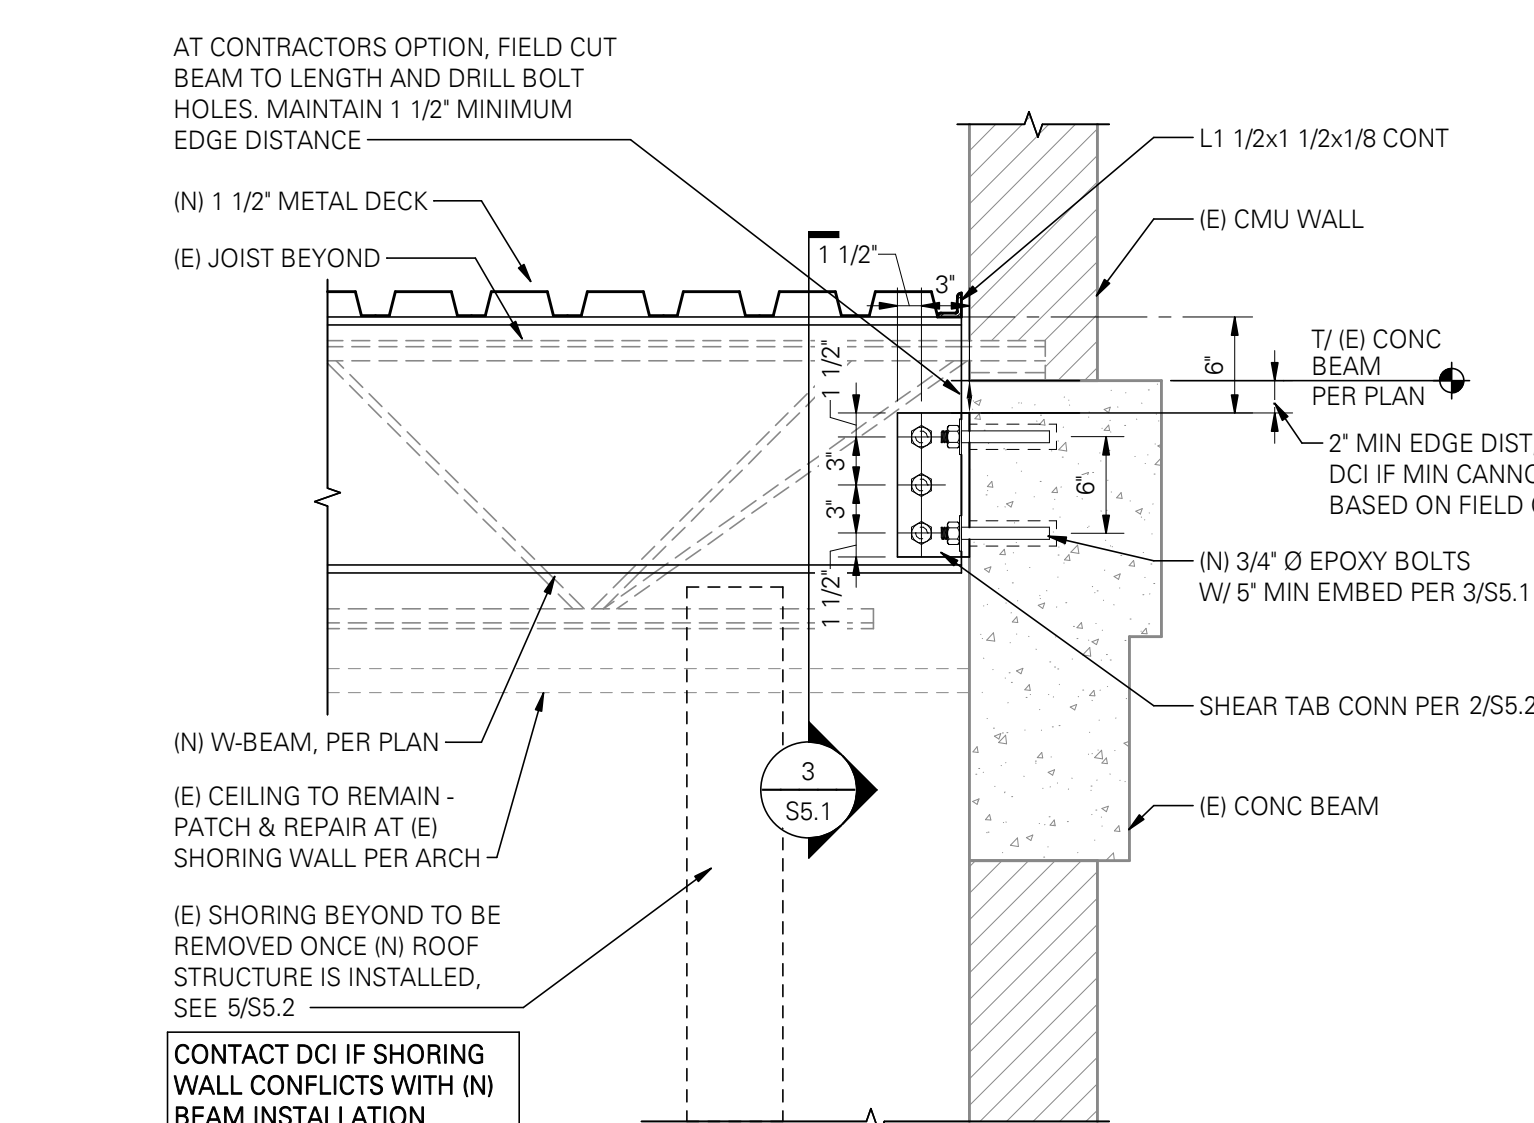
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 STRUCTURAL - FRAMING
 DETAILS

SHEET
S5.1


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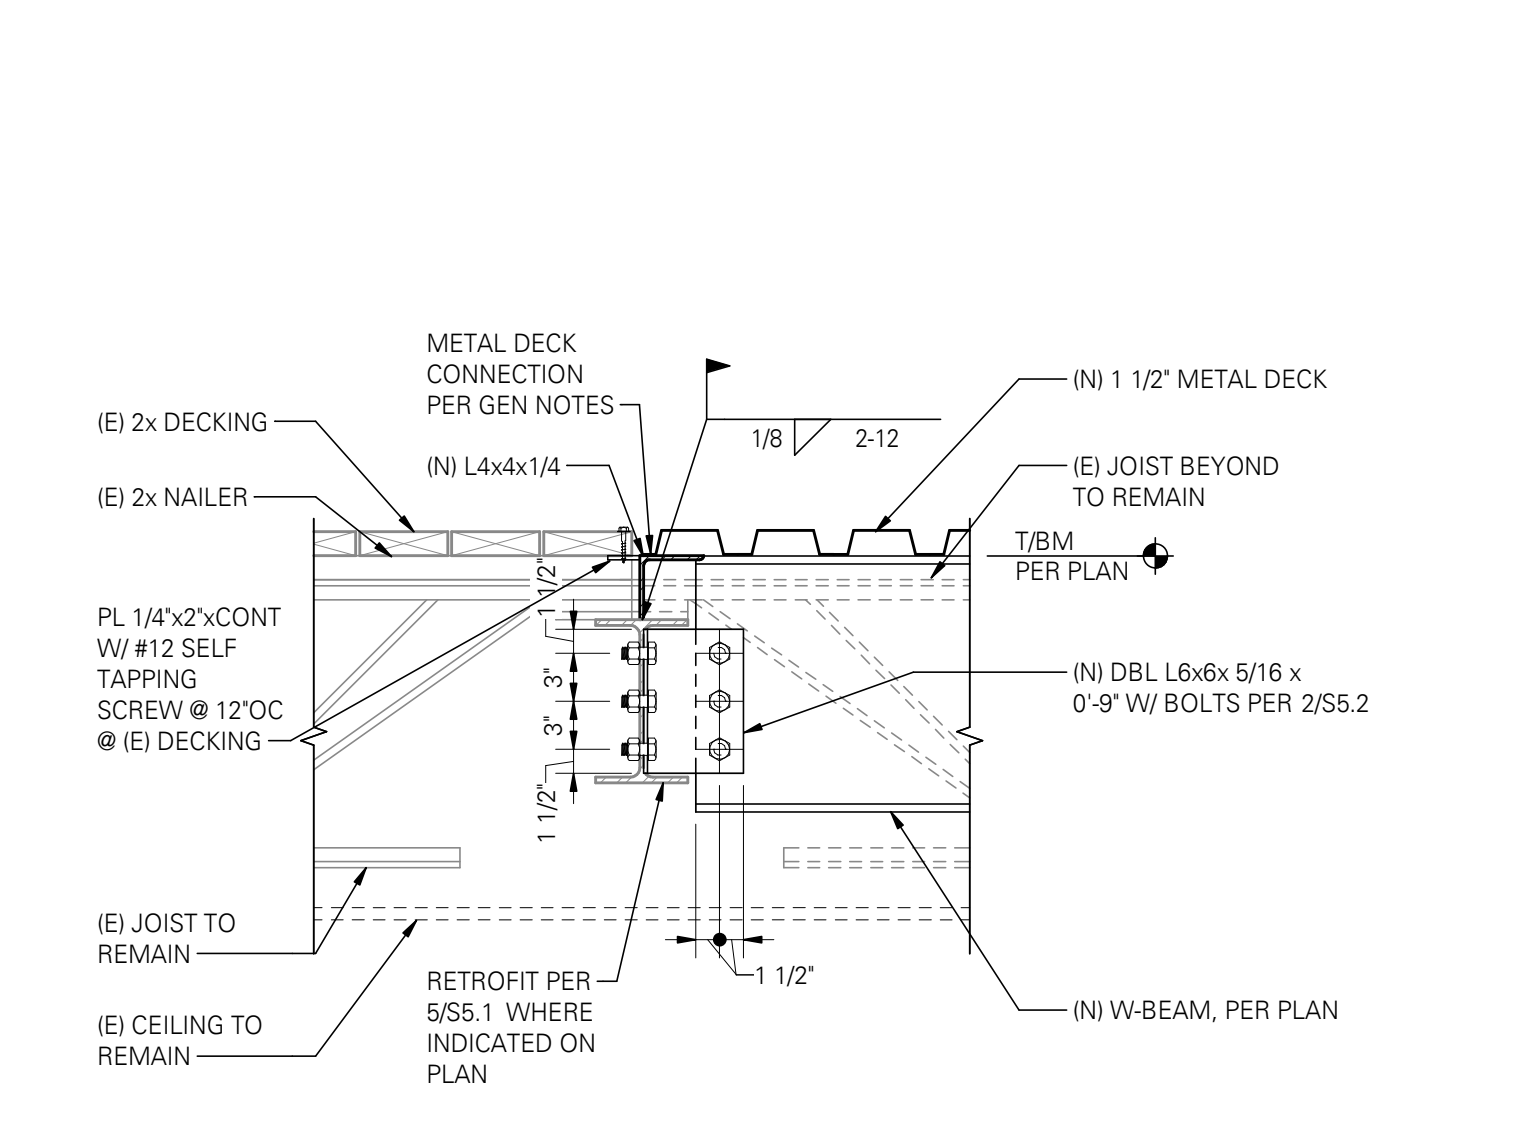
1 TRANSITION AT ROOF EDGE
 SCALE: 1" = 1'-0"




2 (N) W-BEAM AT (E) CONCRETE BEAM
 SCALE: 1" = 1'-0"




3 (N) W-BEAM & (E) JOIST AT (E) CONCRETE BEAM
 SCALE: 1" = 1'-0"

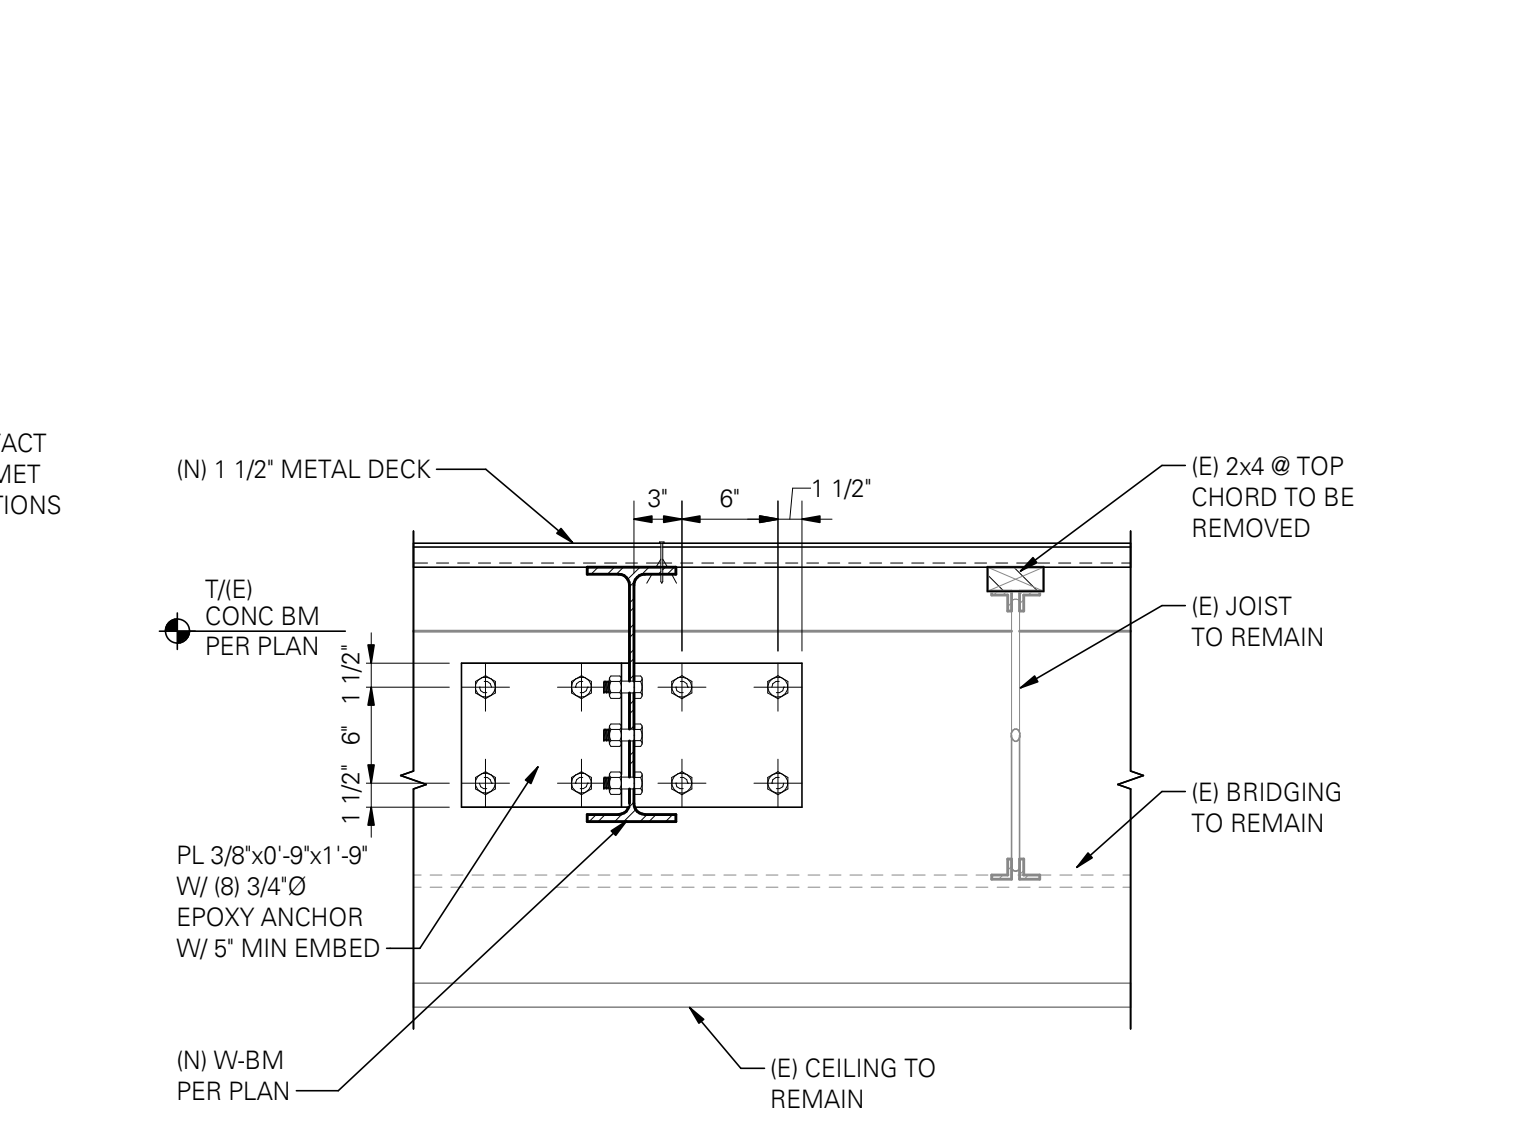


4 (N) W-BEAM AT (E) W-BEAM
 SCALE: 1" = 1'-0"

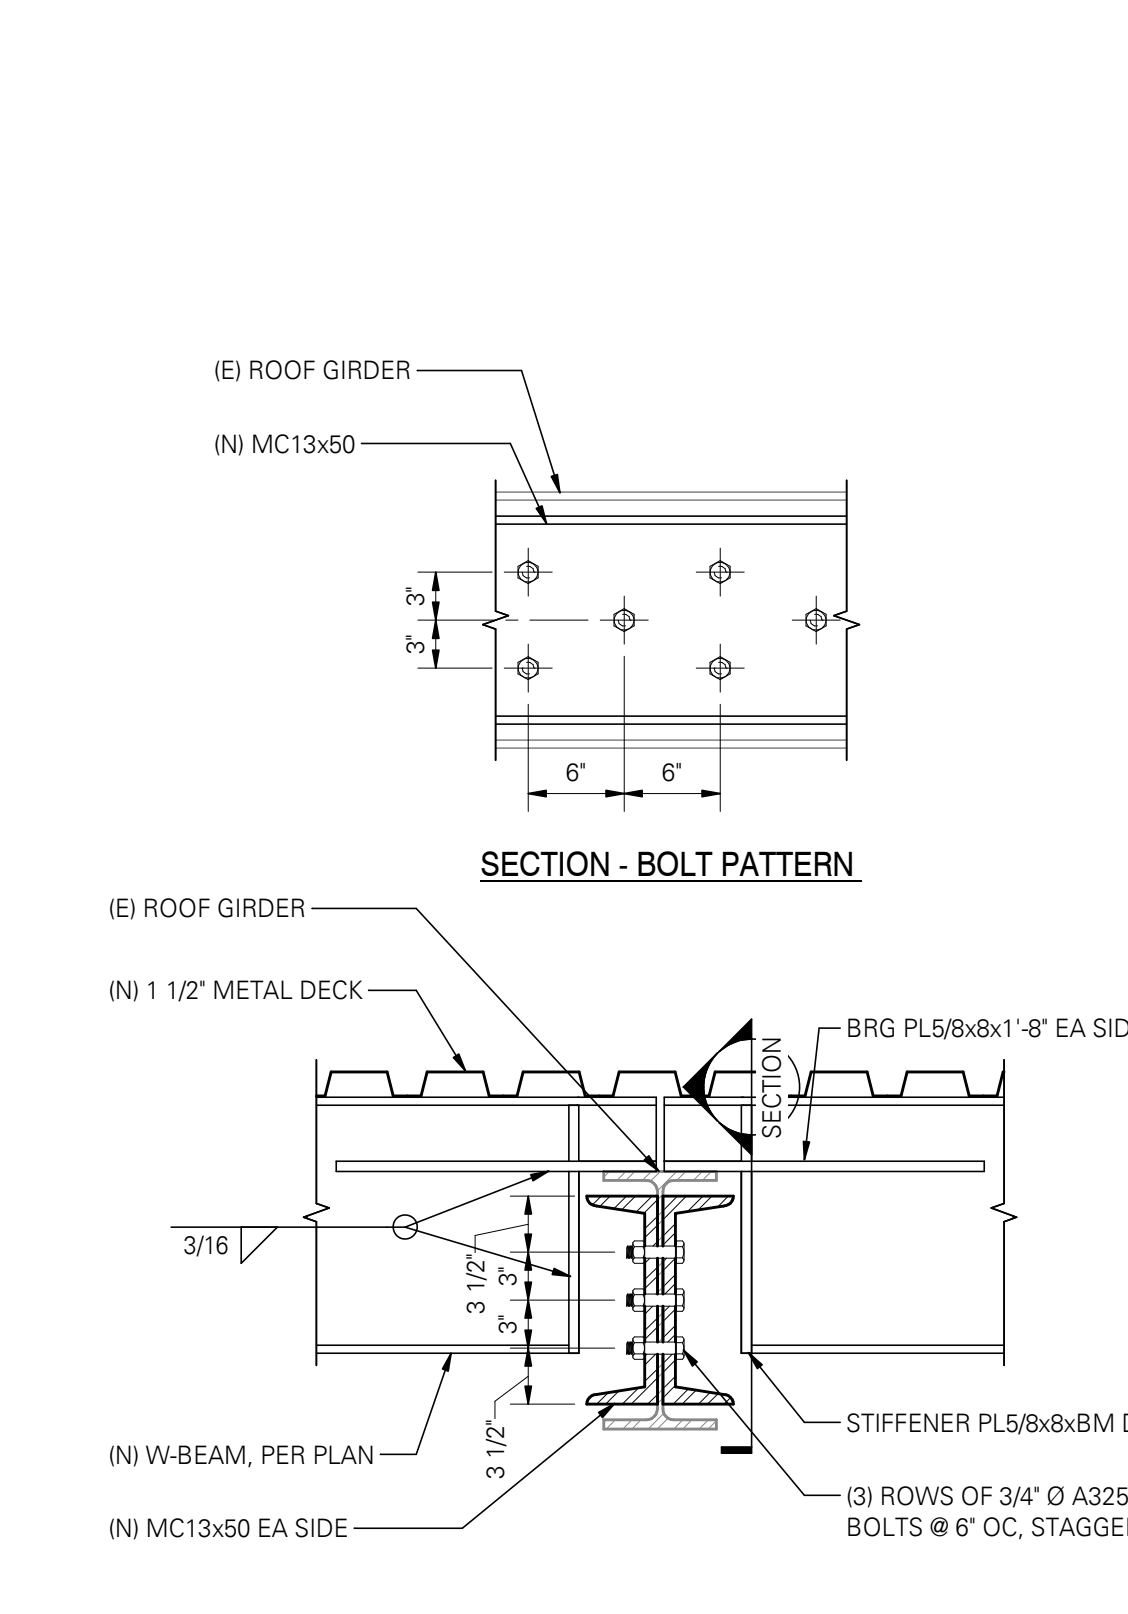


5 (E) GIRDER RETRO-FIT
 SCALE: 1" = 1'-0"

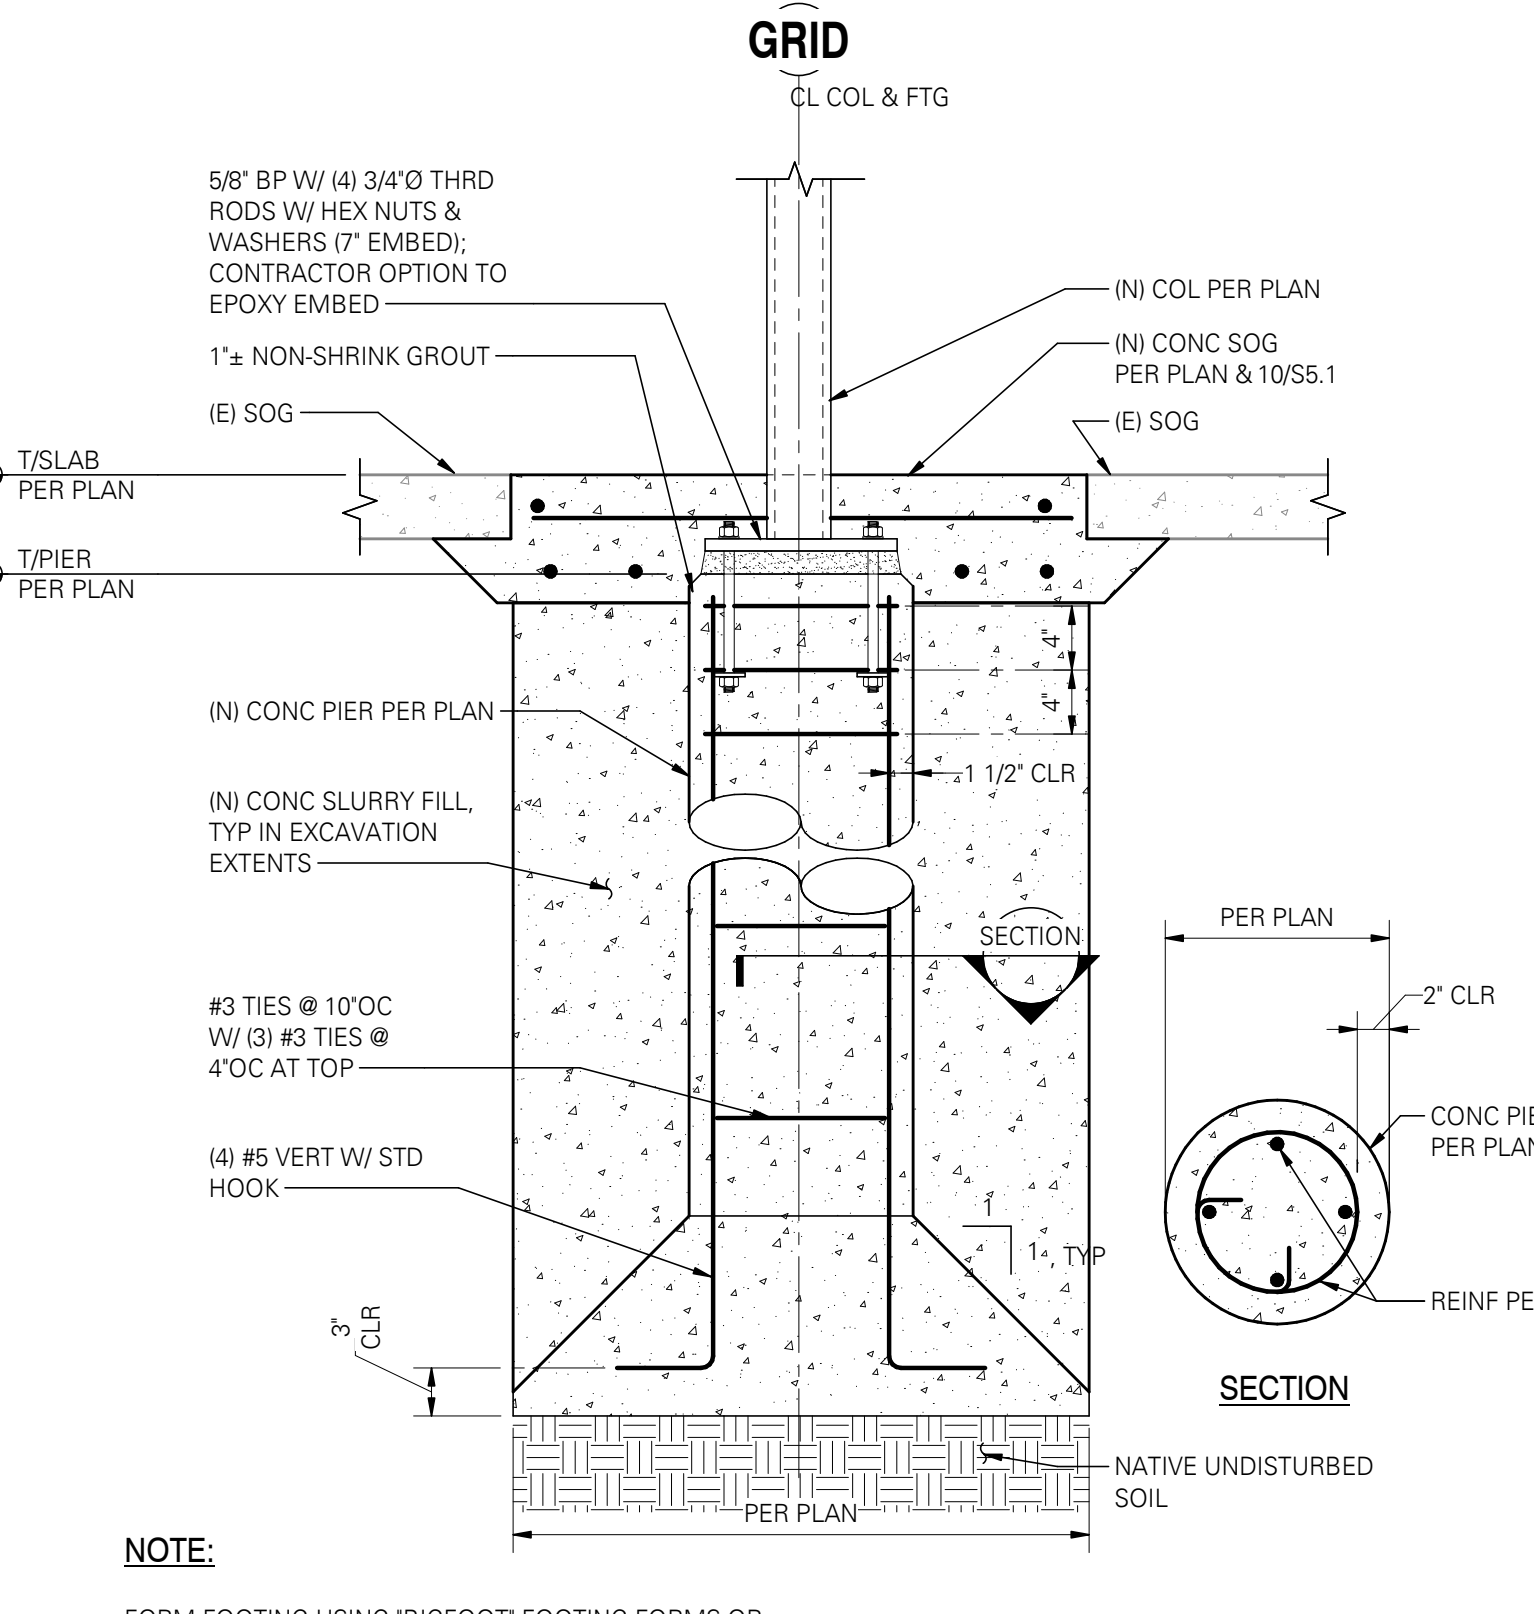


6 NEW CONCRETE PIER AT NEW COLUMNS
 SCALE: 1" = 1'-0"

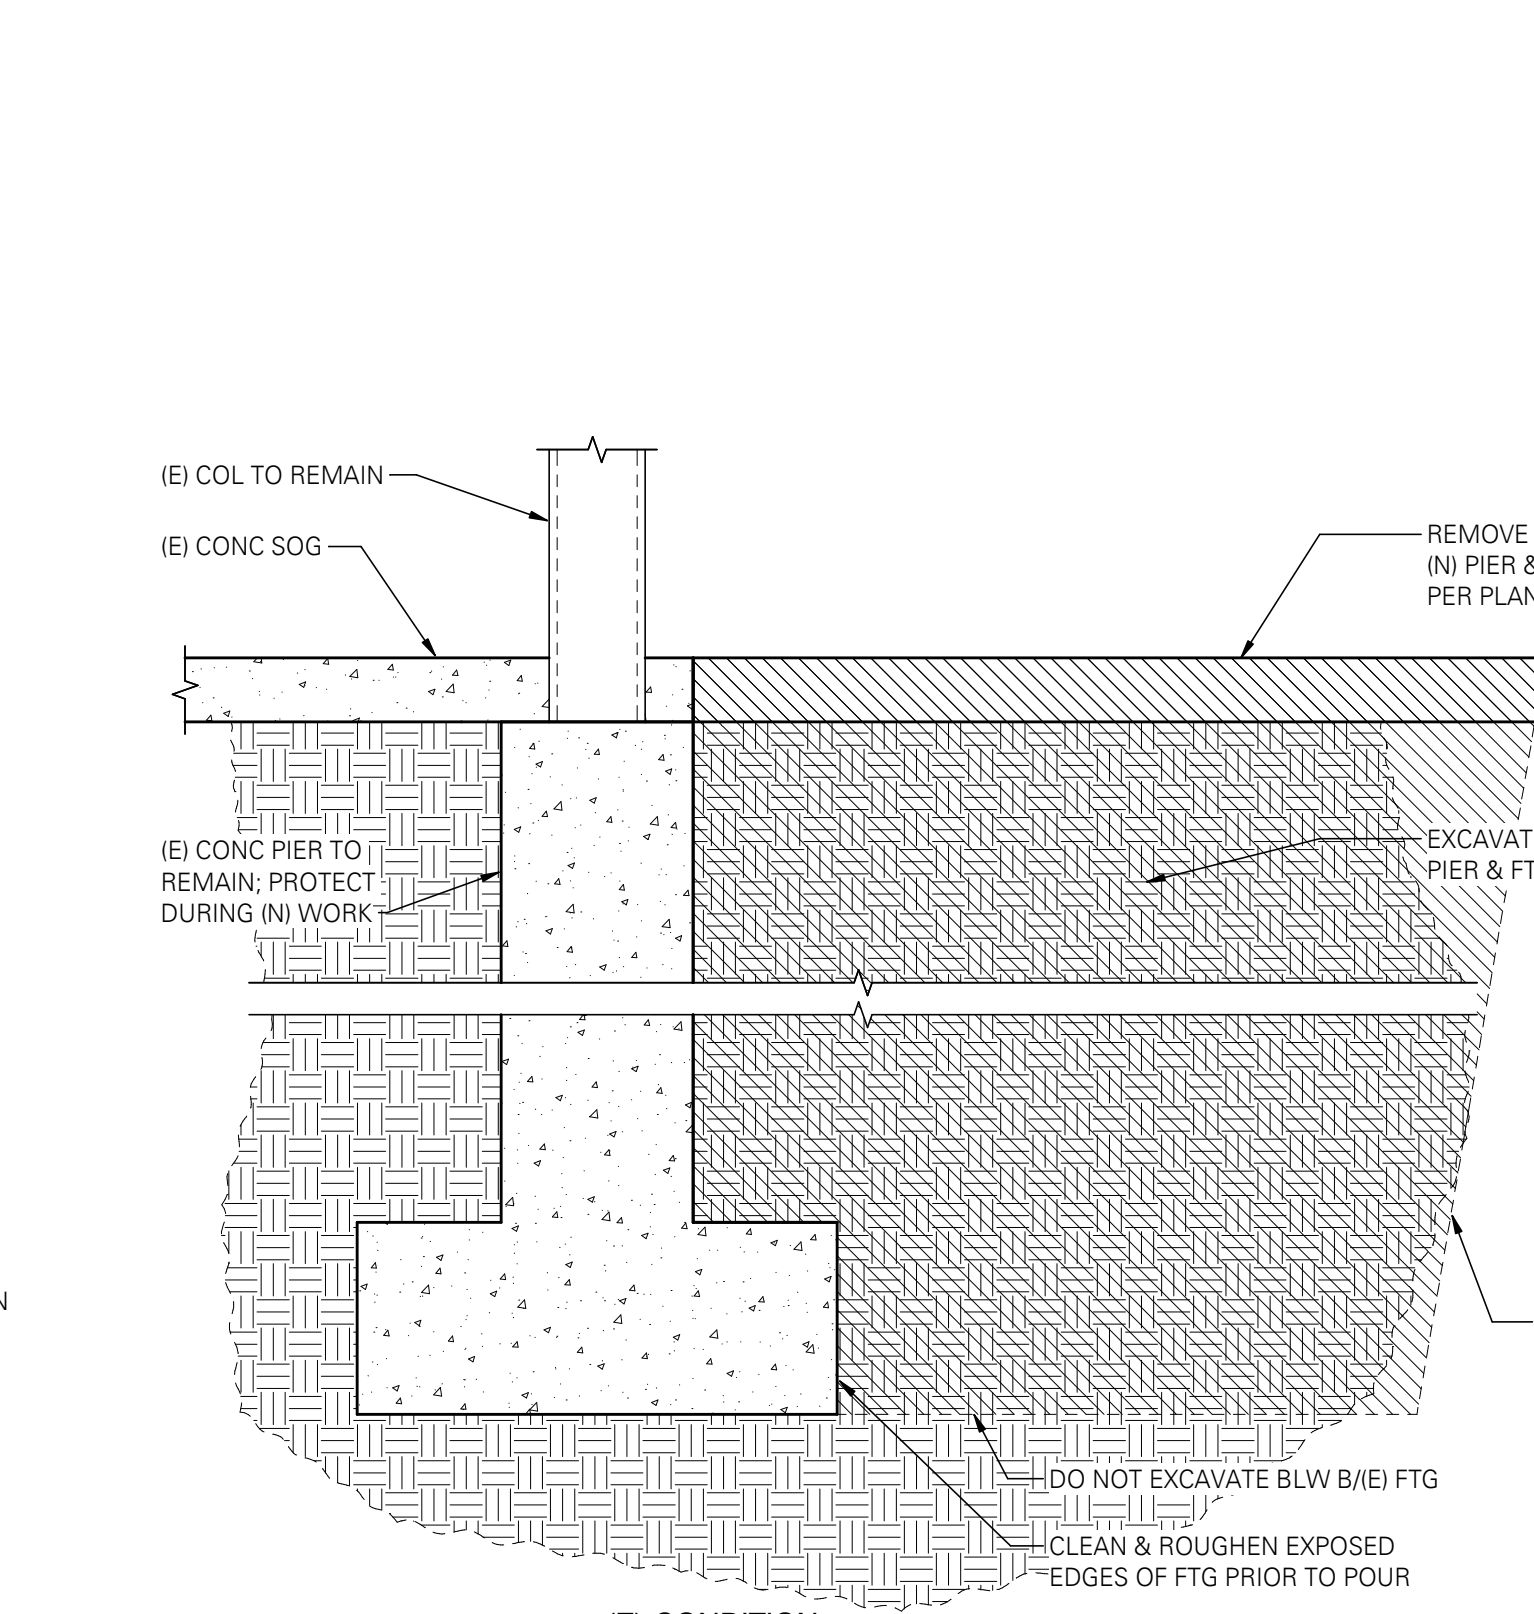


7 (N) CONC PIER AT (E) FTG
 SCALE: 1" = 1'-0"

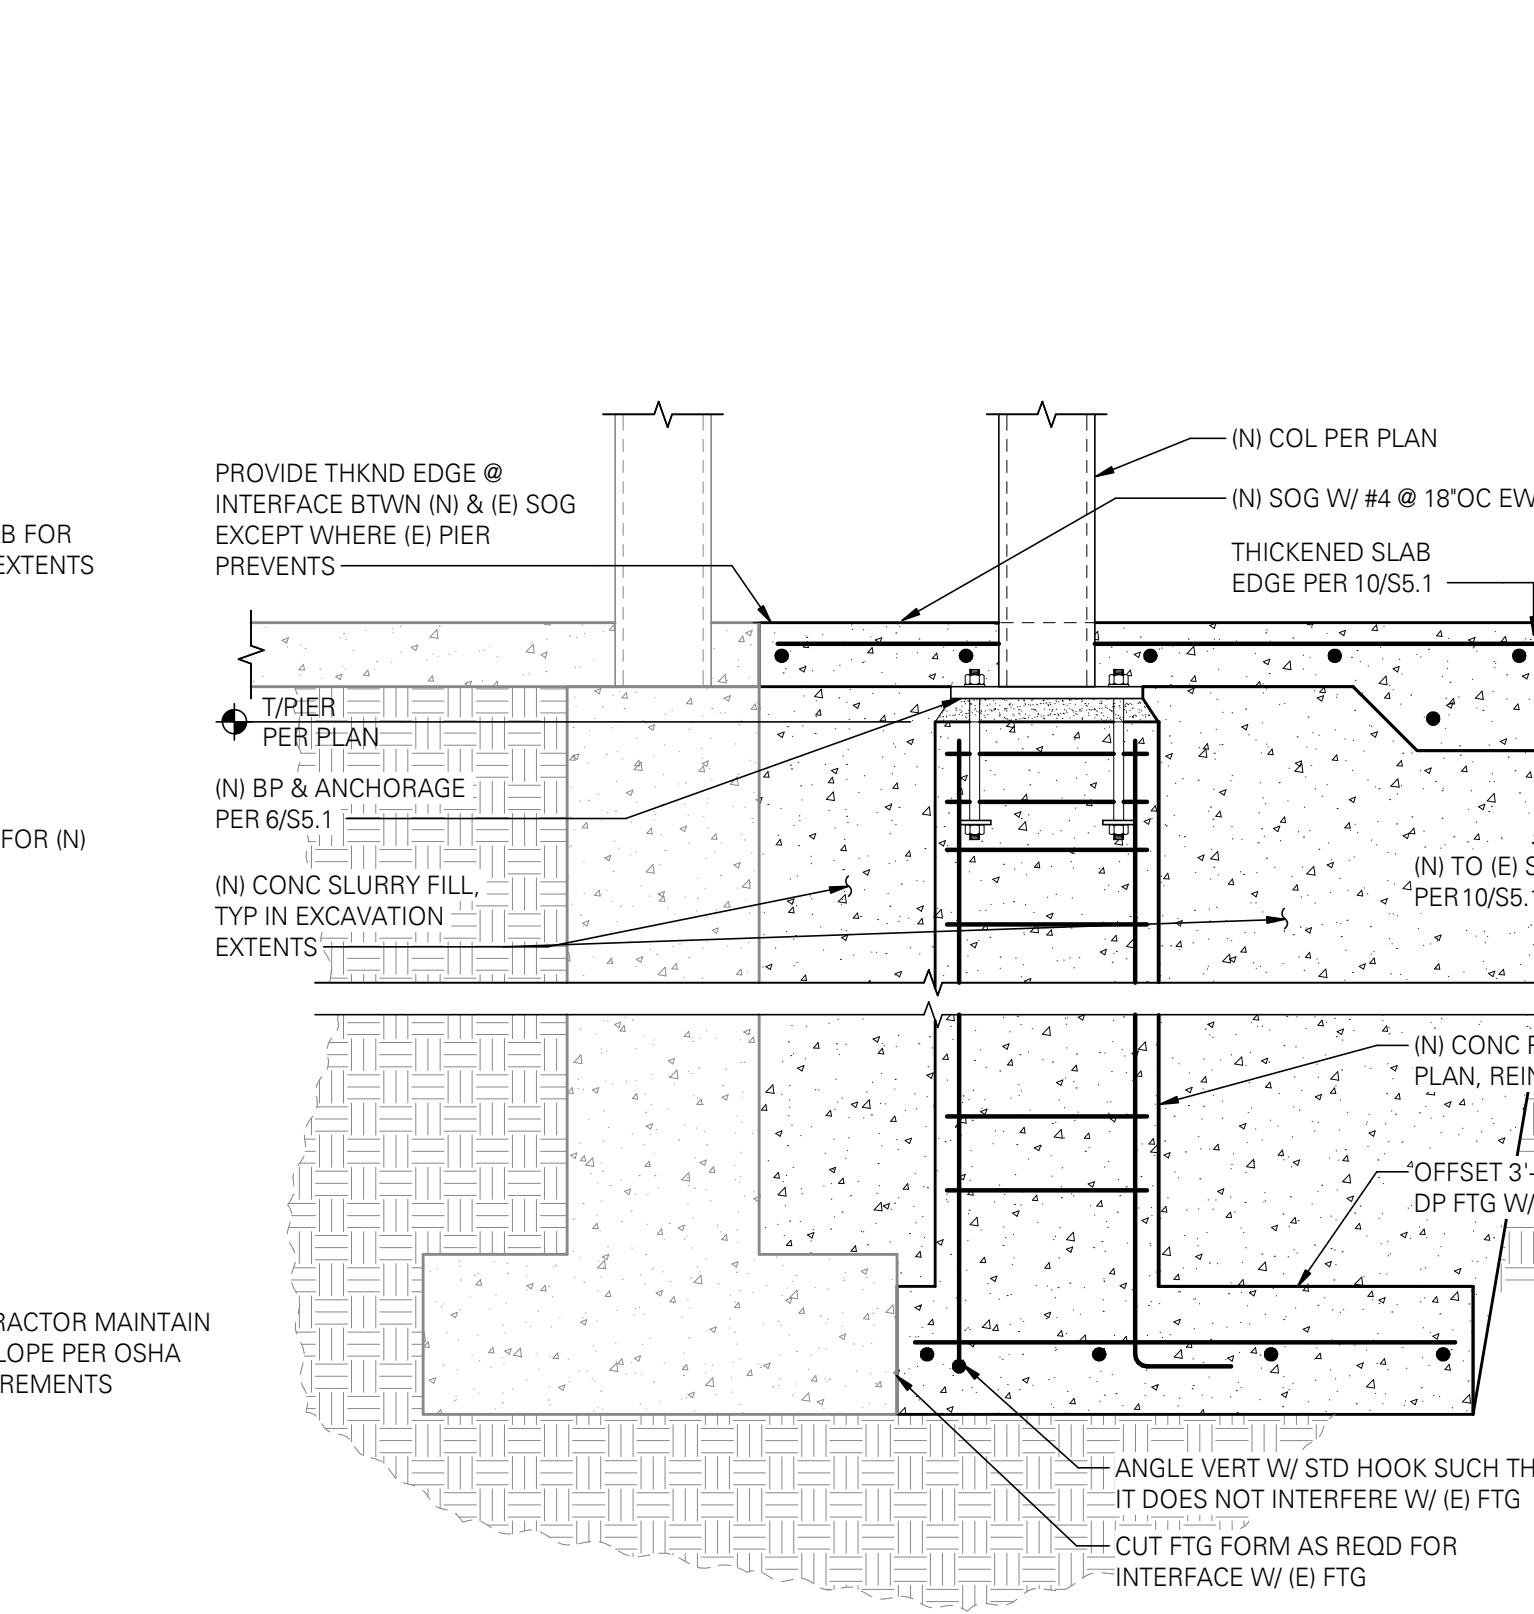


8 (N) CONC PIER AT (E) FTG
 SCALE: 1" = 1'-0"

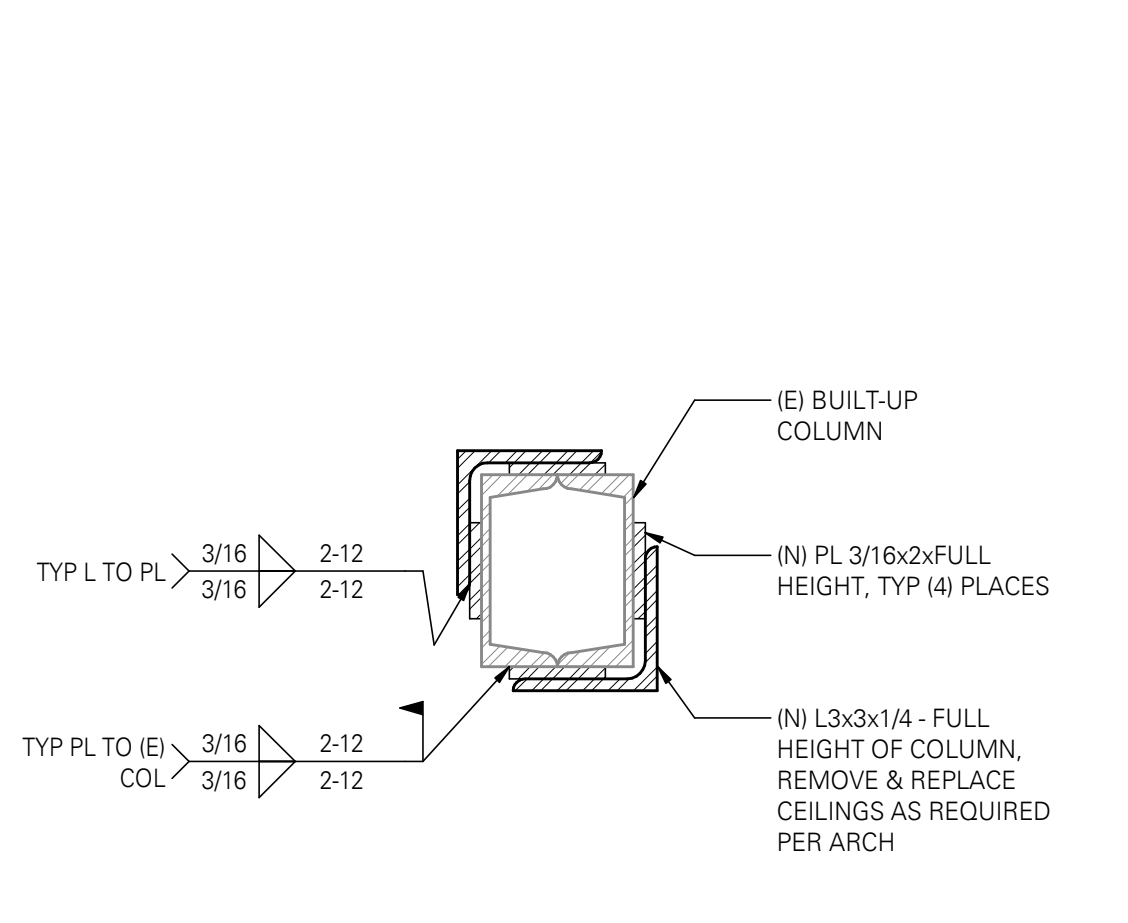


9 STEEL COLUMN RETROFIT
 NTS

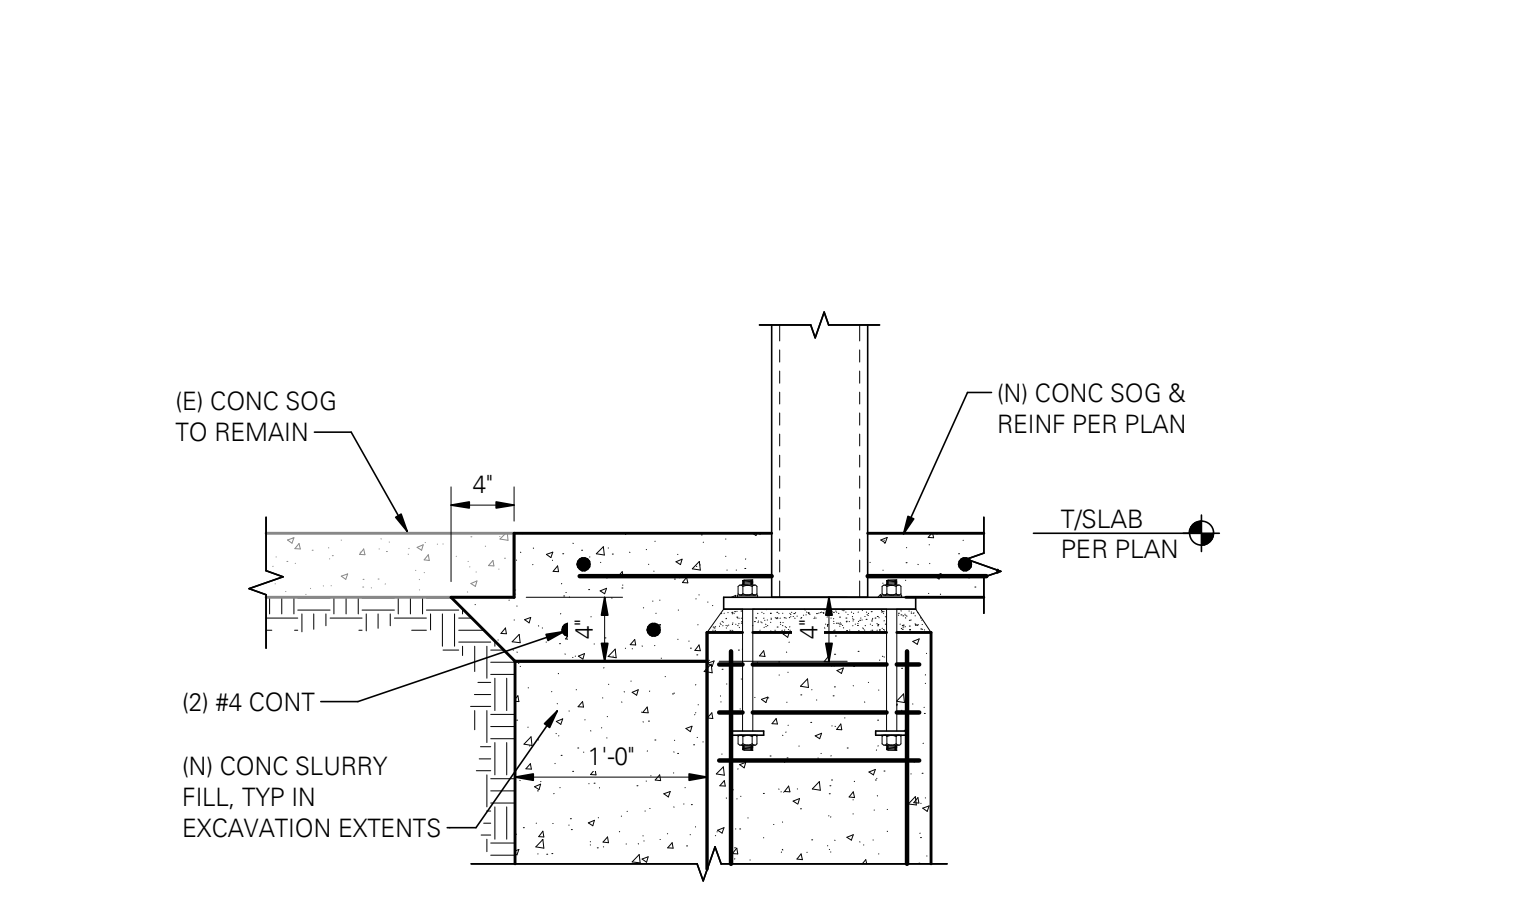


10 NEW TO EXISTING CONCRETE SLAB ON GRADE
 SCALE: 1" = 1'-0"

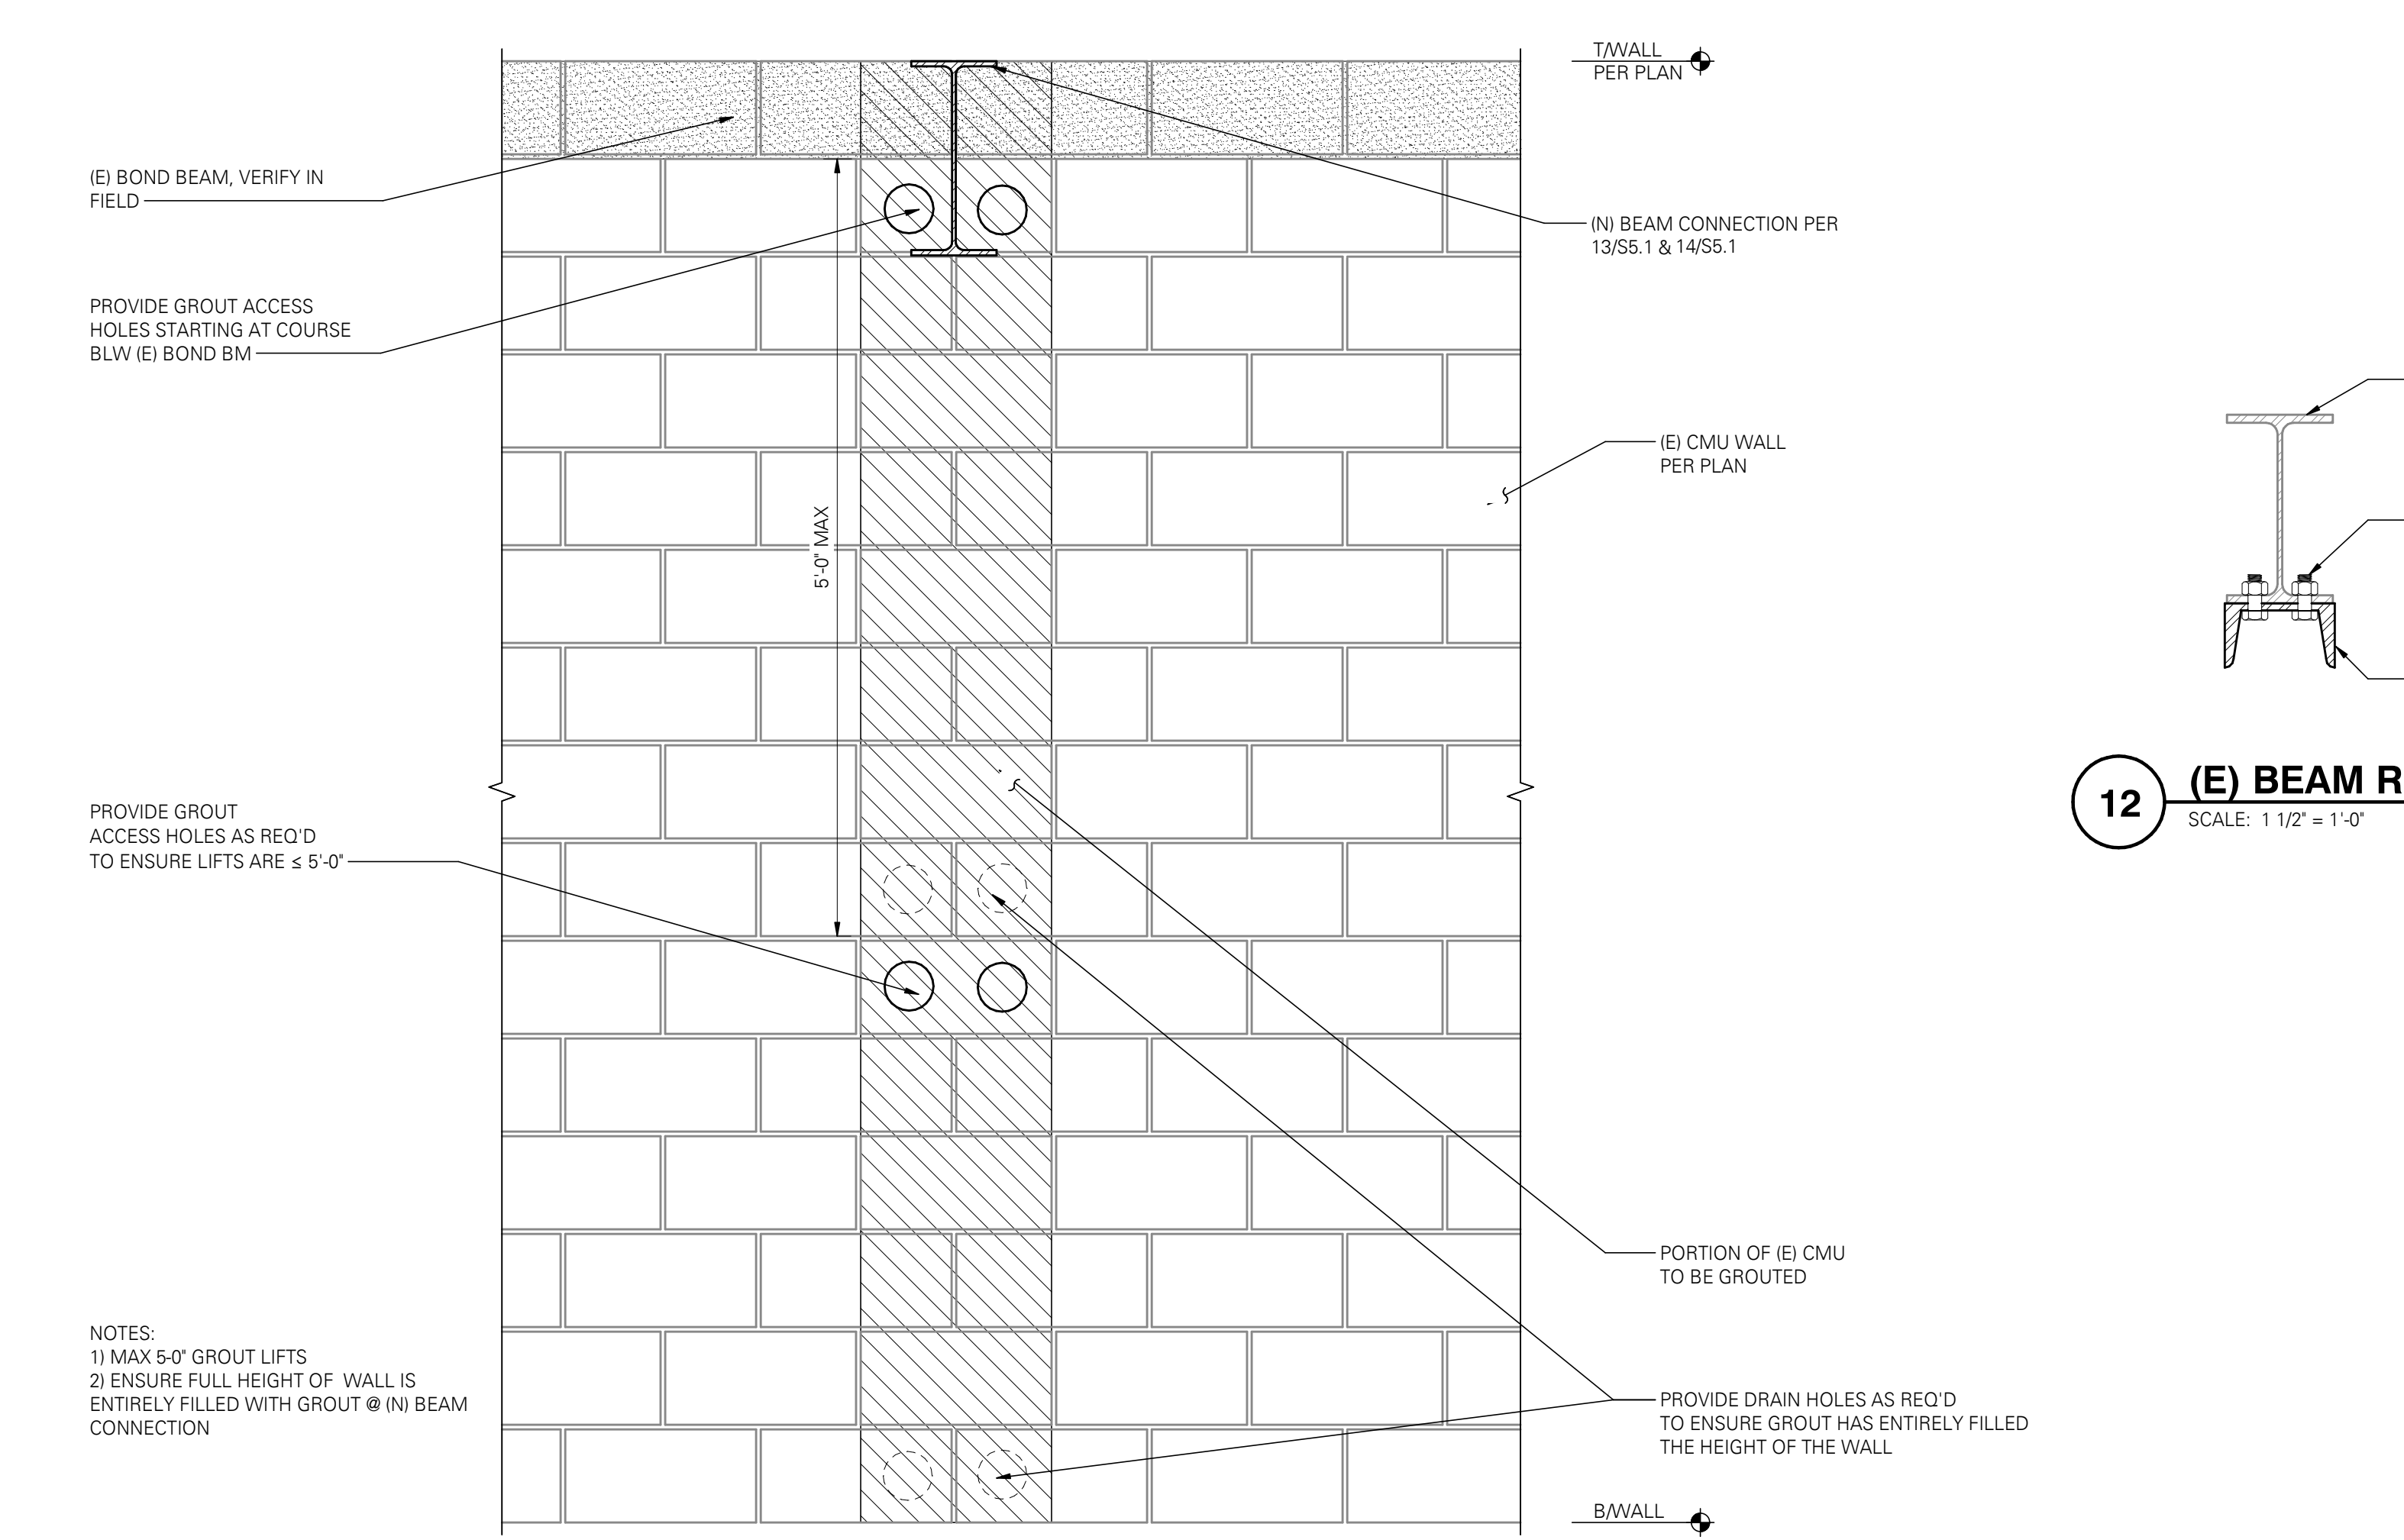


11 (N) GROUT IN (E) MASONRY WALL @ (N) BEAM CONNECTION
 SCALE: 1" = 1'-0"

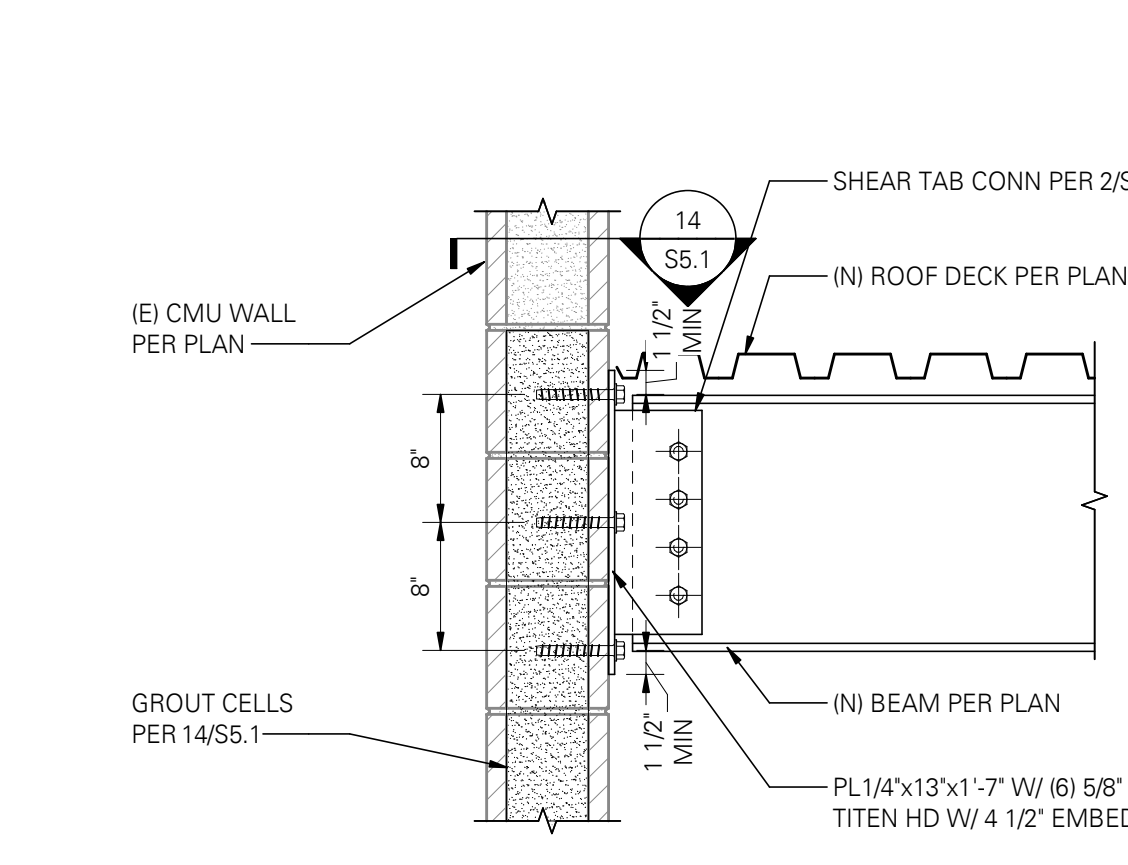

12 SECTION - (N) W-BEAM TO (E) CMU WALL
 SCALE: 1" = 1'-0"

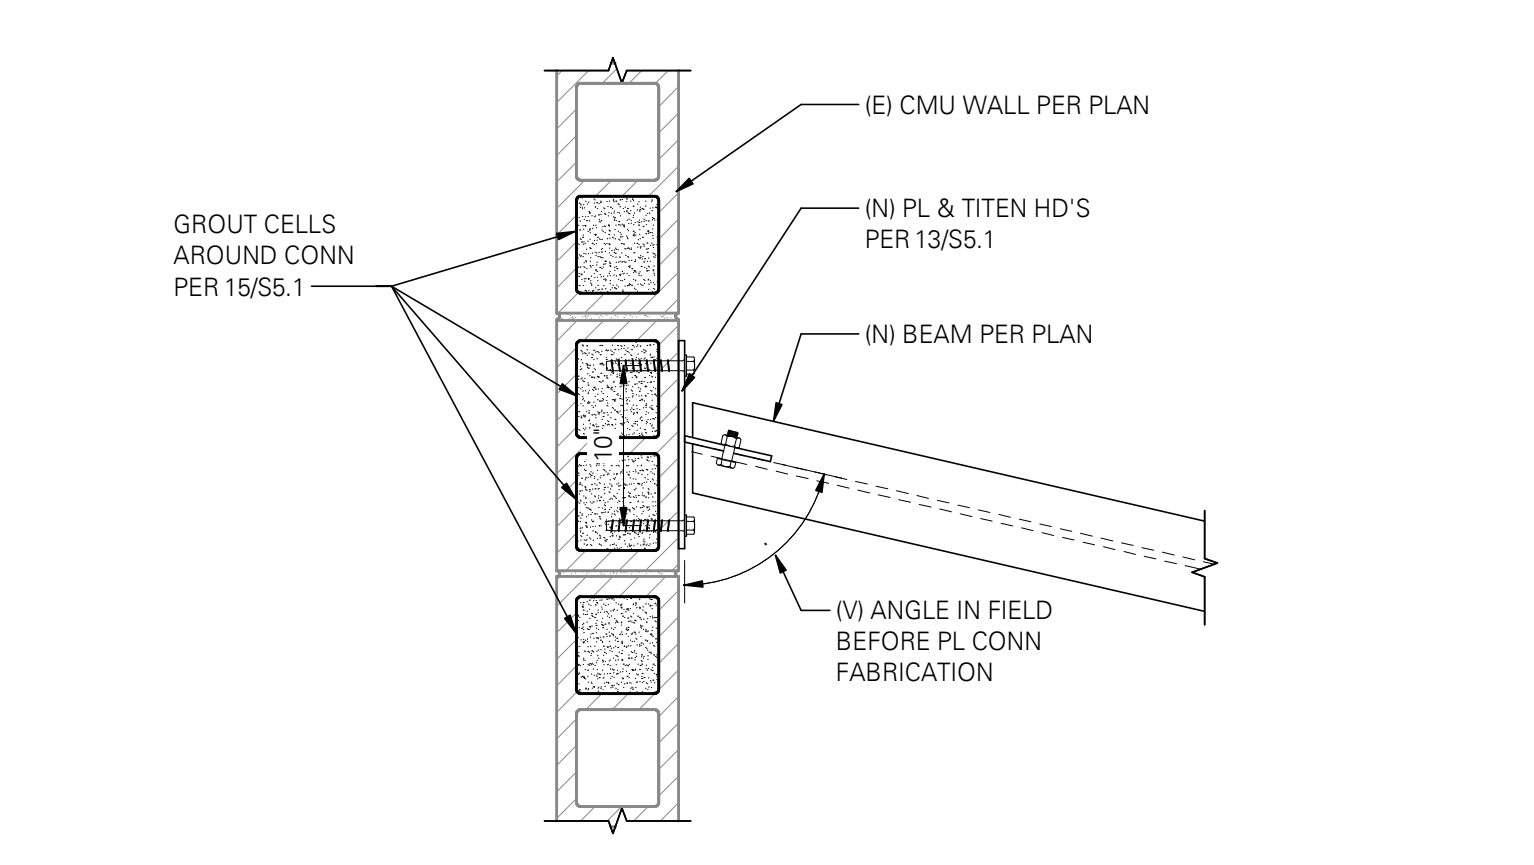

13 PLAN - (N) W-BEAM TO (E) CMU WALL
 SCALE: 1" = 1'-0"

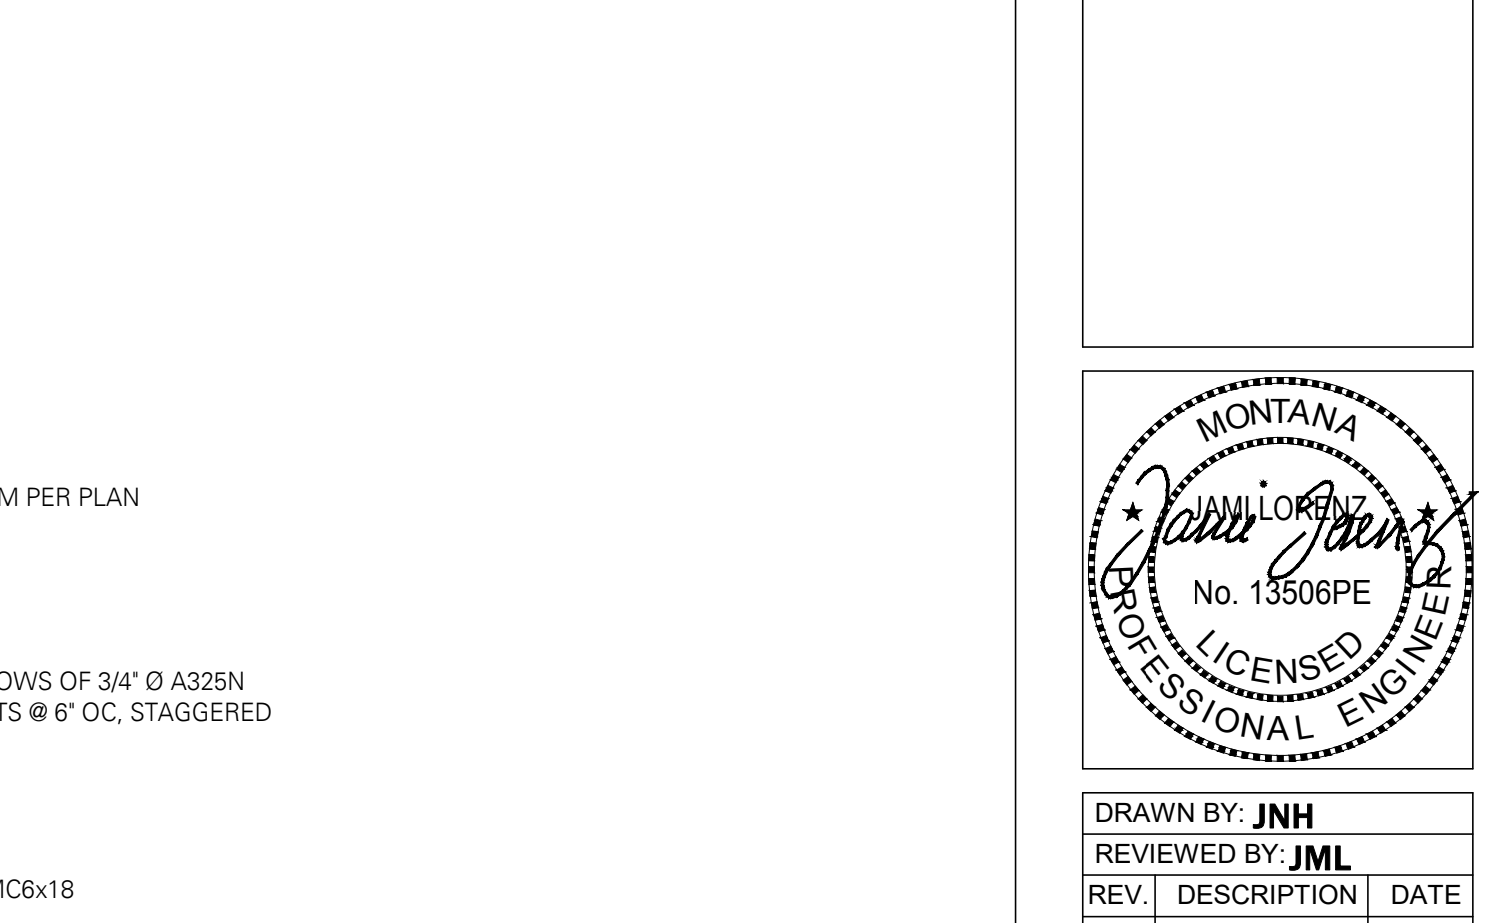


14 (E) BEAM RETROFIT
 SCALE: 1 1/2" = 1'-0"

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TEMPORARY SHORING SEQUENCING:

1. INSTALL (N) 6x6 SHORING POST & KING STUDS
2. INSTALL TEMP. TOP CHORD BRACING
3. REMOVE TOP CHORD TO INSTALL NEW CHANNEL RETROFIT. SEE PLAN FOR EXTENTS
4. INSTALL BEAM RETROFIT PER S5.1
5. INSTALL (N) BEAMS EACH SIDE OF (E) JOIST PER PLAN
6. INSTALL (N) L6x4 SUPPORT ANGLE AT (E) JOIST
7. REMOVE 2x4 @ TOP CHORD FOR METAL DECK CLEARANCE, TYP @ (N) METAL DECK
8. INSTALL (N) METAL DECK
9. REMOVE SHORING POST AND REPAIR/PATCH CEILINGS PER ARCH



4 TEMPORARY SHORING OF (E) JOISTS @ (E) BEAM RETROFIT - 2 LOCATIONS
SCALE: 1" = 1'-0"

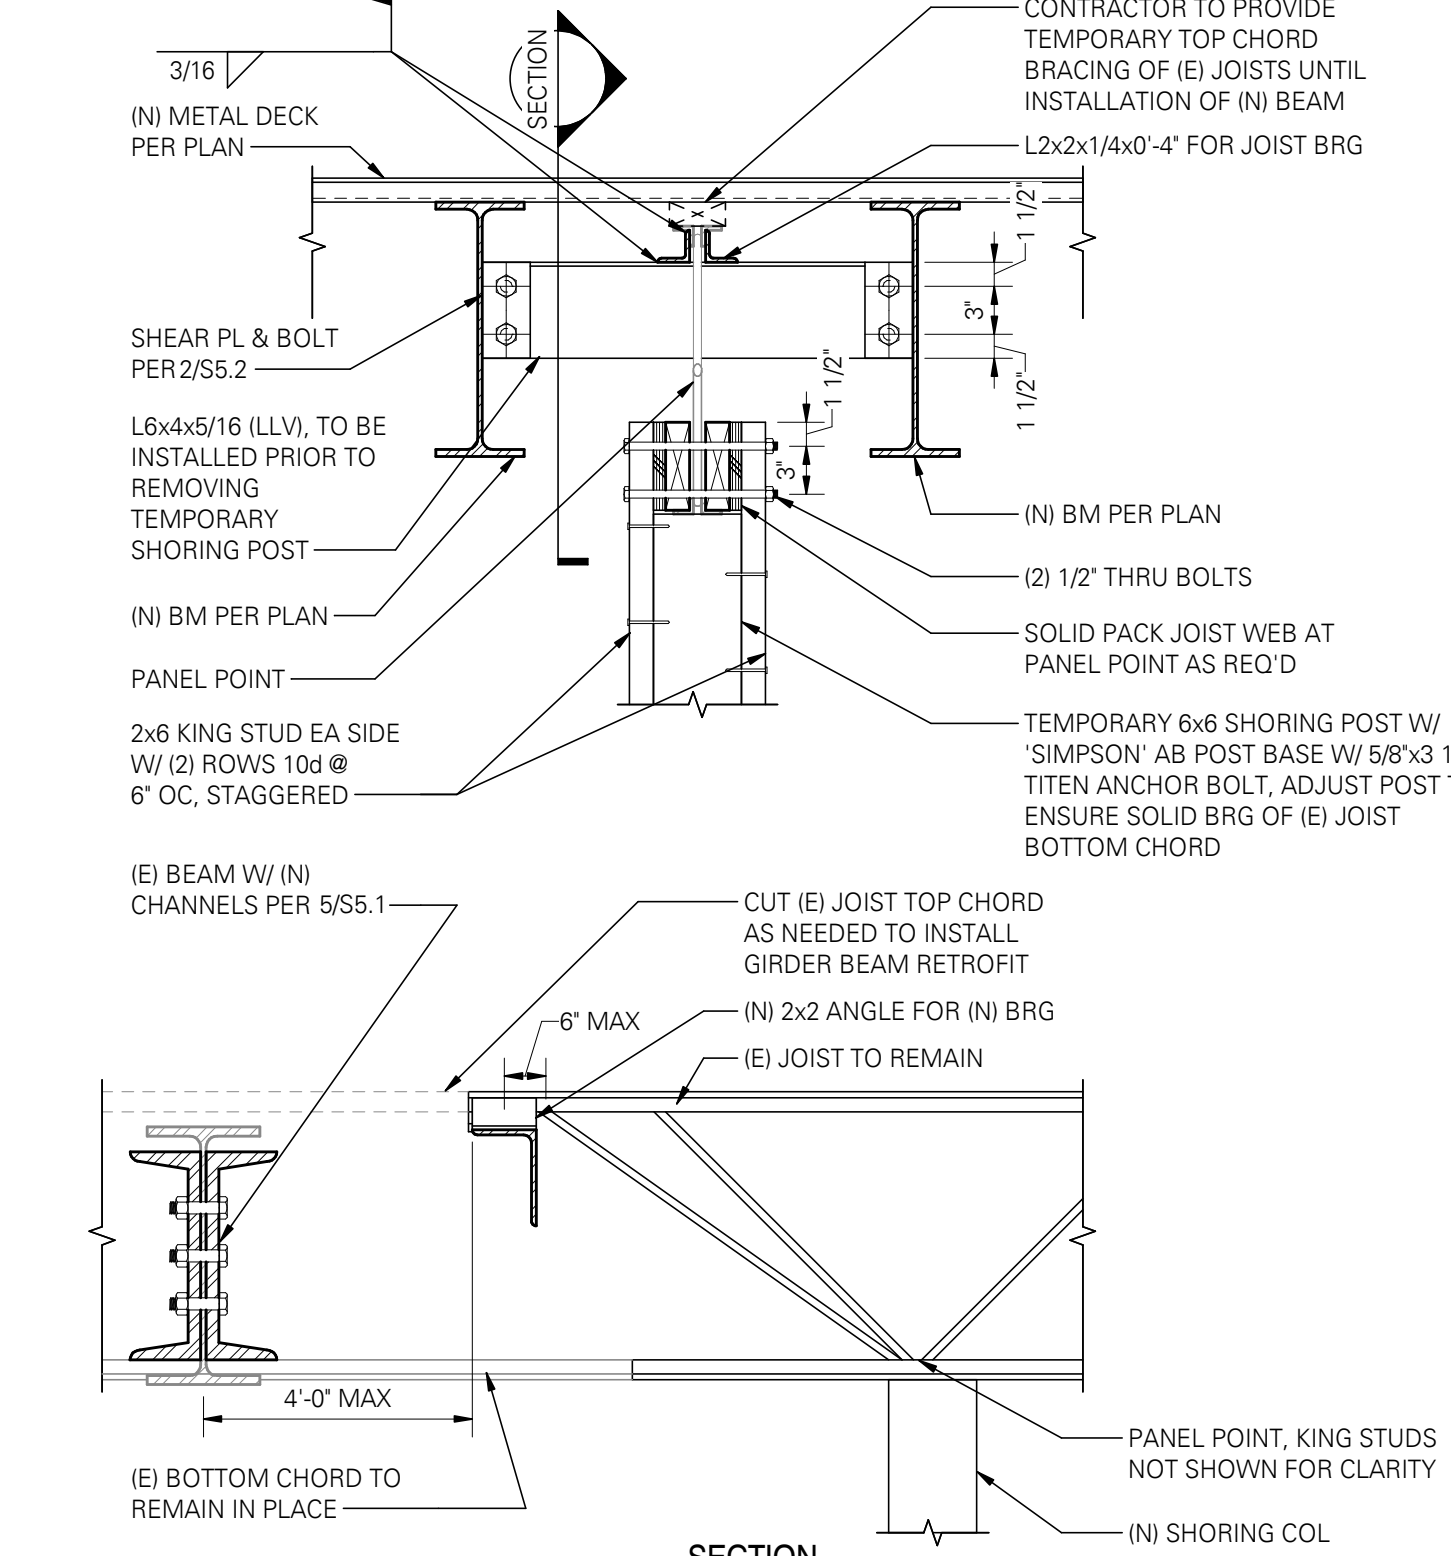BOLTED SINGLE SHEAR PLATE CONNECTION - SCHEDULE 'A'

BEAM SIZE	"N" BOLTS REQUIRED (1)	MIN SHEAR PLATE OR WT STEM THICKNESS	MIN HSS COLUMN WALL THICKNESS(10)	WELD SIZE (7)	MAX SINGLE COPE DEPTH (8)	MAX DOUBLE COPE DEPTH (8)	CONNECTION CAPACITY - ASD (3) (KIPS)			
							UNCOPED		COPED	
							SINGLE	DOUBLE	SINGLE	DOUBLE
W10	2	3/8"	1/4"	3/16"	2 1/2"	1 1/4"	13.2	11.0	11.0	
W12	3	3/8"	1/4"	3/16"	2"	1 1/4"	26.6	18.3	18.3	
W14	3	3/8"	1/4"	1/4"	2 1/2"	1 1/2"	27.8	EQUAL TO UNCOPE	23.9	
W16	4	3/8"	1/4"	1/4"	2 1/2"	1 1/2"	42.4	EQUAL TO UNCOPE	36.6	

- BOLTED SINGLE ROW SHEAR PLATE CONNECTION NOTES:**
1. PROVIDE EITHER STANDARD OR HORIZONTAL SHORT SLOTTED HOLES AS PERMITTED BY AISC J3.2 IN THE BEAM WEB AND/OR THE SHEAR PLATE.
 2. WHERE SHORT-SLOTTED HOLES ARE USED, PROVIDE HARDENED WASHERS PER AISC J3.2.
 3. CAPACITIES BASED ON AISC 13TH EDITION WITH ASTM A325-N BOLTS.
 4. HORIZONTAL DISTANCE FROM SUPPORT FACE TO CENTERLINE OF BOLT GROUP SHALL BE AS SHOWN IN THE DETAILS, BUT SHALL NOT EXCEED 3 1/2" IN THE AS-BUILT CONDITION. SUPPORT FACE FOR TEE IS THE INSIDE FACE OF FLANGE.
 5. VERTICAL EDGE DISTANCE FROM BOLT CENTERLINE TO EDGE OF STEEL SHALL BE 1 1/2" TYPICALLY, EXCEPT THAT 1 1/4" IS PERMITTED PER AISC TABLE J3.4 FOR 3/4" DIAMETER BOLTS WITHOUT ANY REDUCTION IN THE TABULATED CAPACITIES.
 6. GAP BETWEEN BEAM END AND SUPPORT FACE SHALL BE 1/2" EXCEPT FOR "WT" CONNECTORS USED WITH HSS COLUMNS, WHERE "WT" ARE USED AS SHEAR TAB ELEMENTS. THE GAP BETWEEN FACE OF COLUMN AND END OF BEAM SHALL NOT EXCEED THE LESSER OF 1 1/2" OR THE "X" DISTANCE OF THE "WT" PLUS 1/4".
 7. WELD SIZES SHALL BE THE LARGER OF THE SIZE (1), TABULATED IN SCHEDULE 'A' OR MINIMUM SHOWN IN TABLE 1.
 8. FIELD FILLET WELDS SHALL BE SIZED TO BE AT LEAST 1/8" LARGER THAN THE WELD SIZE SHOWN IN SCHEDULE 'A', UNLESS PROPER FIT-UP IS VERIFIED BY A SPECIAL INSPECTOR PRIOR TO WELDING.
 9. COPE DEPTHS (SINGLE AND DOUBLE) SHALL NOT EXCEED THE LESSER OF THOSE SHOWN IN SCHEDULE 'A', NOR AS ALLOWED BY BOLT HOLE SPACING AND MINIMUM EDGE DISTANCE REQUIREMENTS. SINGLE COPE LENGTH SHALL NOT EXCEED 6 1/2". DOUBLE COPE LENGTHS SHALL NOT EXCEED THAT REQUIRED TO ACCOMMODATE GIRDER FLANGE + 1/2" MAX GAP BETWEEN FLANGES.
 10. UNCOPE CAPACITIES OF WT CONNECTIONS ARE VALID WITH MINIMUM NOMINAL HSS COLUMN WALL THICKNESS. THE EFFECTIVE THROAT OF FLARE BEVEL GROOVE WELDS IS BASED ON OUTSIDE RADIUS OF HSS, AND IS TAKEN AS 5/8 TIMES THE HSS WALL THICKNESS BASED ON AWS D1.1, TABLE 2.1. WHEN 3/4" A325-N BOLTS ARE USED, A 3/16" HSS COLUMN WALL THICKNESS IS PERMITTED WITH A 20% REDUCTION OF THE WT CONNECTION CAPACITY.



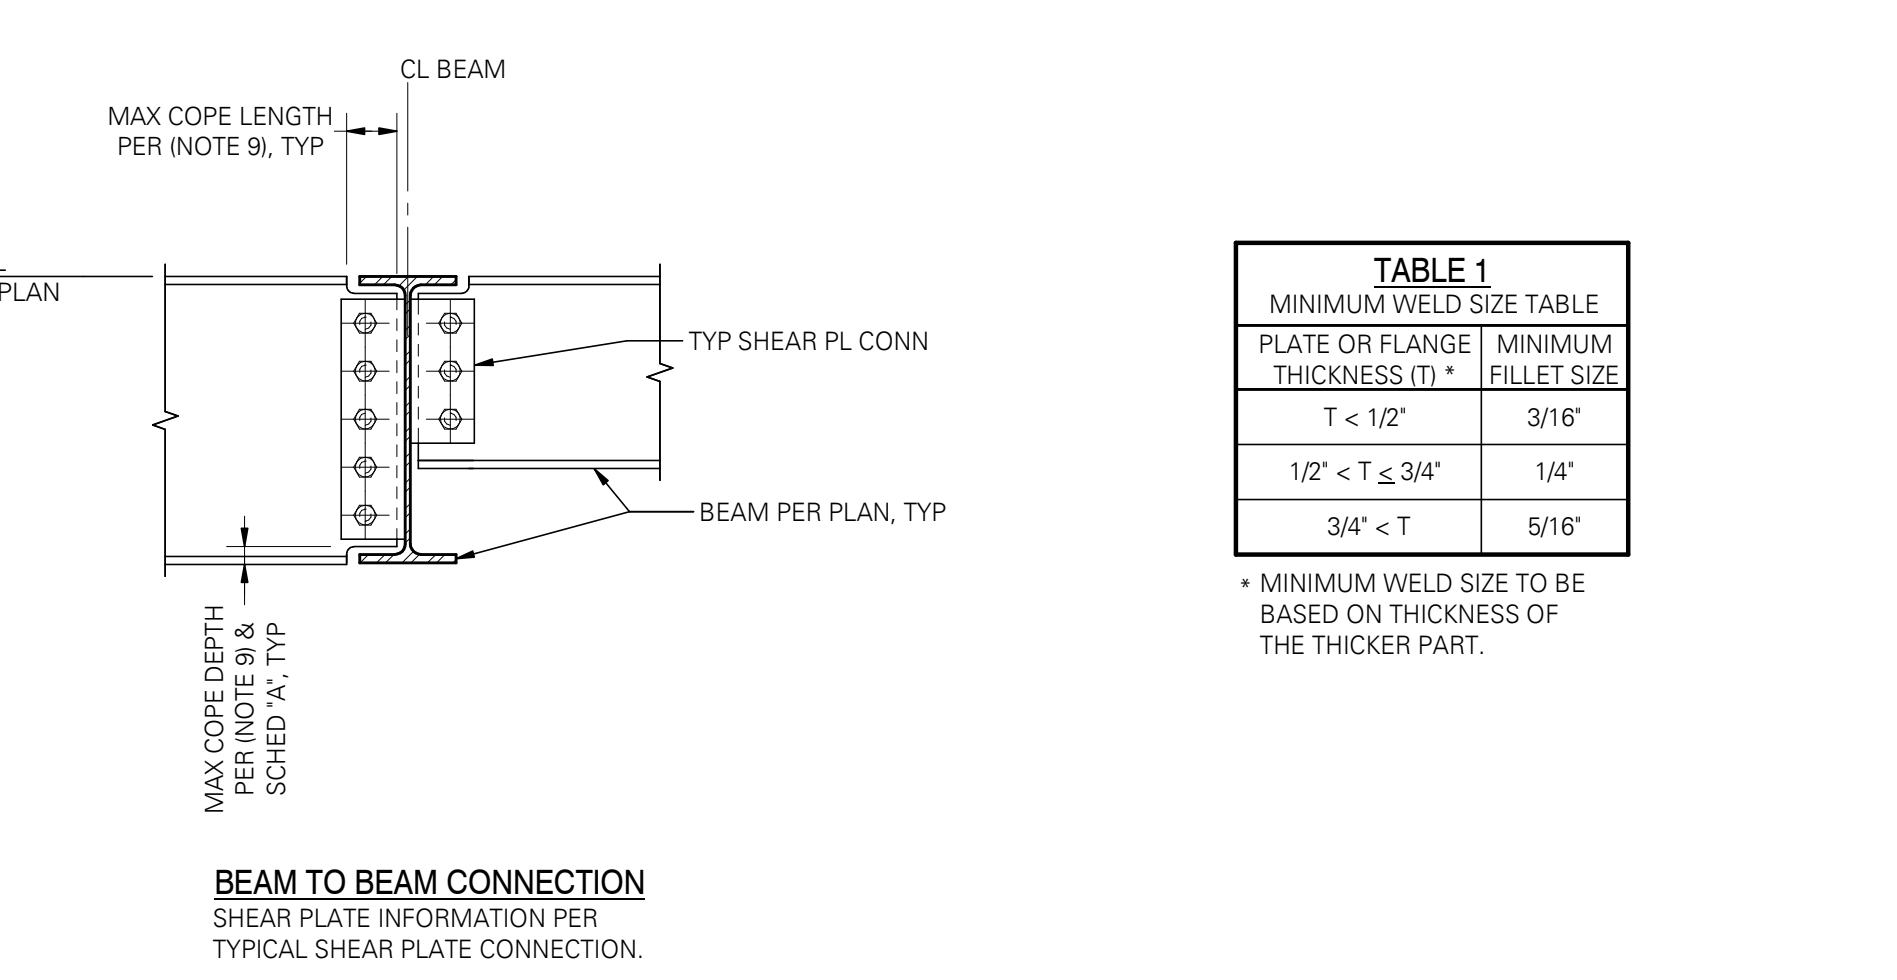


TABLE 1
MINIMUM WELD SIZE TABLE


PLATE OR FLANGE THICKNESS (T) *	MINIMUM FILLET SIZE
T < 1/2"	3/16"
1/2" <= T <= 3/4"	1/4"
3/4" < T	5/16"

* MINIMUM WELD SIZE TO BE BASED ON THICKNESS OF THE THICKER PART.

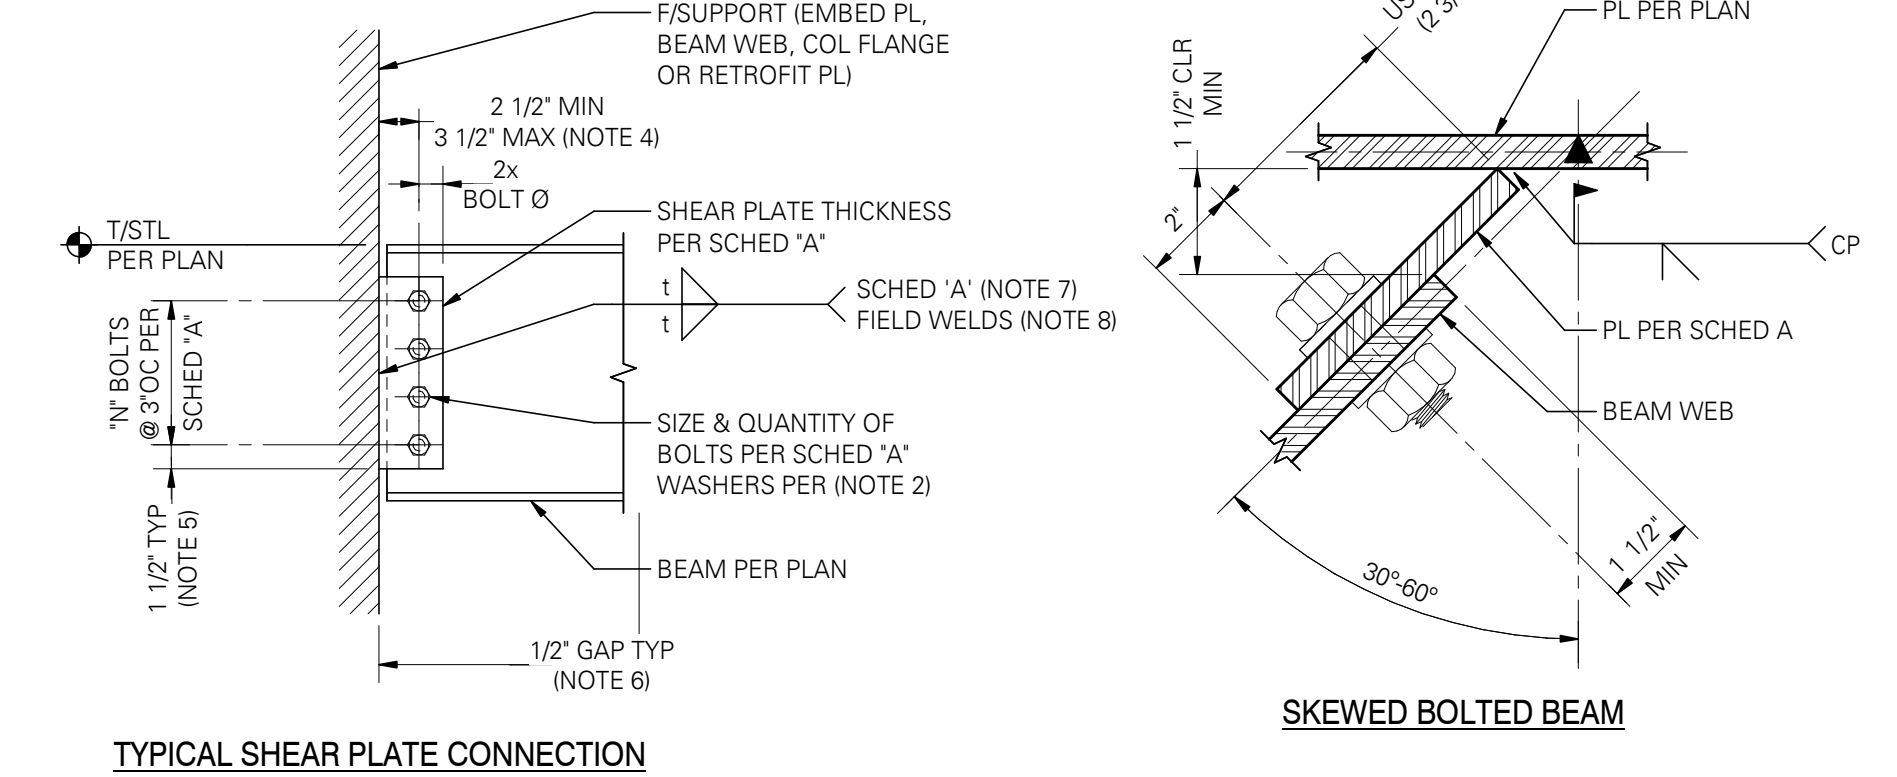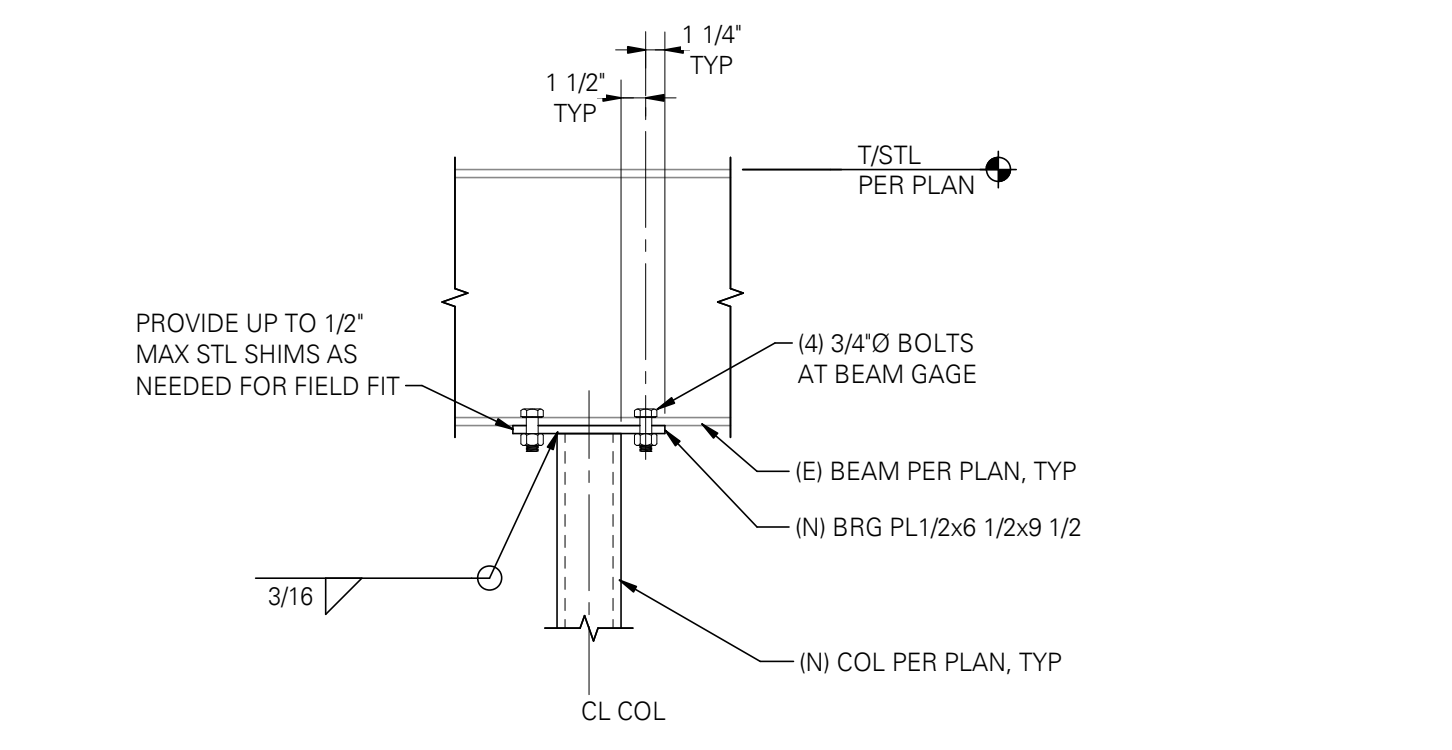


1 (E) BEAM TO (N) HSS COLUMN CONNECTION
SCALE: 1" = 1'-0" (05/05/14)

2 SINGLE SHEAR PLATE (SINGLE ROW) CONNECTIONS
SCALE: 1" = 1'-0" (05/20/14)

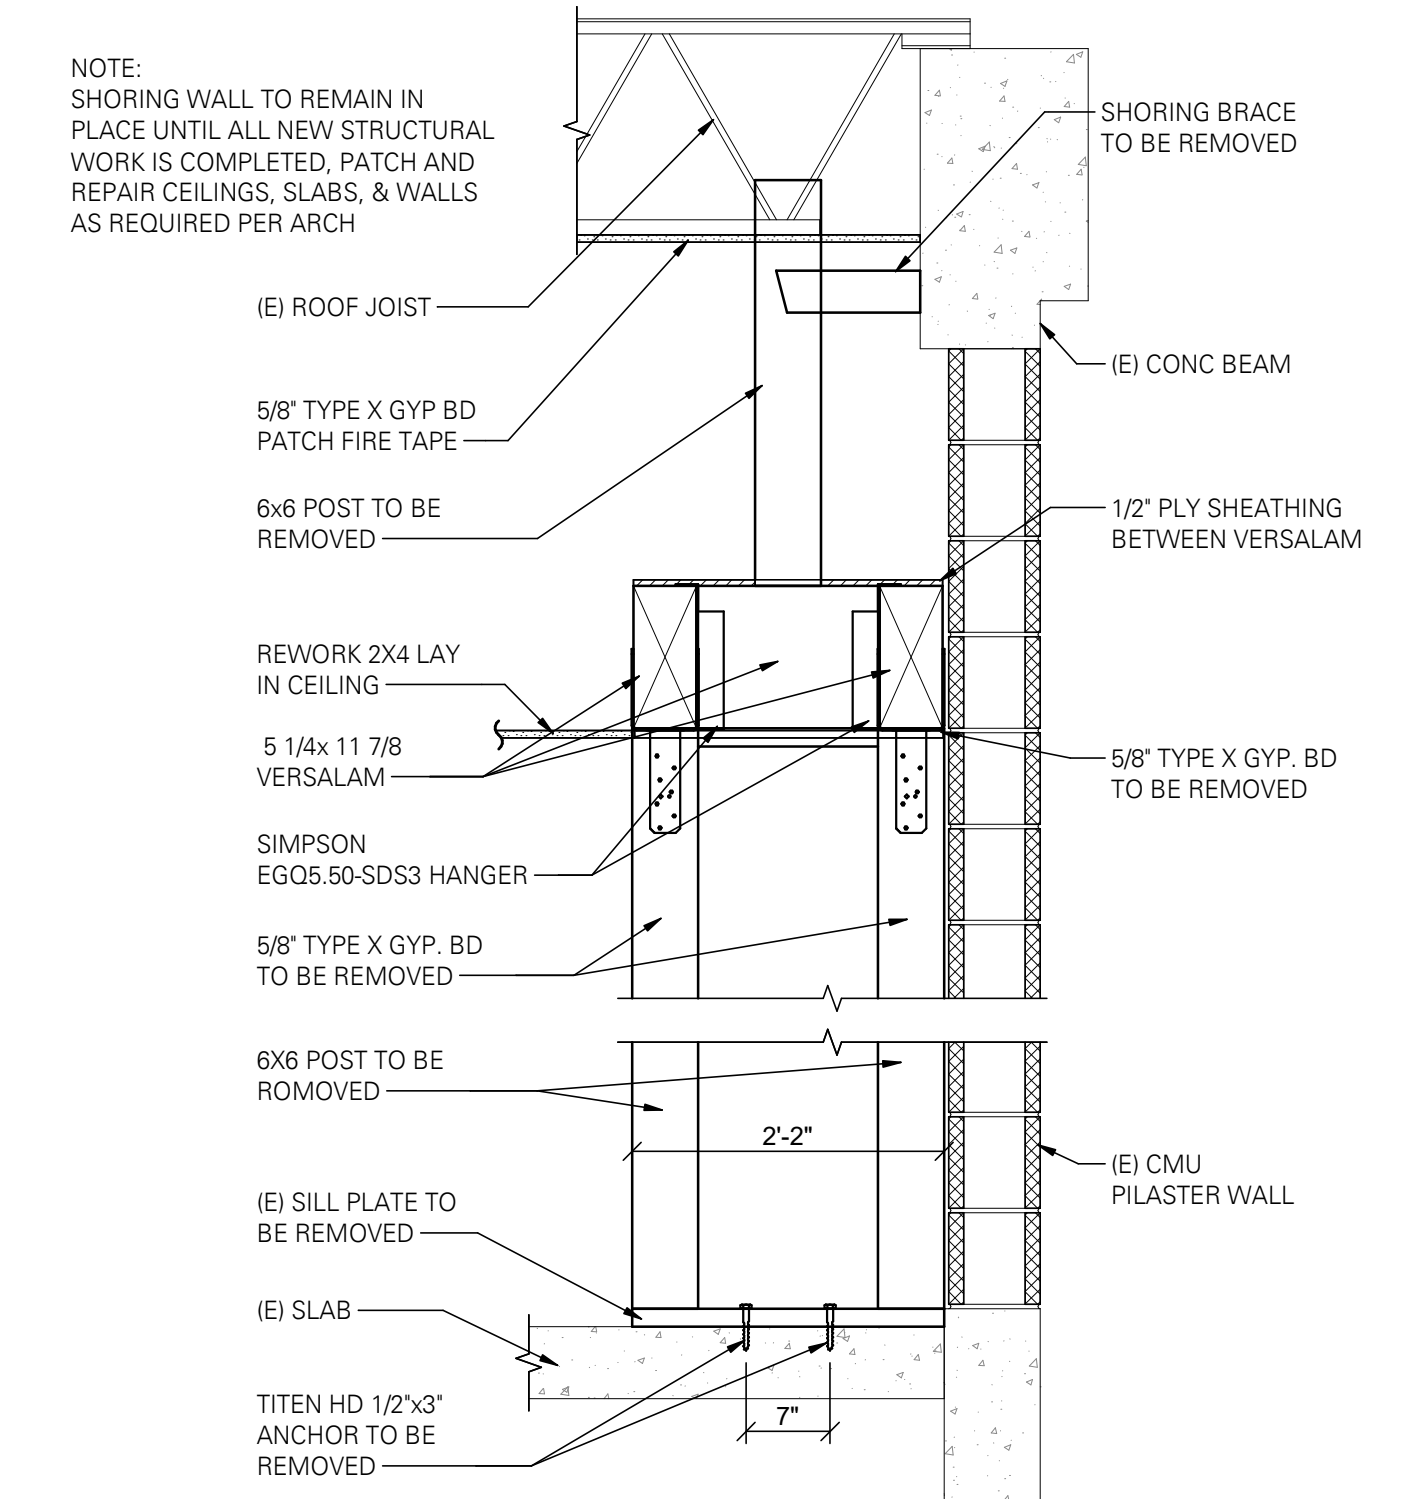

5 (E) SHORING WALL TO BE REMOVED
SCALE: 3/4" = 1'-0"

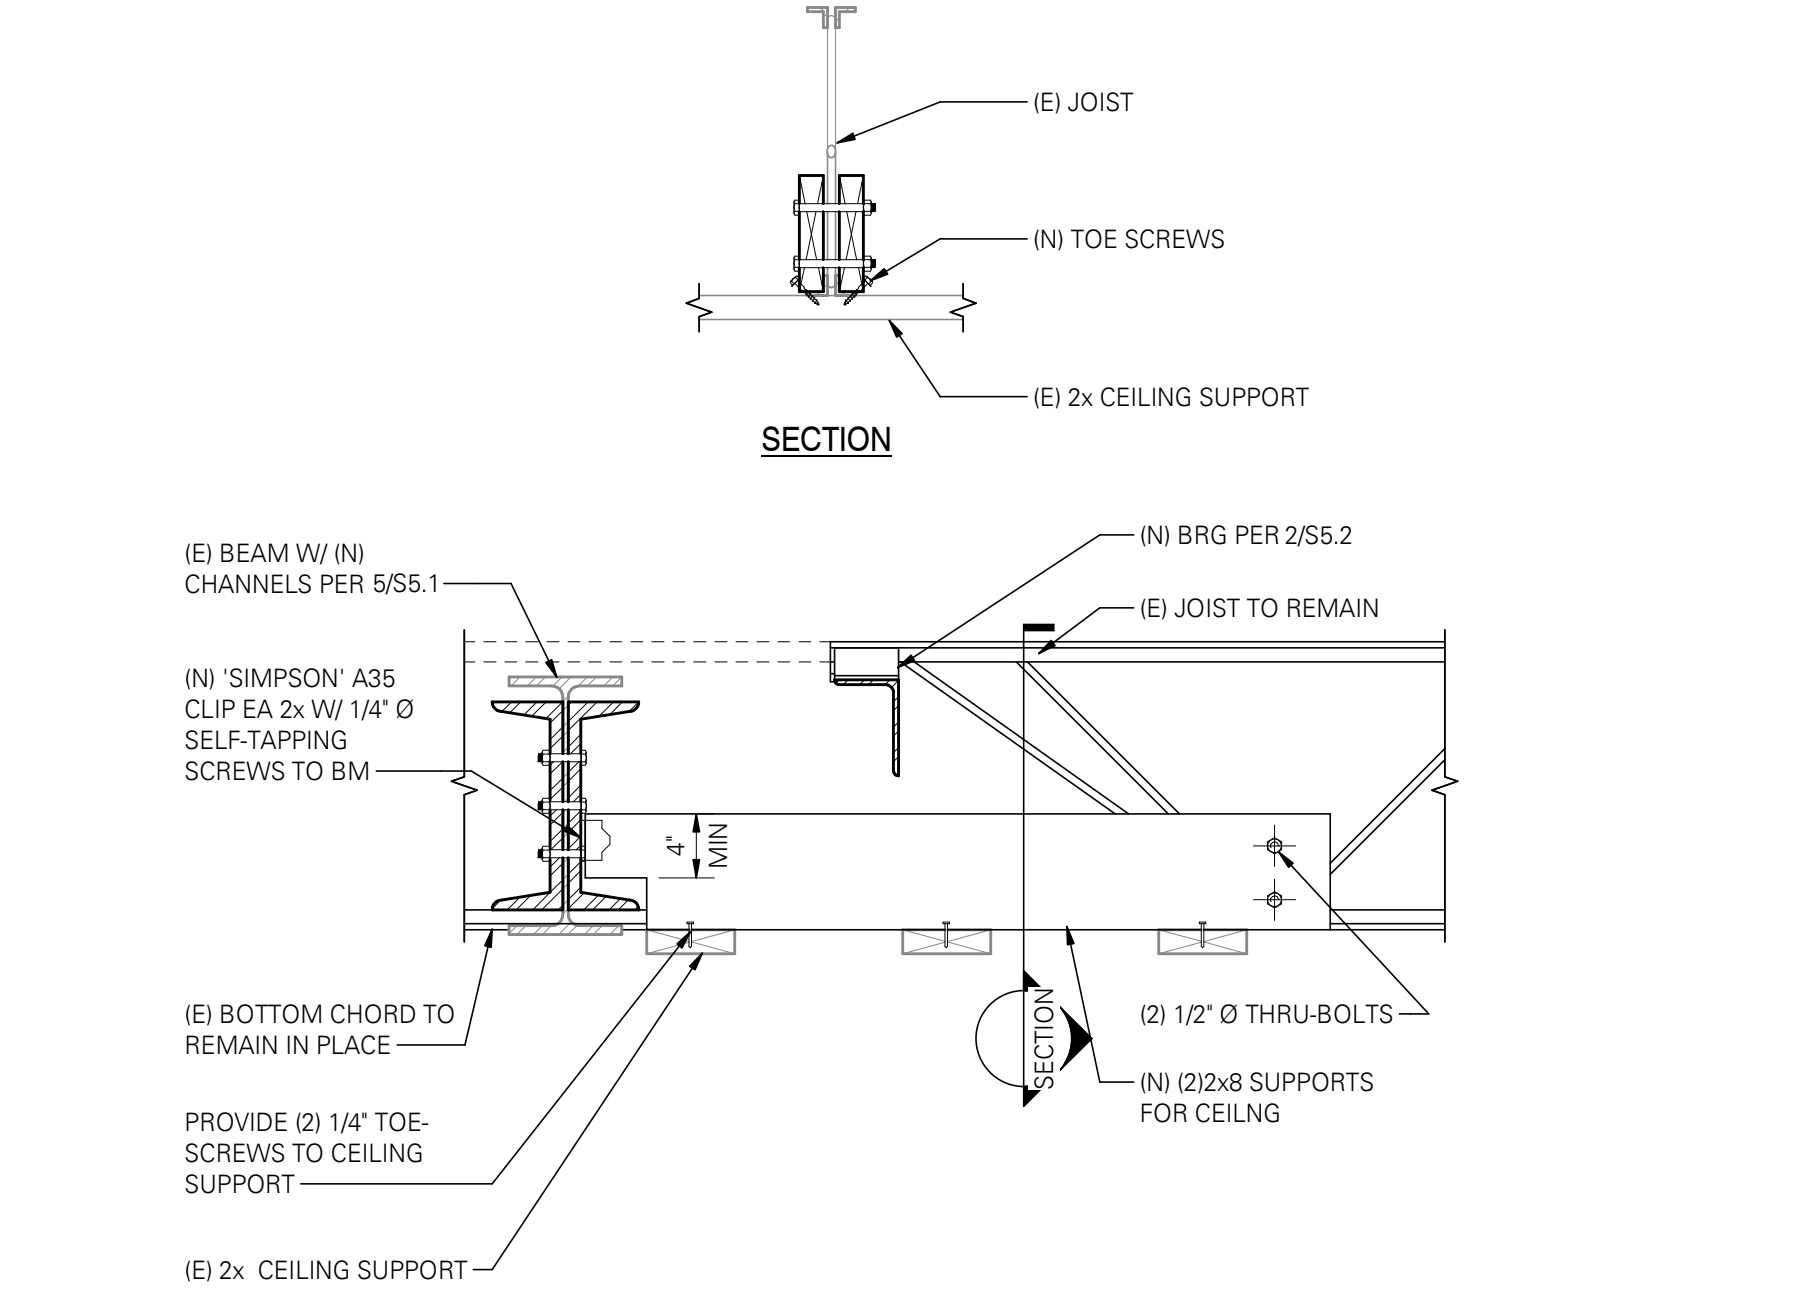

6 SUPPORT FOR CEILING AT (N) BEAM RETROFIT
SCALE: 1" = 1'-0"

DEMOLITION PLAN LEGEND

- INDICATES ITEMS TO BE DEMOLISHED AND/OR REMOVED
- ① SELECTIVE DEMOTION NOTE

GENERAL DEMOLITION NOTES:

- A. THE REMOVAL/DEMOLITION NOTES LISTED ARE INTENDED TO CONVEY A GENERAL DESCRIPTION OF THE REMOVAL/DEMOLITION WORK THROUGHOUT THE PROJECT. SEE INDIVIDUAL DISCIPLINE SHEETS FOR SPECIFIC DEMOLITION WORK.
- B. WHETHER SPECIFICALLY INDICATED OR NOT, ALL ITEMS/MATERIALS/EQUIPMENT REQUIRED TO BE REMOVED OR DEMOLISHED TO COMPLETE THE WORK SHALL BE INCLUDED IN THE BID.
- C. ALL REMOVED ITEMS, EXCEPT THOSE NOTED TO BE REUSED OR TO REMAIN AS THE PROPERTY OF THE OWNER SHALL BECOME THE PROPERTY OF THE CONTRACTOR, AND SHALL BE REMOVED FROM THE JOBSITE.
- D. REFER TO COVER SHEET FOR GENERAL PROJECT NOTES.
- E. REFER TO OTHER PORTIONS OF THE CONTRACT DOCUMENTS FOR ADDITIONAL DEMOLITION REQUIREMENTS. REFER TO A501 FOR EXTENT OF FLOOR REPAIRS. REFER TO A501 FOR EXTENT OF CEILING REPAIRS.
- F. PROTECT THE BUILDING INTERIOR AT ALL TIMES. PROMPTLY REPAIR DAMAGES CAUSED TO ADJACENT FACILITIES/FINISHES BY DEMOLITION OR CONSTRUCTION WORK AT NO ADDITIONAL COST TO THE OWNER. REPAIR SHALL EXTEND TO THE NEAREST INSIDE OR OUTSIDE CORNER.
- G. CONTRACTOR TO VISIT SITE AND VERIFY EXISTING CONDITIONS PRIOR TO BIDDING. CONTRACTOR IS RESPONSIBLE TO COORDINATE THEIR OBSERVATIONS WITH THESE CONTRACT DOCUMENTS. IF INCONSISTENCIES EXIST, THE CONTRACTOR SHALL INFORM THE ARCHITECT BEFORE BIDDING.
- H. PROVIDE DUST PROTECTION AS REQUIRED.
- I. THE BUILDING AND GROUNDS SHALL BE KEPT CLEAN AND FREE OF REFUSE AT ALL TIMES.
- J. DISRUPTIONS AND OUTAGES MUST BE FULLY COORDINATED WITH MSU PM A MINIMUM OF 72-HOURS IN ADVANCE. COORDINATE SCHEDULE OF DEMOLITION WORK WITH MSU TO MINIMIZE DISRUPTION OF OWNER'S OPERATIONS.

PLAN LEGEND

- ROOM --- ROOM NAME
- A### --- ROOM NUMBER
- ① --- PLAN NOTE
- WALL INFILL

PLAN NOTES


1. INFILL WALL, MATCHING EXISTING CONSTRUCTION. PAINT WALL INFILL TO MATCH EXISTING WALL COLOR. SEE A501 FOR PATCHING AND FINISH NOTES.
2. RE-INSTALL DOORS IN THEIR ENTIRETY (INCLUDING DOORS, HARDWARE, FRAME, ETC.)
3. PATCH FLOOR WHERE TEMPORARY WALL SHORING IS LOCATED.

COORDINATION NOTE:


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DEMOLITION NOTES


1. REMOVE PARTITIONS AT LEAST 2'-0" OR AS REQUIRED TO FACILITATE WORK STRUCTURAL UPGRADE WORK. PROTECT ADJACENT SURFACES FROM DAMAGE.
2. CAREFULLY REMOVE DOORS IN THEIR ENTIRETY (INCLUDING DOORS, HARDWARE, FRAME, ETC.), WITH THE INTENTION OF RE-INSTALLING THE DOORS (IN THEIR ENTIRETY).
3. REMOVE FLOORING FINISH MATERIAL AND SLAB TO INSTALL SONOTUBE FOOTING. SEE STRUCTURAL FOR EXTENT OF WORK.
4. REMOVE CEILING(S) TO ACCOMMODATE WALL REMOVAL FOR STRUCTURAL UPGRADES. SEE A9.1 FOR EXTENT OF WORK FOR CEILING PATCHING/REPLACEMENT.
5. REMOVE EXISTING SHORING WALL. SEE A9.1 FOR EXTENT OF WORK FOR CEILING PATCHING/REPLACEMENT.

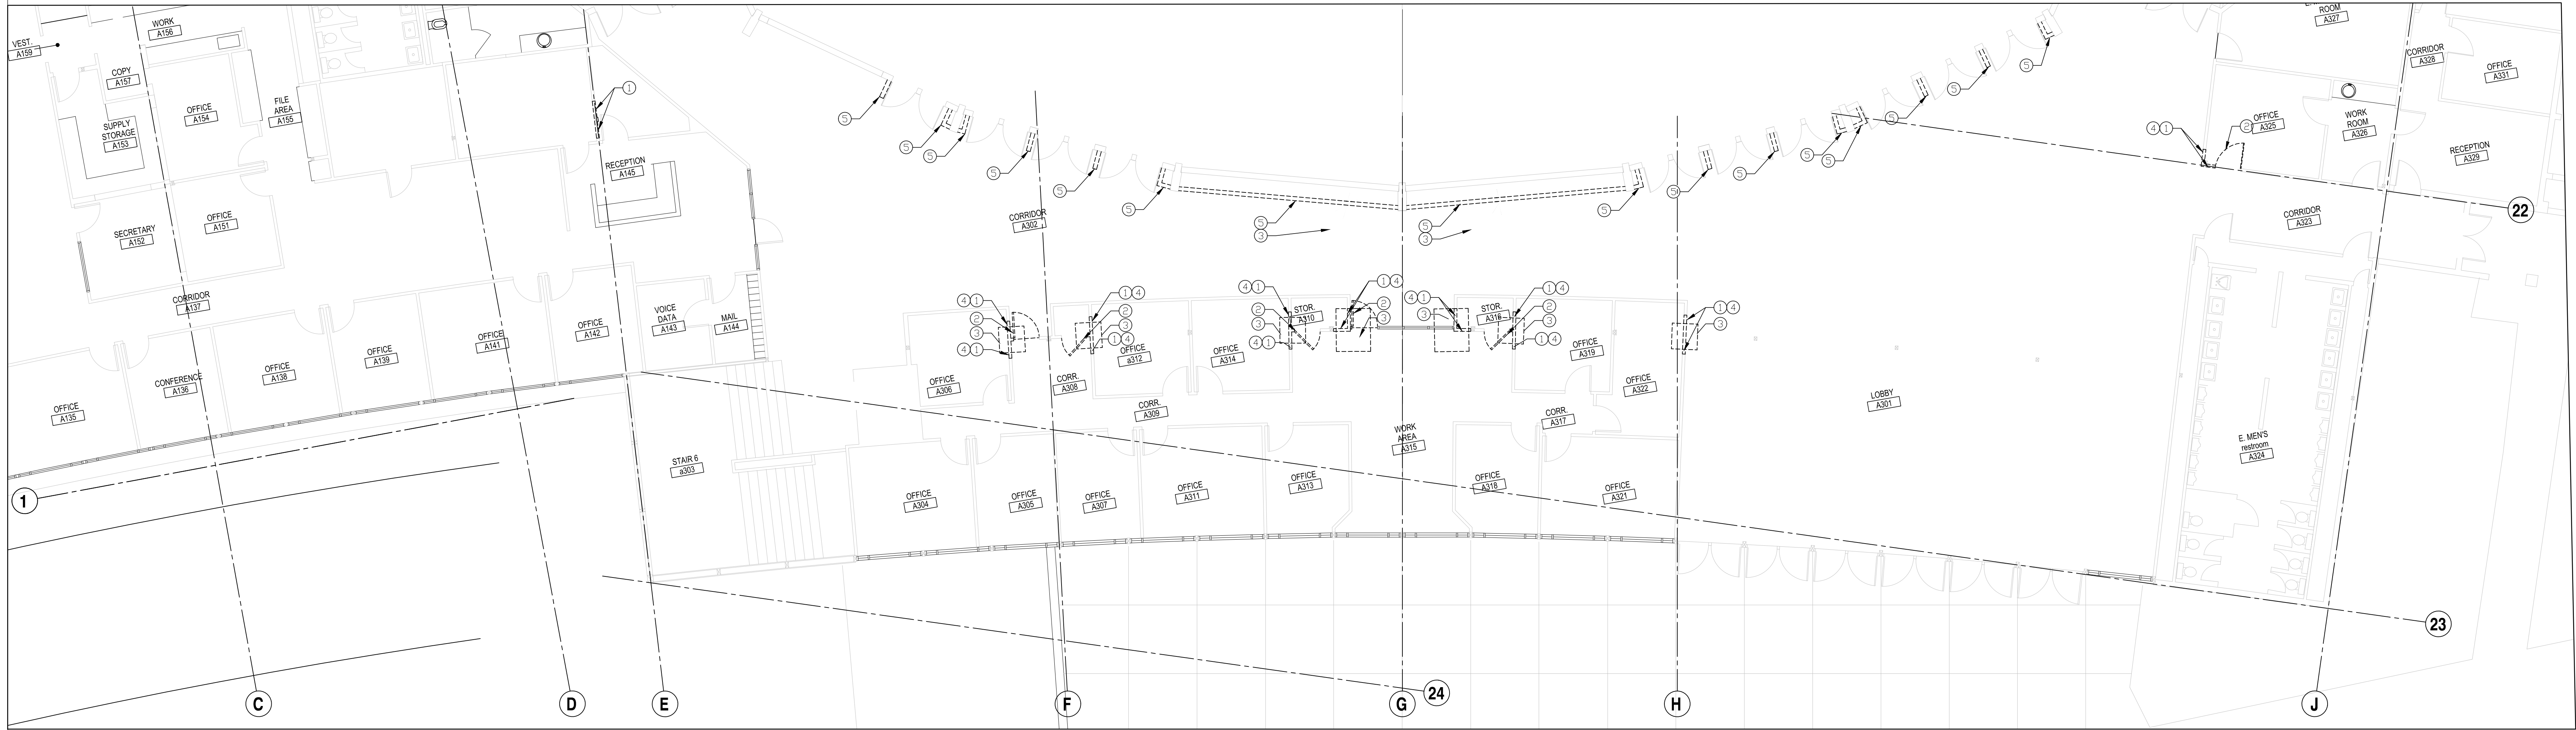


1 DEMO FLOOR PLAN
A1.0 1/8"=1'-0"

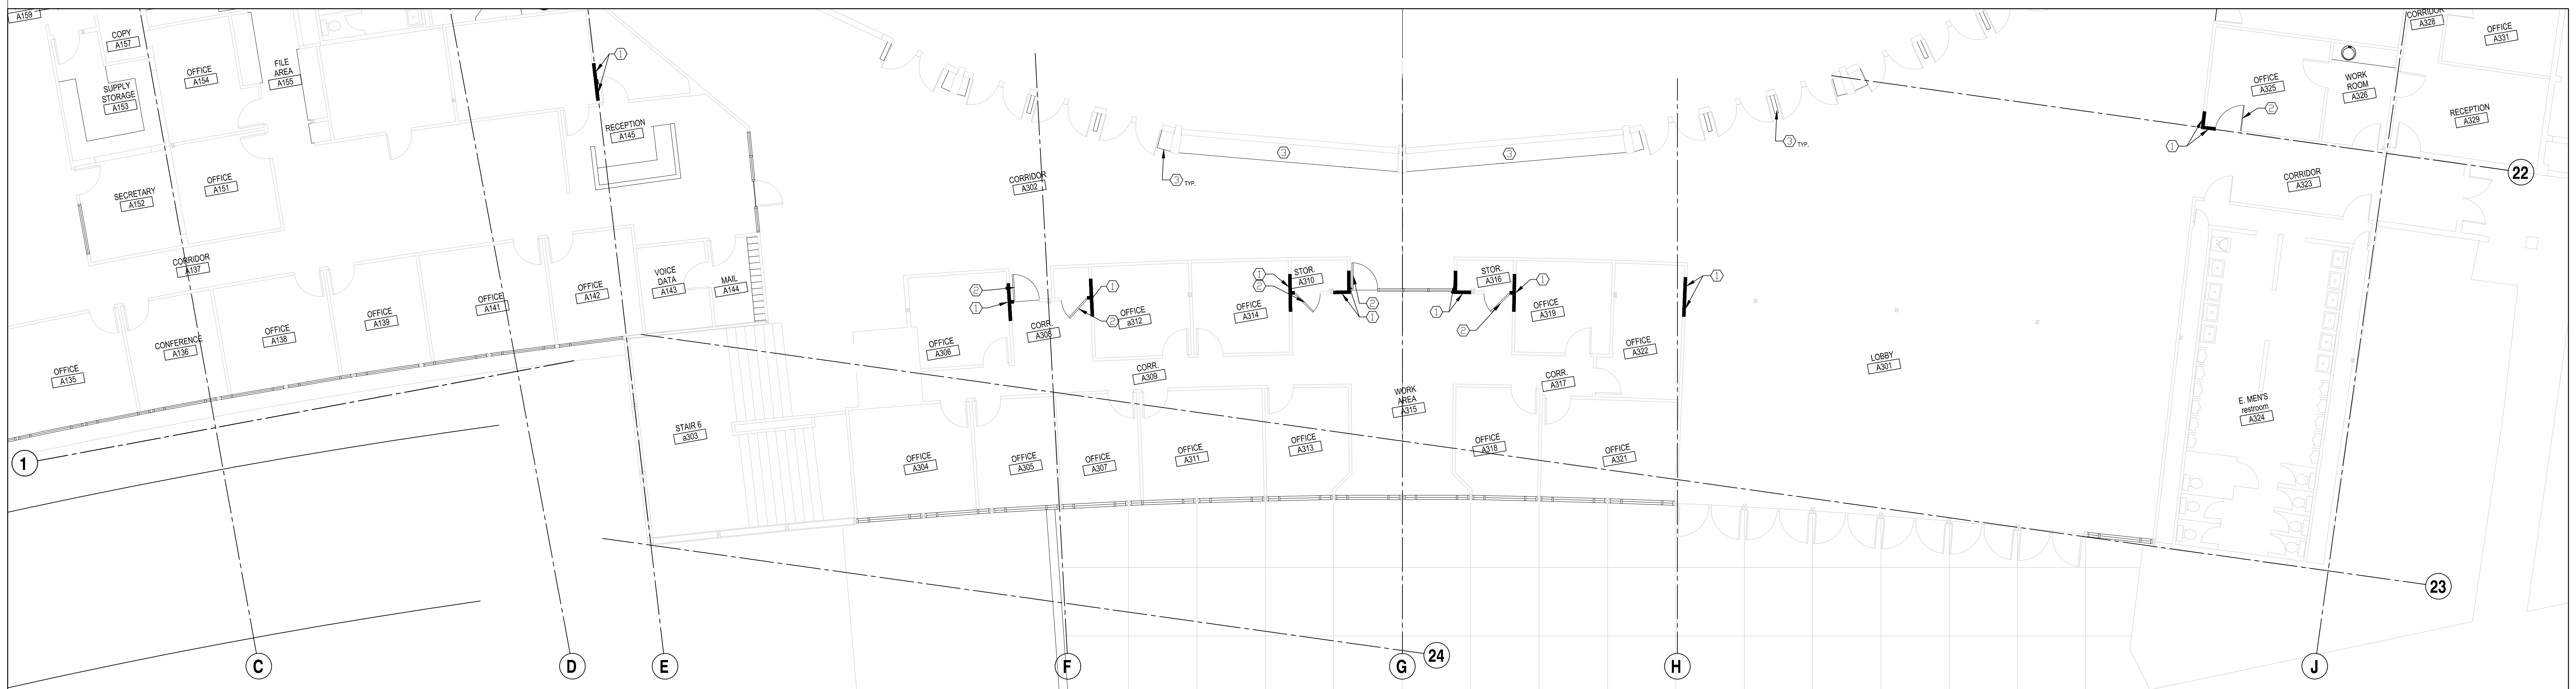


2 FLOOR PLAN
A1.0 1/8"=1'-0"

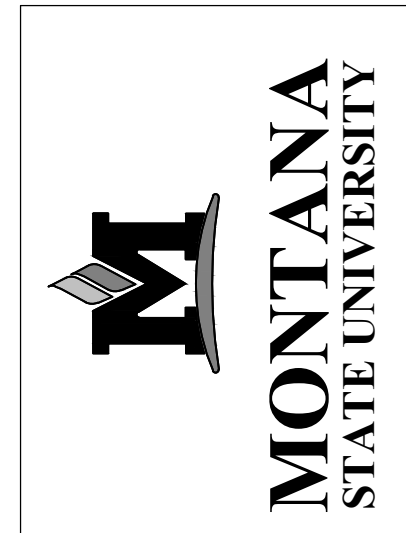

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FAX: 406.994.5665

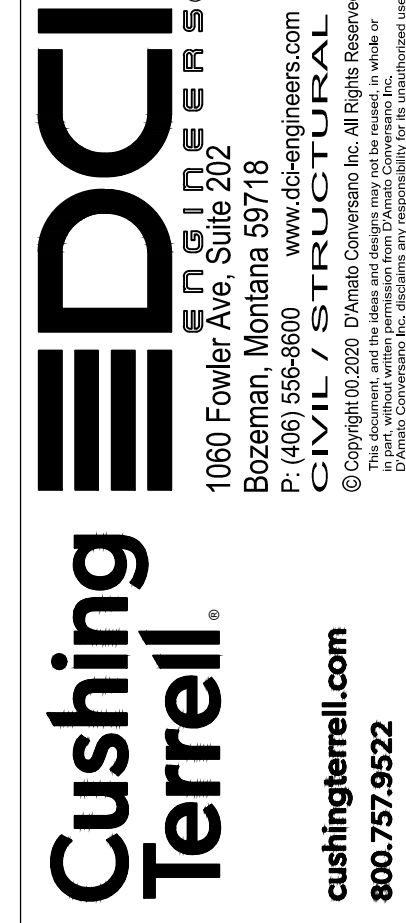

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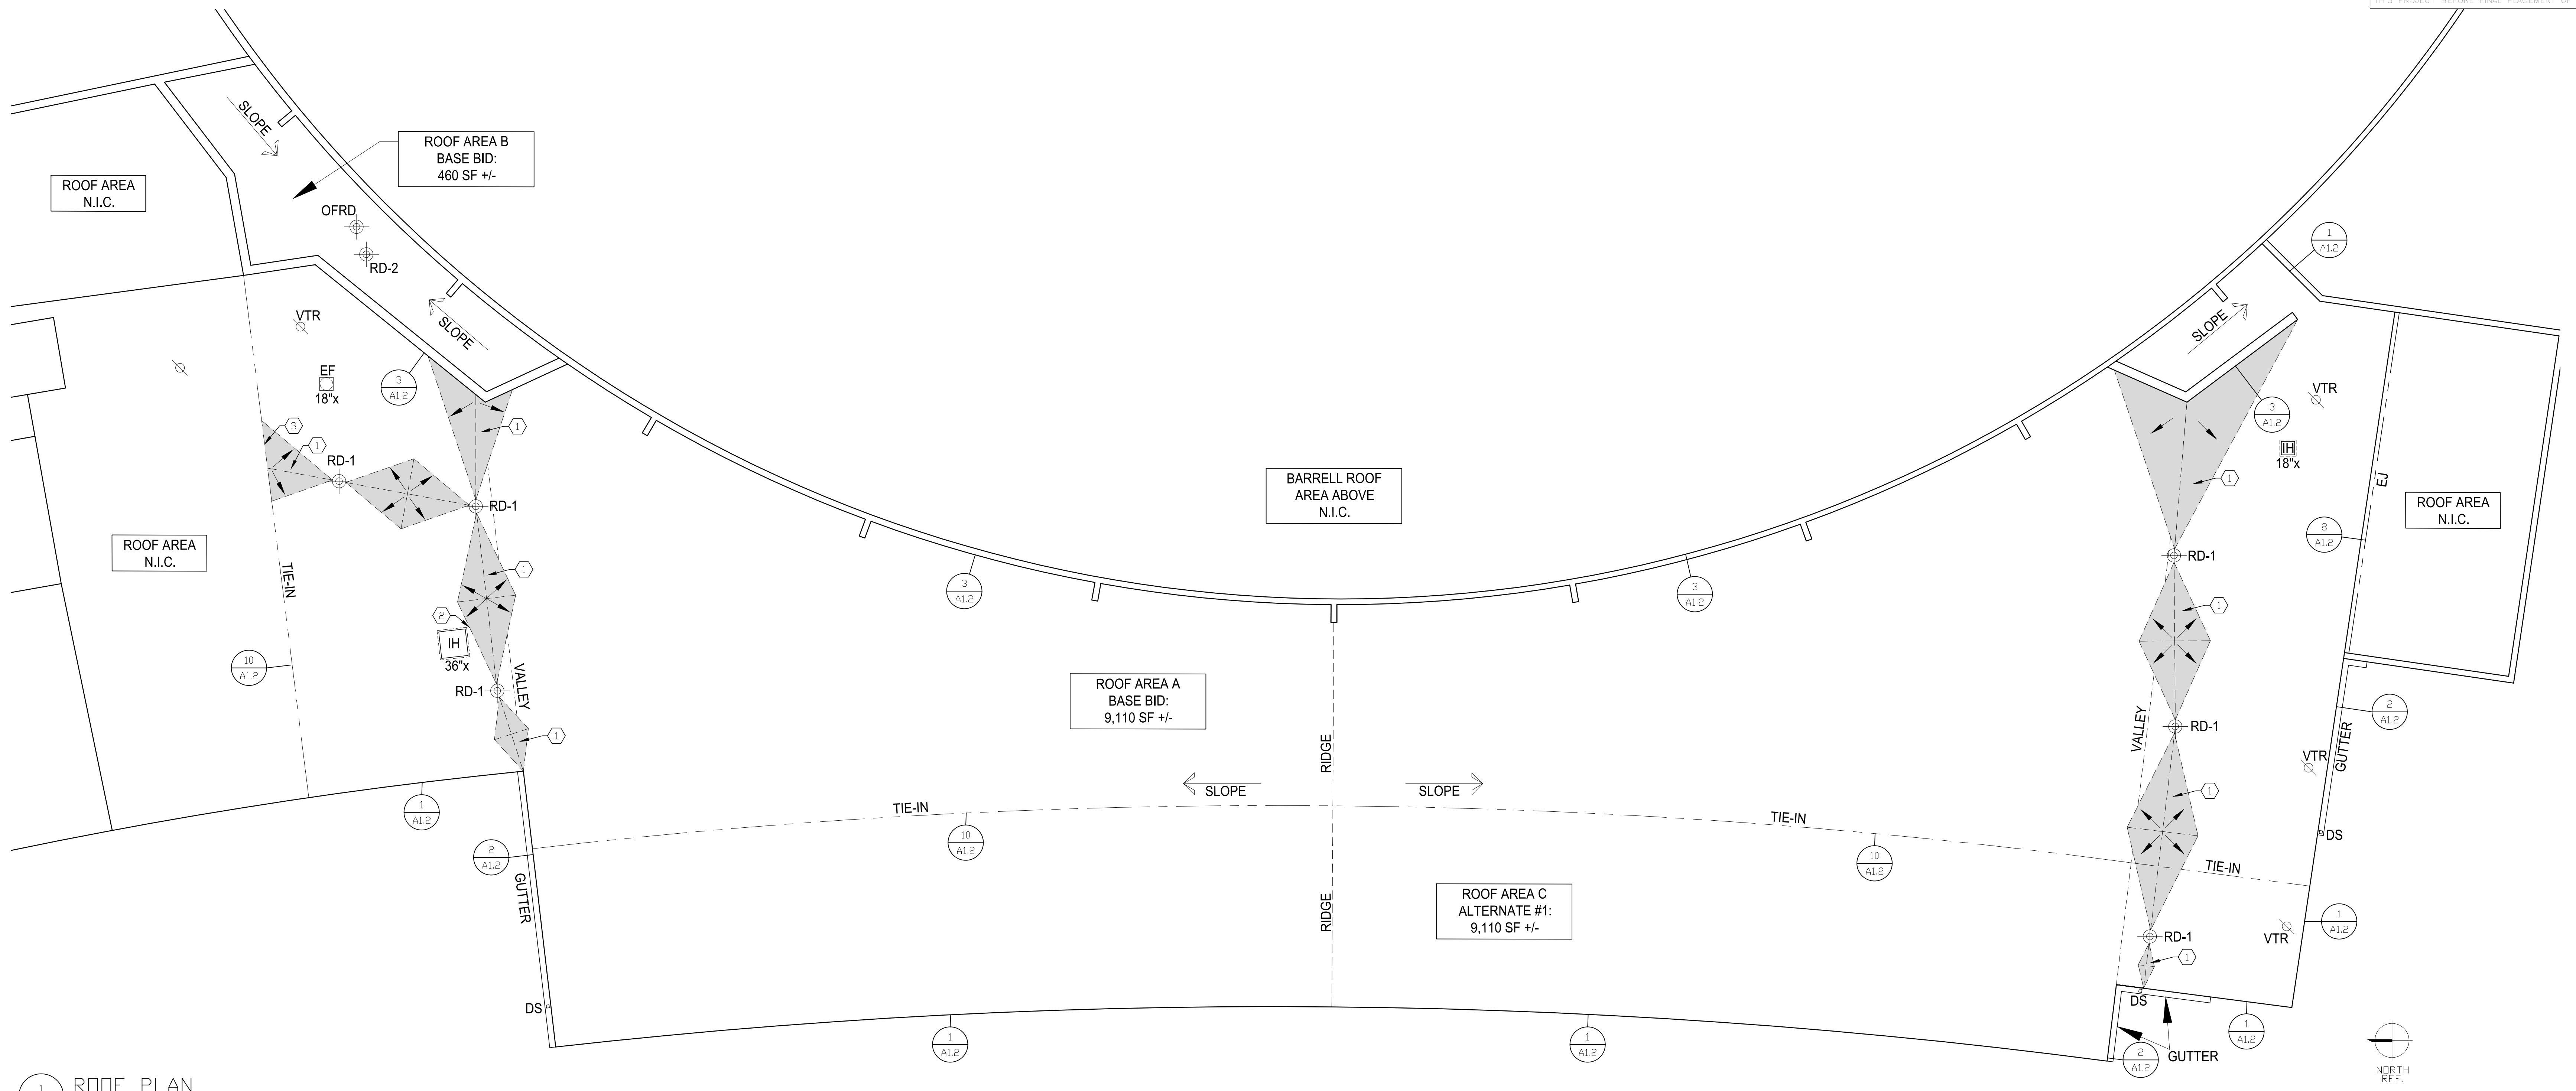
PPA# 19-0172

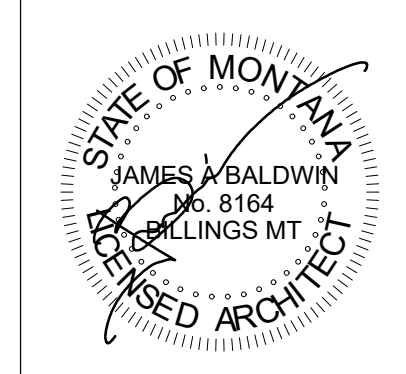Project #
SHEET TITLE
ARCHITECTURAL - FLOOR PLANS


SHEET
A1.0

DATE
11.01.2020


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1 ROOF PLAN
 1/8"=1'-0"



2 EXISTING ROOF CONSTRUCTION - ROOF AREA(S) A, B AND C
 3/8"=1'-0"

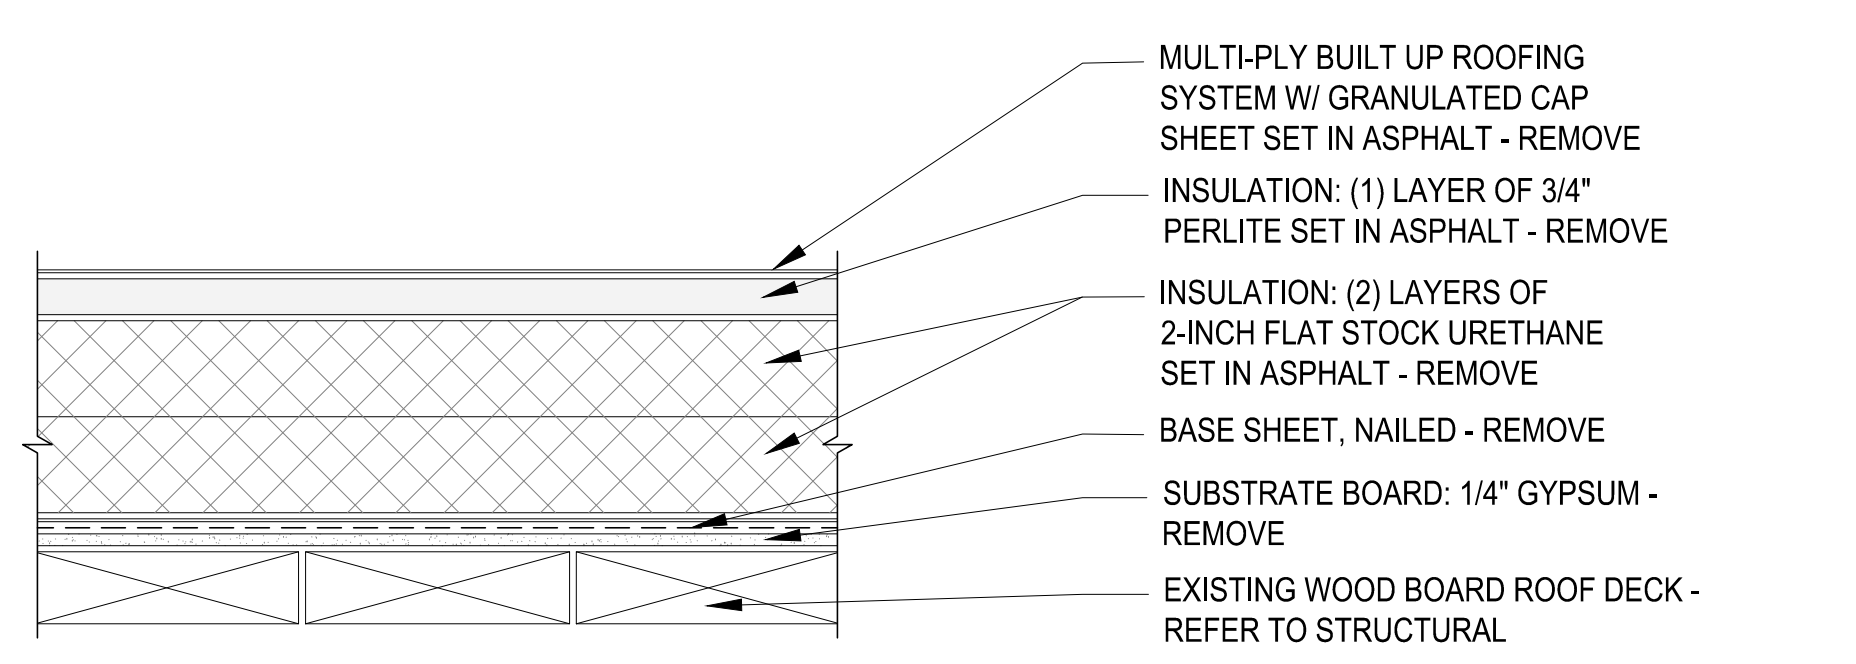

3 NEW ROOF CONSTRUCTION - ROOF AREA(S) A, B AND C
 3/8"=1'-0"

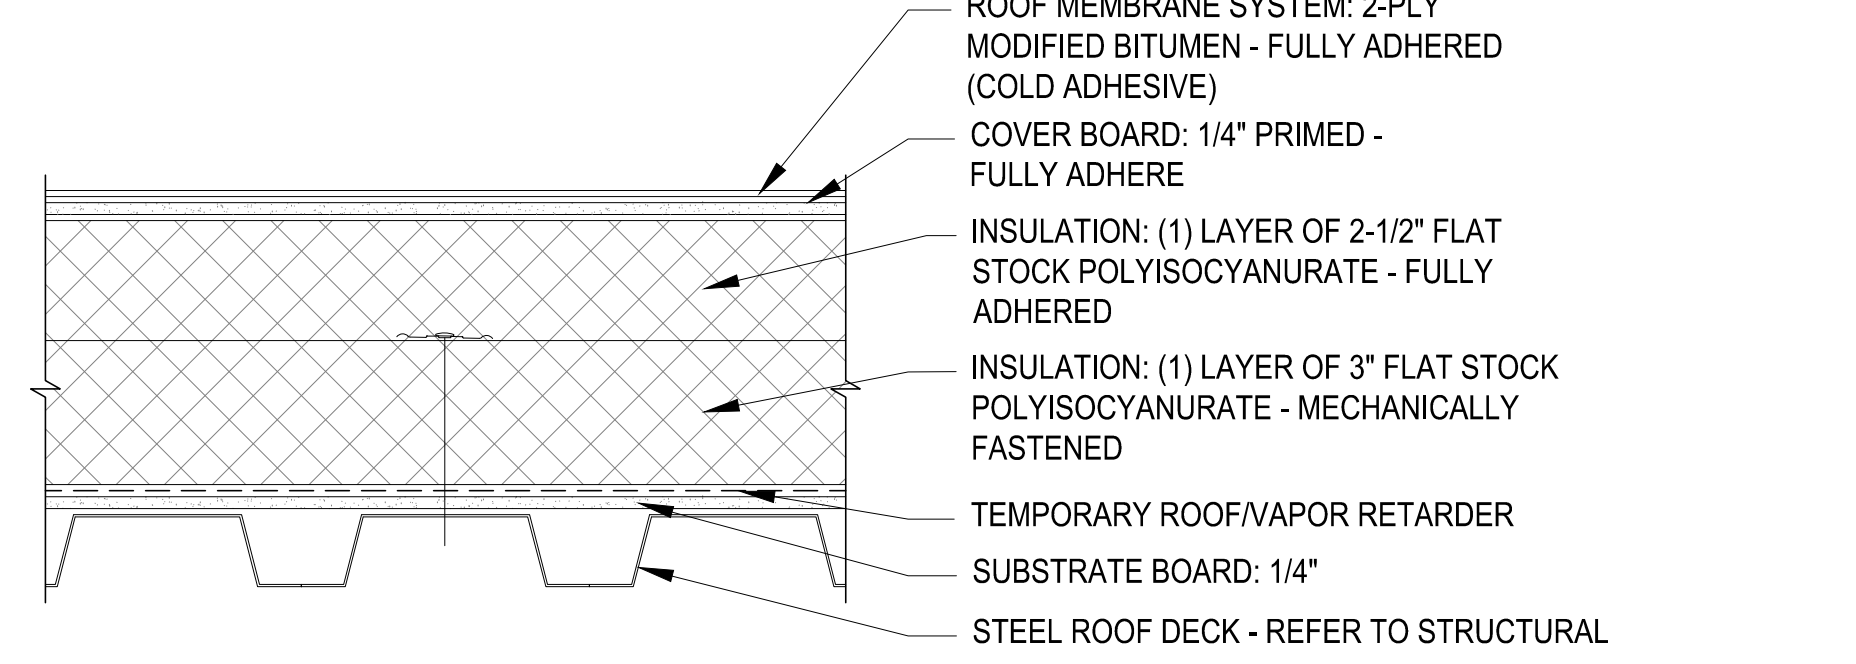GENERAL ROOFING NOTES



- THE FOLLOWING REFERENCES HAVE BEEN USED AS A BASIS FOR DESIGN OF THE ROOFING RELATED WORK OF THE PROJECT AND SHALL BE USED BY THE CONTRACTOR TO DETERMINE REQUIREMENTS FOR FABRICATION AND/OR INSTALLATION WHEN NOT SPECIFICALLY INDICATED IN THE CONTRACT DOCUMENTS.
 - A. NATIONAL ROOFING CONTRACTORS ASSOCIATION (NIRCA) "ROOFING AND WATER PROOFING MANUAL, FIFTH EDITION".
 - B. SHEET METAL AND AIR CONDITIONING NATIONAL CONTRACTORS ASSOCIATION (SMACNA) - "ARCHITECTURAL SHEET METAL MANUAL, FIFTH EDITION".
 - C. 2018 INTERNATIONAL BUILDING CODE.
 - D. INTERNATIONAL PLUMBING CODE, MOST CURRENT ADOPTED VERSION
 - E. AMERICAN SOCIETY OF CIVIL ENGINEERS (ASCE) - SEI/ASCE 7-16 "MINIMUM DESIGN LOADS FOR BUILDINGS AND OTHER STRUCTURES" (REVISION OF SEI/ASCE 7-10).
 - F. MATERIAL MANUFACTURERS MOST RECENT PRINTED SPECIFICATIONS AND INSTALLATION DETAILS.
- PRIOR TO THE START OF WORK THE CONTRACTOR SHALL PROVIDE AND INSTALL PROTECTION OVER, UNDER AND/OR AROUND ALL EXISTING SERVICES LINES, BUILDING COMPONENTS, SIDEWALKS, PAVEMENT AND LANDSCAPING WHICH COULD BE DAMAGED OR SOILED WHILE PERFORMING WORK OF THE CONTRACT.
- DETAILS IN THE PROJECT DRAWINGS ARE SHOWN AT SPECIFIC LOCATIONS AND ARE INTENDED TO SHOW GENERAL REQUIREMENTS THROUGHOUT.
 - A. DETAILS NOTED ARE "TYPICAL" AND IMPLY ALL SIMILAR CONDITIONS TREATED SIMILARLY. MODIFICATIONS TO BE MADE BY THE CONTRACTOR TO ACCOMMODATE MINOR VARIATIONS WITHOUT ADDITIONAL COST TO THE OWNER.
 - B. COMPONENTS NOT INDICATED AS "EXISTING" ON ALL PROJECT DRAWINGS SHALL BE CONSIDERED NEW COMPONENTS TO BE PROVIDED AND INSTALLED BY THE CONTRACTOR.
- IN NO CASE SHALL OTHER CONSTRUCTION RELATED WORK BE DOWN, OVER, OR CONSTRUCTION RELATED TRAFFIC BE ROUTED OVER COMPLETED ROOF SECTIONS WITHOUT PROTECTION BEING PLACED OVER NEW ROOF MEMBRANE/SINGLES. PROTECTION SHALL CONSIST OF THE FOLLOWING (BOTTOM TO TOP):
 - A. 1-INCH EXPANDED POLYSTYRENE
 - B. 10-MIL POLYETHYLENE
 - C. 1/2" PLYWOOD
 - D. WEIGH DOWN ALL PROTECTION MATERIALS TO PREVENT DISPLACEMENT BY WIND.
- NOTE: NEW ROOF AREAS THAT HAVE NOT BEEN PROTECTED FROM CONSTRUCTION RELATED TRAFFIC AS SPECIFIED ABOVE SHALL BE REMOVED AND REPLACED AT NO ADDITIONAL COST TO THE OWNER.
- PROVIDE WALKPADS AROUND ALL ROOF TOP EQUIPMENT.
- PROVIDE CRICKETS ON THE UP SLOPE SIDE OF ALL ROOF CURBS AS REQUIRED FOR DRAINAGE.
- FIELD VERIFY ALL DIMENSIONS.

ROOF SYMBOL LEGEND

- RD-1 NEW ROOF DRAIN AT EXISTING LOCATION - INSTALL PER DETAIL 7/A1.2
- RD-2 EXISTING ROOF DRAIN - REFER TO DETAIL 7/A1.2 FOR SIMILAR
- OFRD EXISTING OVERFLOW ROOF DRAIN - REFER TO DETAIL 7/A1.2 FOR SIMILAR
- EF EXHAUST FAN CURB (ELEC. OR SERVICEABLE) - REFER TO DETAIL 4/A1.2
- IH INTAKE HOOD/VENT (NO ELEC.) - REFER TO DETAIL 4/A1.2
- VTR PLUMBING VENT THROUGH ROOF - FLASH PER DETAIL 5/A1.2
- PARAPET/ROOF TO WALL - REFER TO DETAIL 3/A1.2
- CONCRETE COLUMNS THROUGH ROOF - INSTALL BASEFLASHING PER DETAIL 3/A1.2
- ROOF EDGE - REFER TO DETAIL 1/A1.2
- ROOF EDGE W/ GUTTER - REFER TO DETAIL 2/A1.2
- GUTTER LOCATION OF NEW GUTTER DOWNSPOUT - REFER TO DETAIL 8/A1.2
- DS
- RIDGE ROOF SLOPE RIDGE LINE
- VALLEY ROOF SLOPE VALLEY LINE
- TIE-IN NEW TO EXISTING ROOF TIE-IN - REFER TO DETAIL 10/A1.2
- EJ EXPANSION JOINT AT NEW TO EXISTING ROOF SECTION - INSTALL PER DETAIL 8/A1.2
- SLOPE DIRECTION OF FINISHED ROOF SLOPE FROM SLOPING STRUCTURE
- DIRECTION OF FINISHED ROOF SLOPE FROM TAPERED INSULATION / CRICKETS
- TAPERED INSULATION / CRICKET (light shade)
- ROOF PLAN NOTE
- AREA * * ROOF AREA DESIGNATION TAG: SF IS APPROXIMATE - FIELD VERIFY
- ### SF

ROOF PLAN NOTES:


- INSTALL 1/2" IN 12" TAPERED POLYISOCYANURATE CRICKET
- INSTALL CRICKET AS REQUIRED TO CLEAR EDGE OF CURB AS INDICATED
- INSTALL CRICKET AS REQUIRED TO MATCH HEIGHT AND WIDTH OF CRICKET OF ADJACENT SECTION AT NEW TO EXISTING ROOF TIE-IN

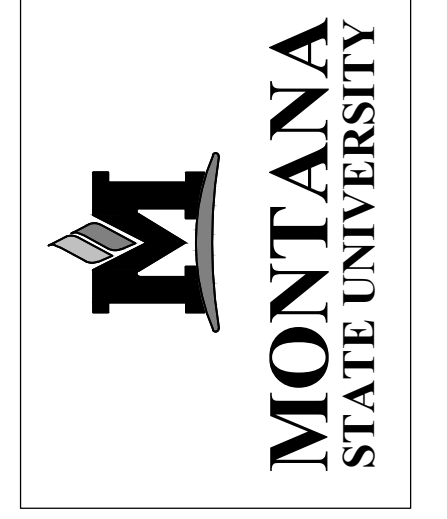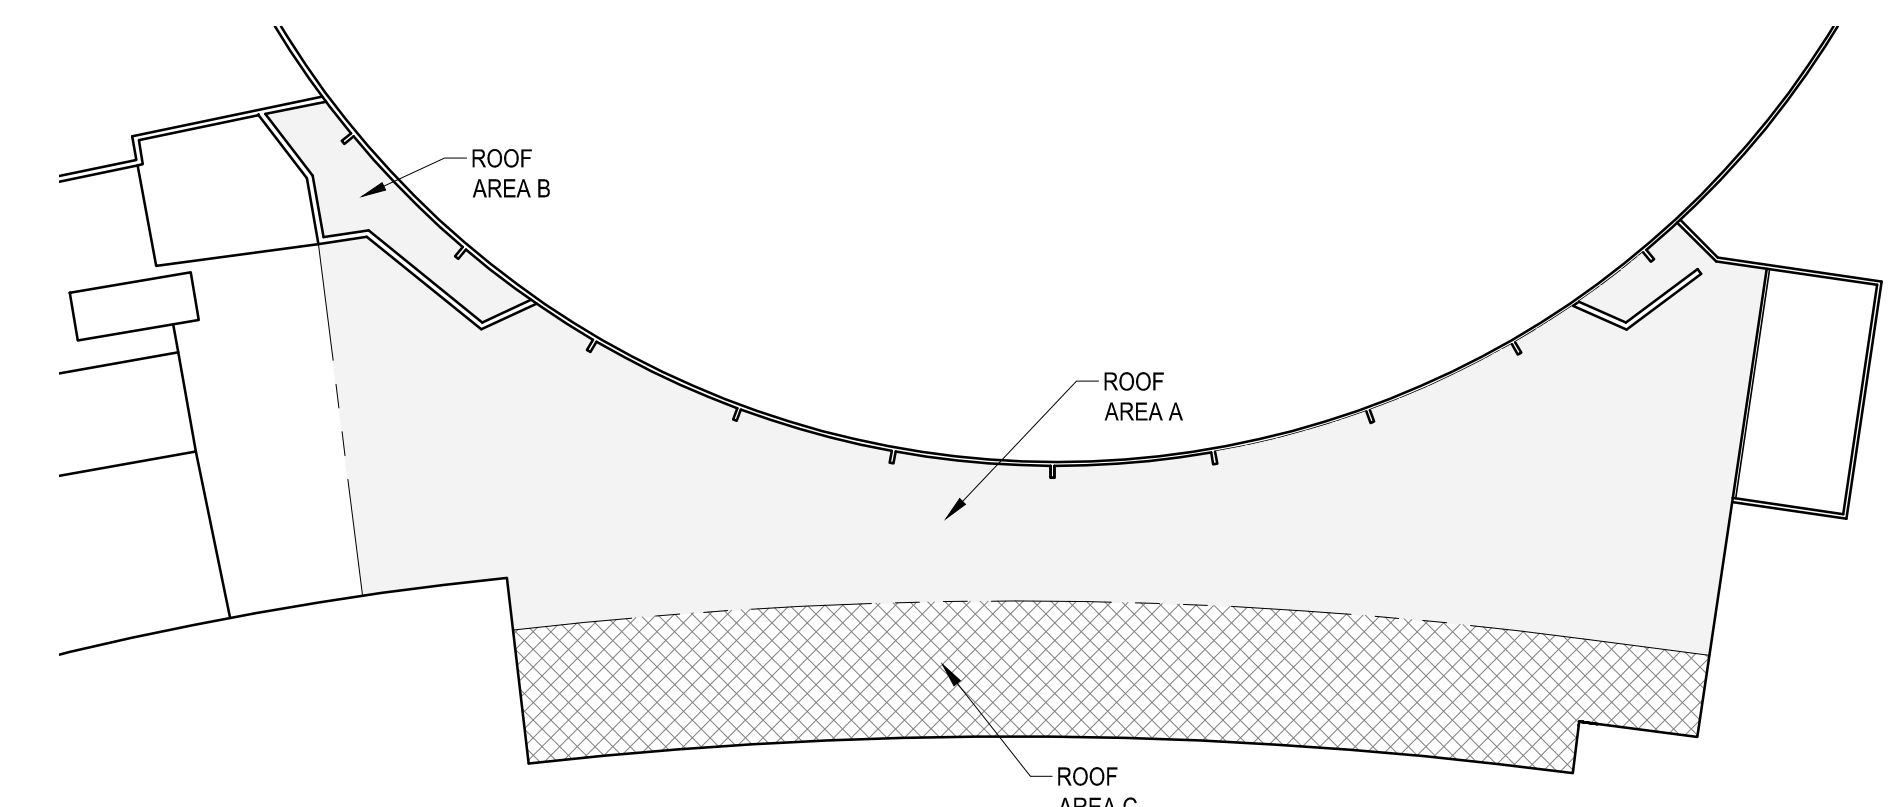

MSU-CPDC
 MONTANA STATE UNIVERSITY
 BOZEMAN, MONTANA
 PHONE: 406.994.5413
 FAX: 406.994.5665

DCI
Cushing Terrell
 1060 Fowler Ave. Suite 200
 Bozeman, Montana 59718
 P: (406) 556-8000
 CUSHING@CUSHINGTERRELL.COM
 WWW.CUSHINGTERRELL.COM
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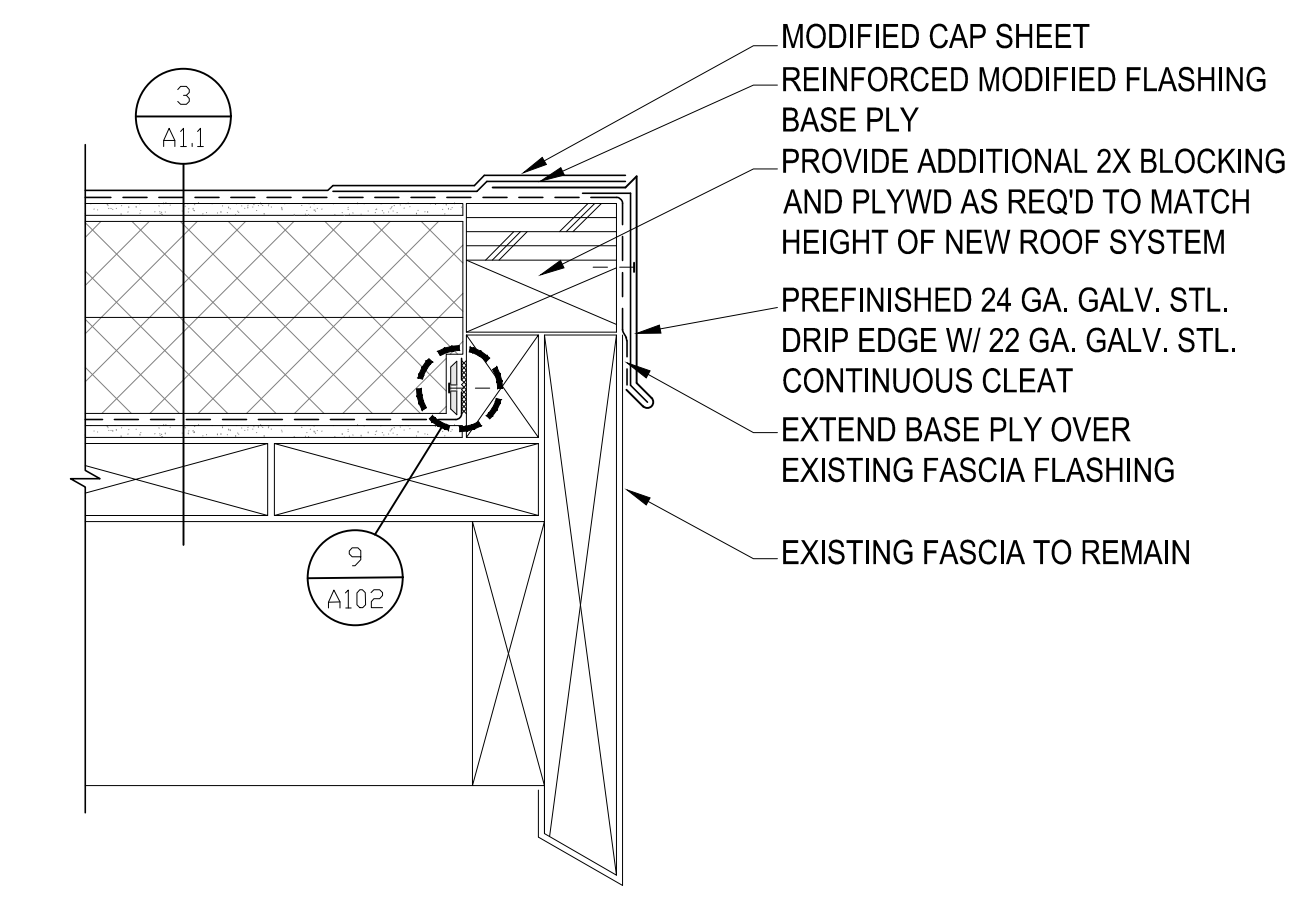
PPA# 19-0172

SHEET TITLE

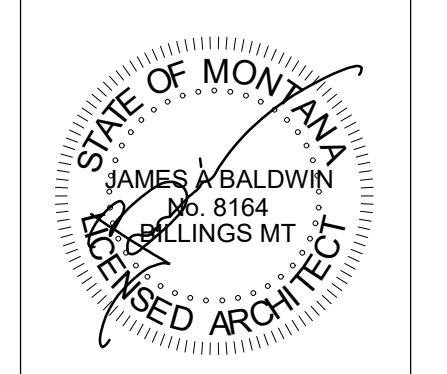
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DATE
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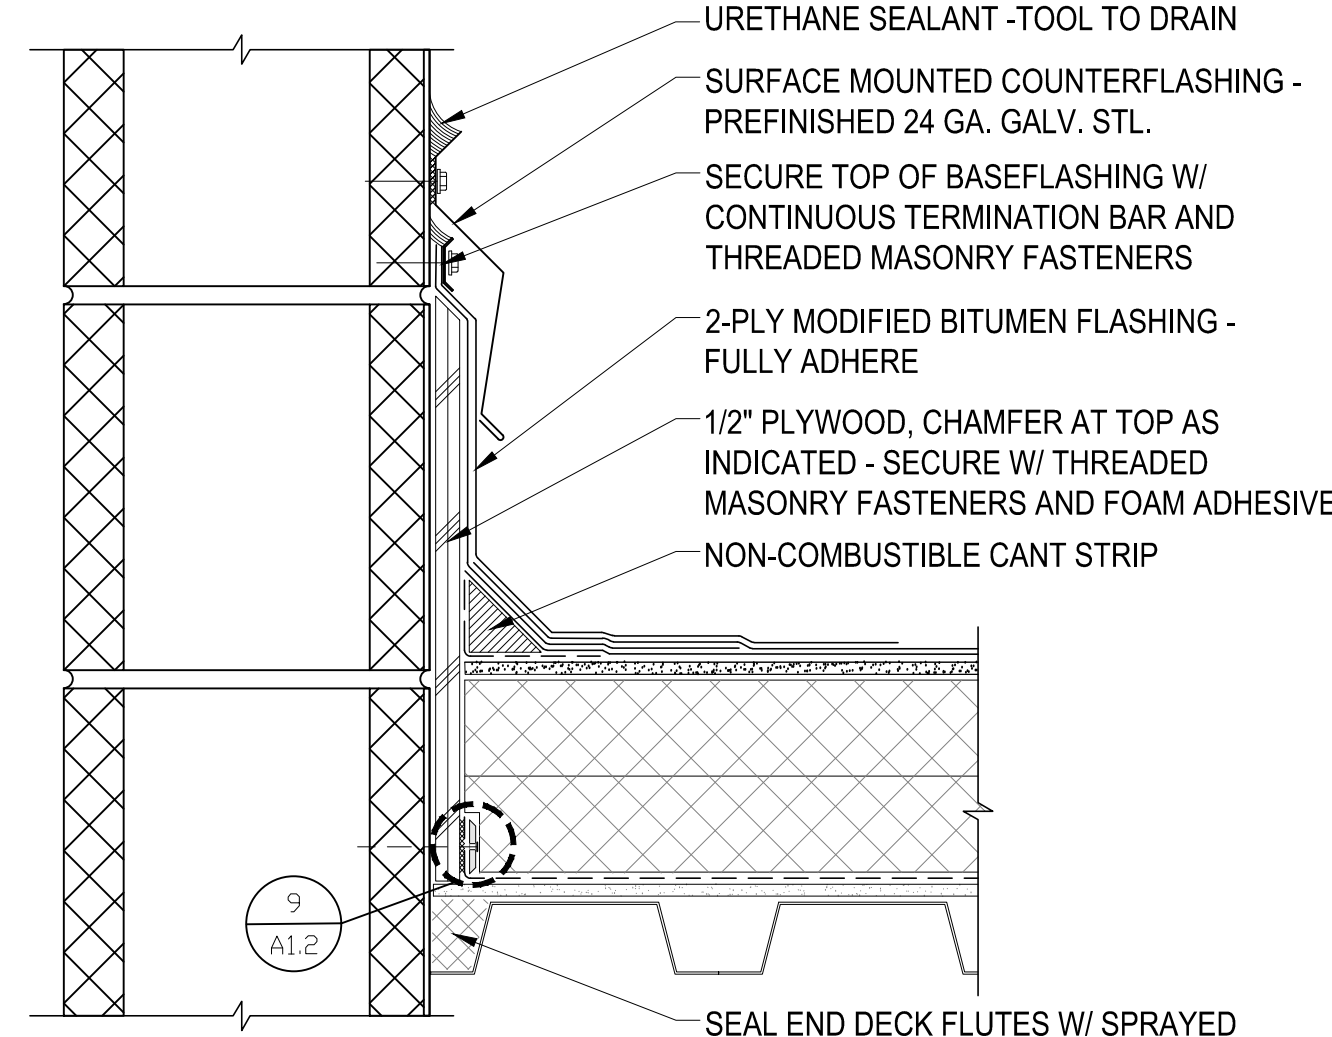
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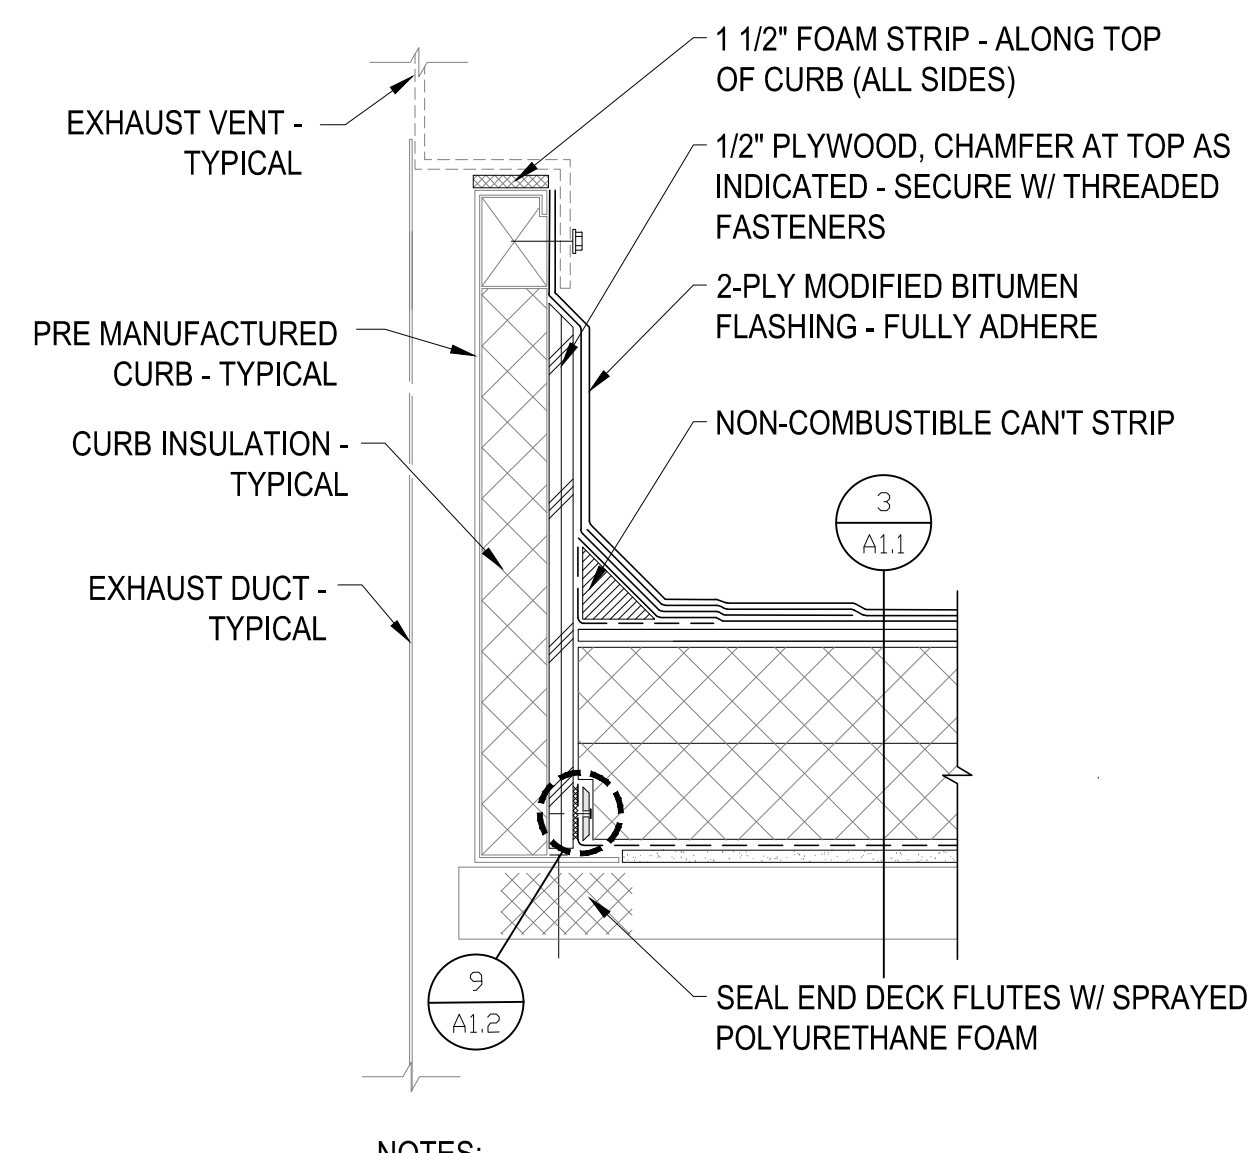
1 ROOF EDGE
 SCALE = 3"=1'-0"




2 ROOF DRAINING EDGE W/ GUTTER
 SCALE = 3"=1'-0"




3 ROOF DRAINING EDGE W/ GUTTER
 SCALE = 3"=1'-0"

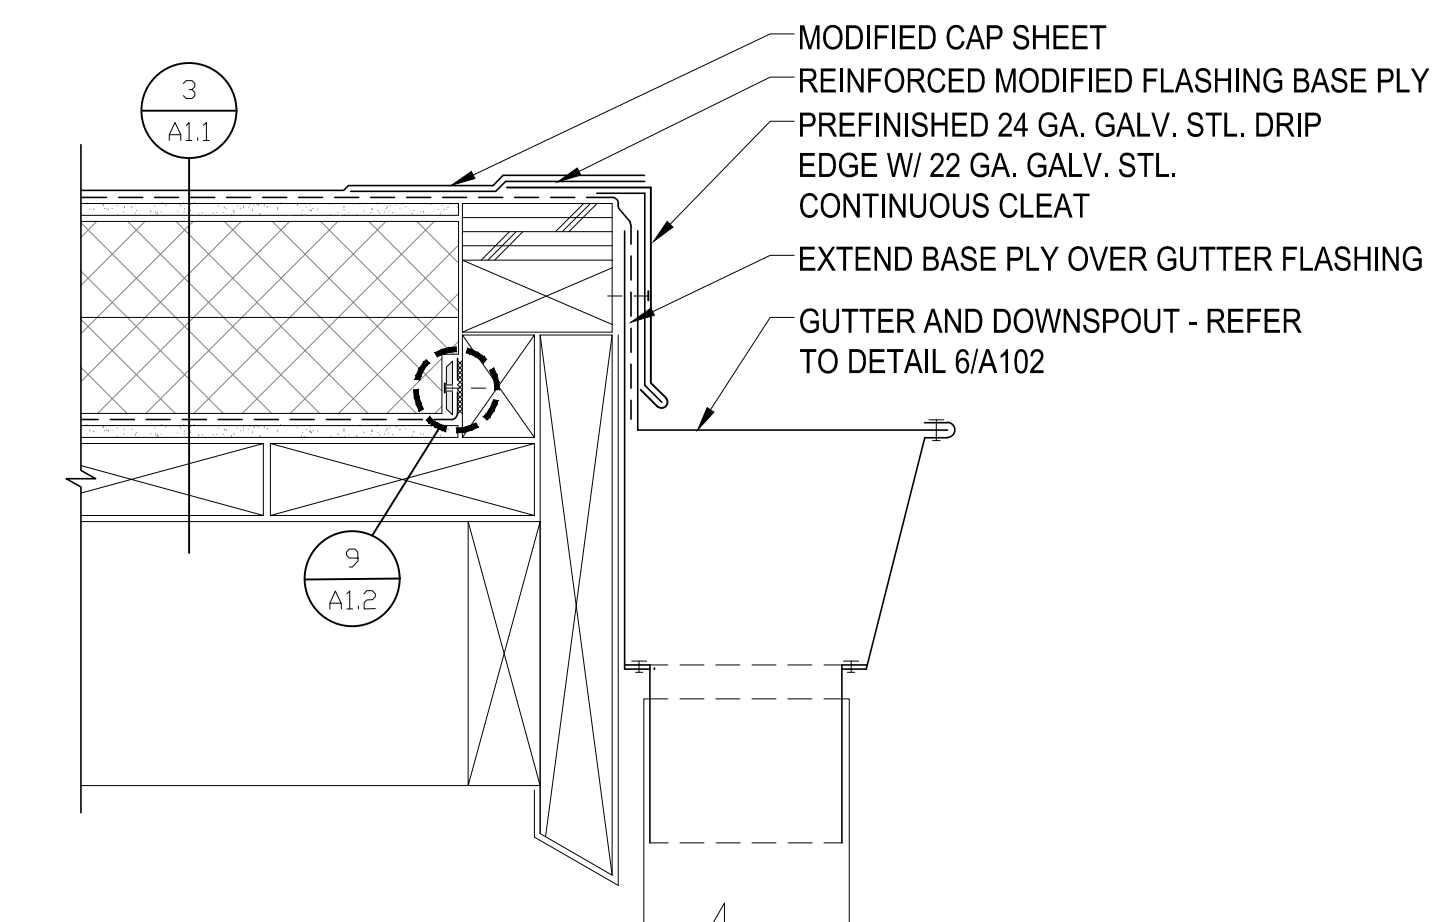


4 EQUIPMENT CURB
 SCALE = 3"=1'-0"

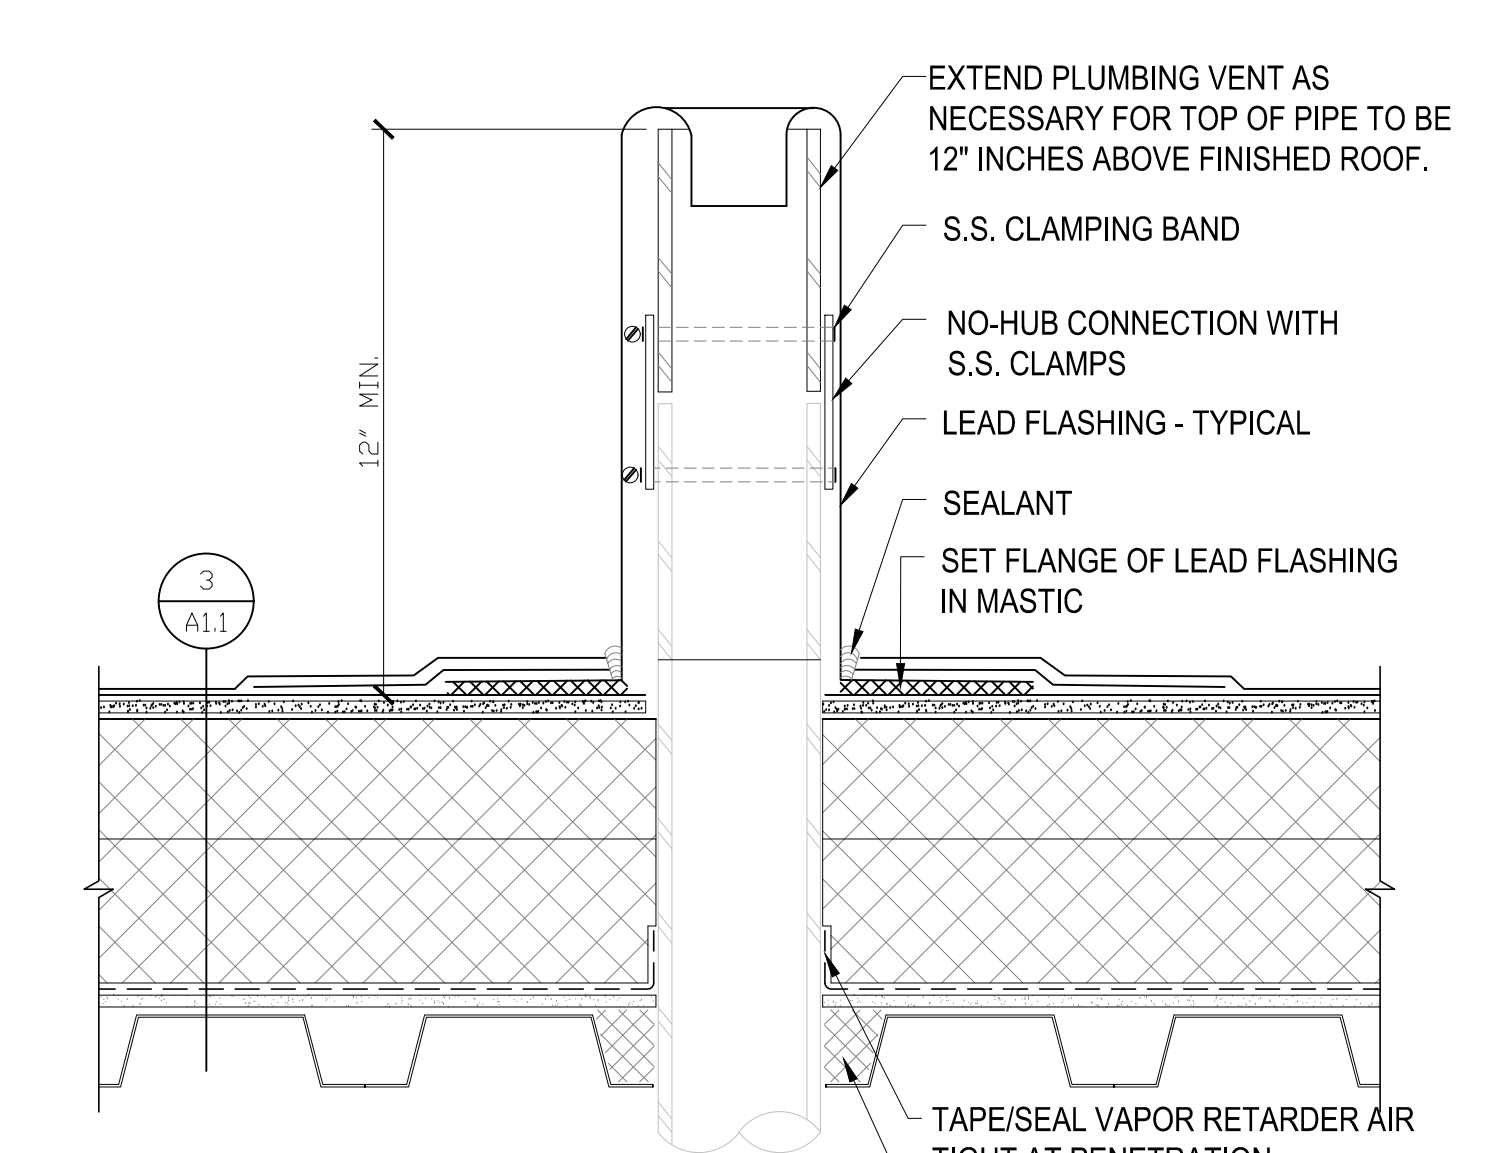


5 VENT THROUGH ROOF
 SCALE = 3"=1'-0"

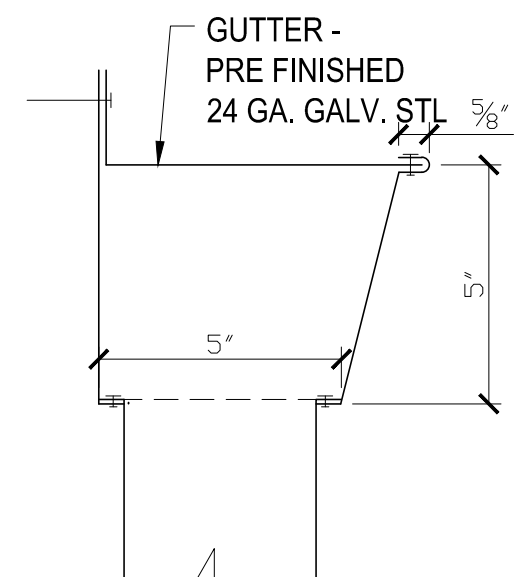

GUTTER DIMENSIONS

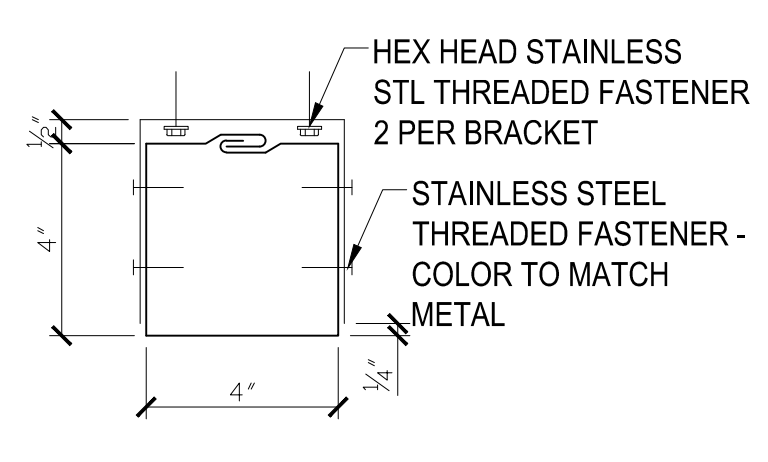


DOWNSPOUT DIMENSIONS

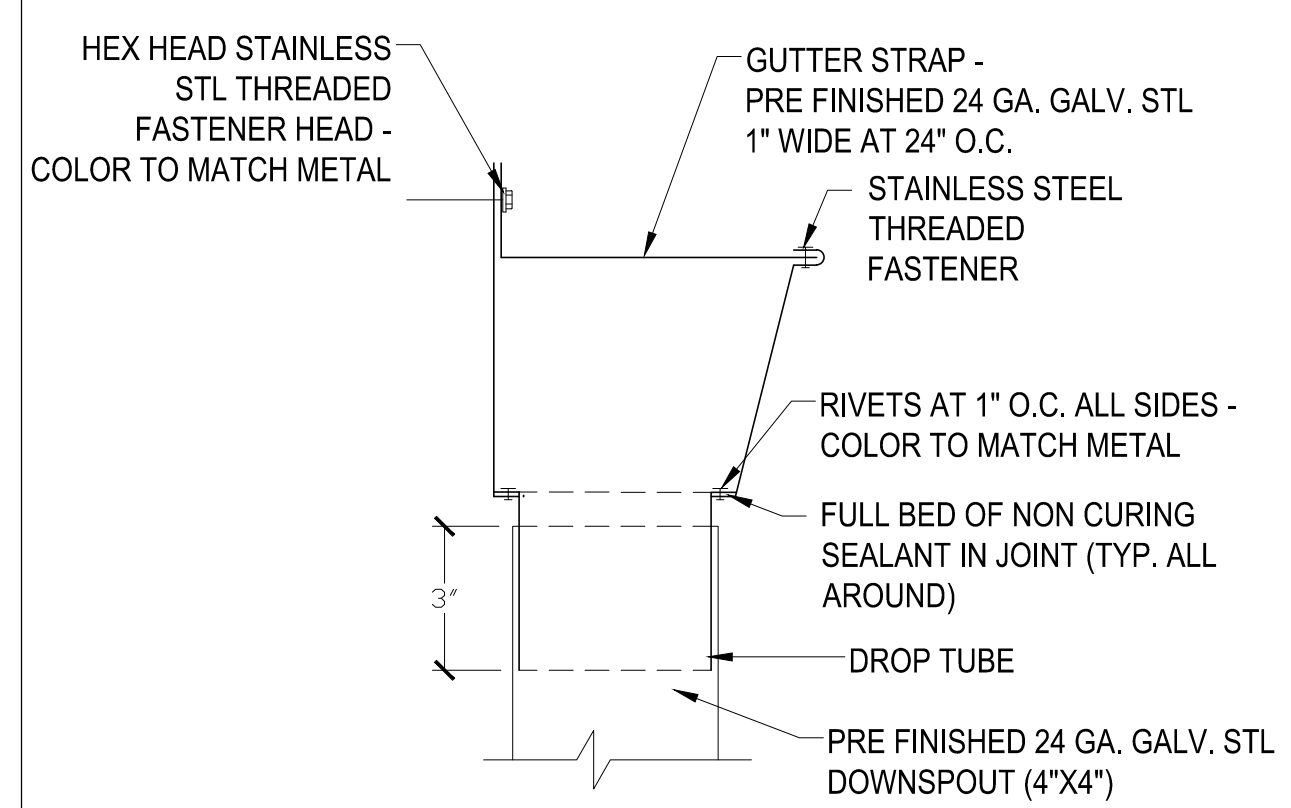


6 GUTTER & DOWNSPOUT
 SCALE = 3"=1'-0"


- GUTTER NOTE(S):**
- GUTTER JOINTS - JOIN ADJACENT PIECES OF GUTTER USING "BUTT JOINTS" WITH CONCEALED PRE FINISHED 24 GA. GALV. STL. SPLICE PLATE. SET SPLICE PLATE IN BED OF NON CURING SEALANT AND SECURE WITH RIVETS. COLOR OF RIVETS TO MATCH METAL. CLEAN SEALANT OVER RUN FROM EXPOSED SURFACE OF GUTTER.
 - GUTTER INSIDE/OUTSIDE CORNERS - PRE FABRICATE CORNERS W/ 2" LEGS, NEATLY MITER, SEAL LAP AND RIVET CORNER JOINTS. COLOR OF RIVETS TO MATCH METAL. CLEAN SEALANT OVER RUN FROM EXPOSED SURFACE OF GUTTER.
 - GUTTER EXPANSION JOINTS - CONSTRUCT USING "BUTT TYPE" JOINT AT LOCATIONS INDICATED. REFER TO SMACNA ARCHITECTURAL SHEET METAL MANUAL FOR APPROVED DESIGN.
 - DOWNSPOUTS - FORM USING CONTINUOUS LOCK SEAM. JOIN USING OVER LAP JOINTS IN THE DIRECTION OF WATER FLOW. SECURE JOINT USING STAINLESS STL THREADED FASTENERS W/ HEAD COLOR MATCHING METAL. NEATLY MITER ALL ELLS TO RETURN DOWNSPOUT UNDER SOFFIT FROM ROOF EAVES TO EXTERIOR WALL(S). SLOPE DOWNSPOUT AT 1/2" UNDER SOFFIT.
 - DOWNSPOUT BRACKETS - HEM ALL CUT EDGES WHERE EXPOSED ALONG DOWNSPOUTS. PROVIDE BRACKETS AT 4' O.C. (3 MIN. PER DOWNSPOUT).

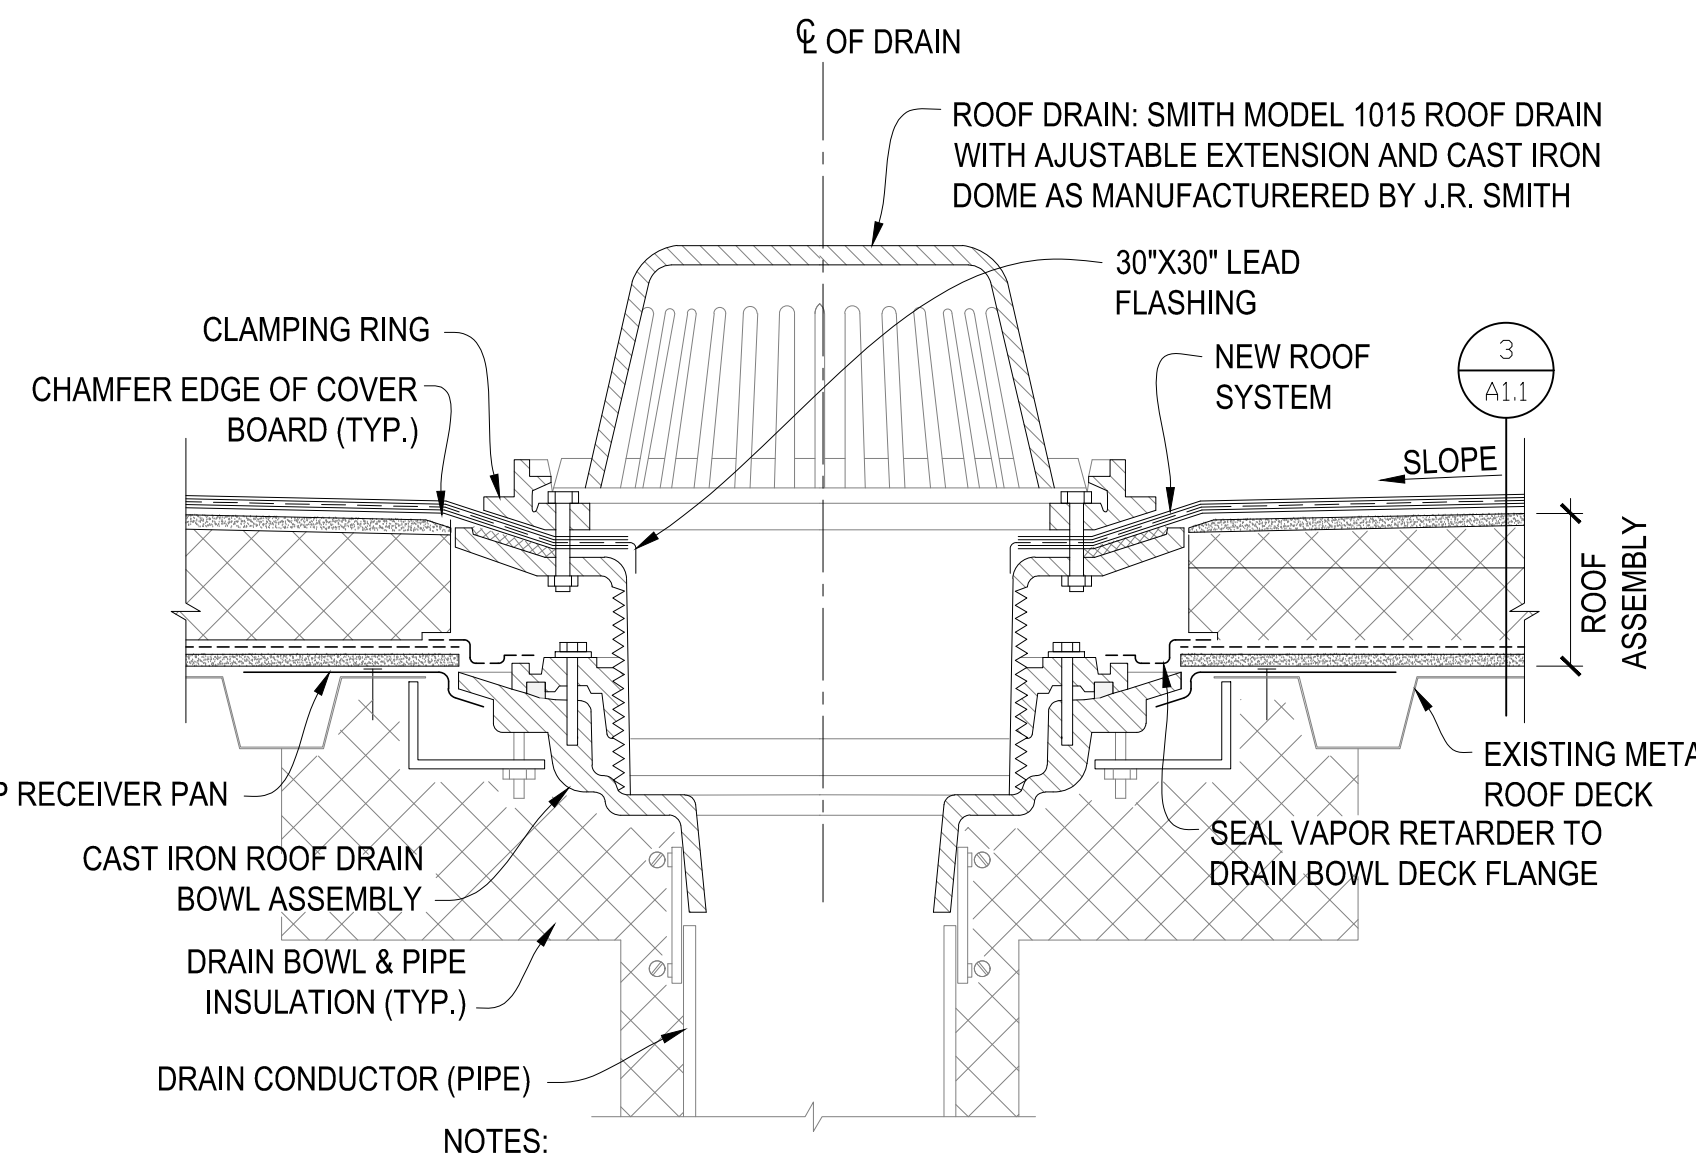


7 NEW ROOF DRAIN AT EXISTING LOCATION
 SCALE = 3"=1'-0"

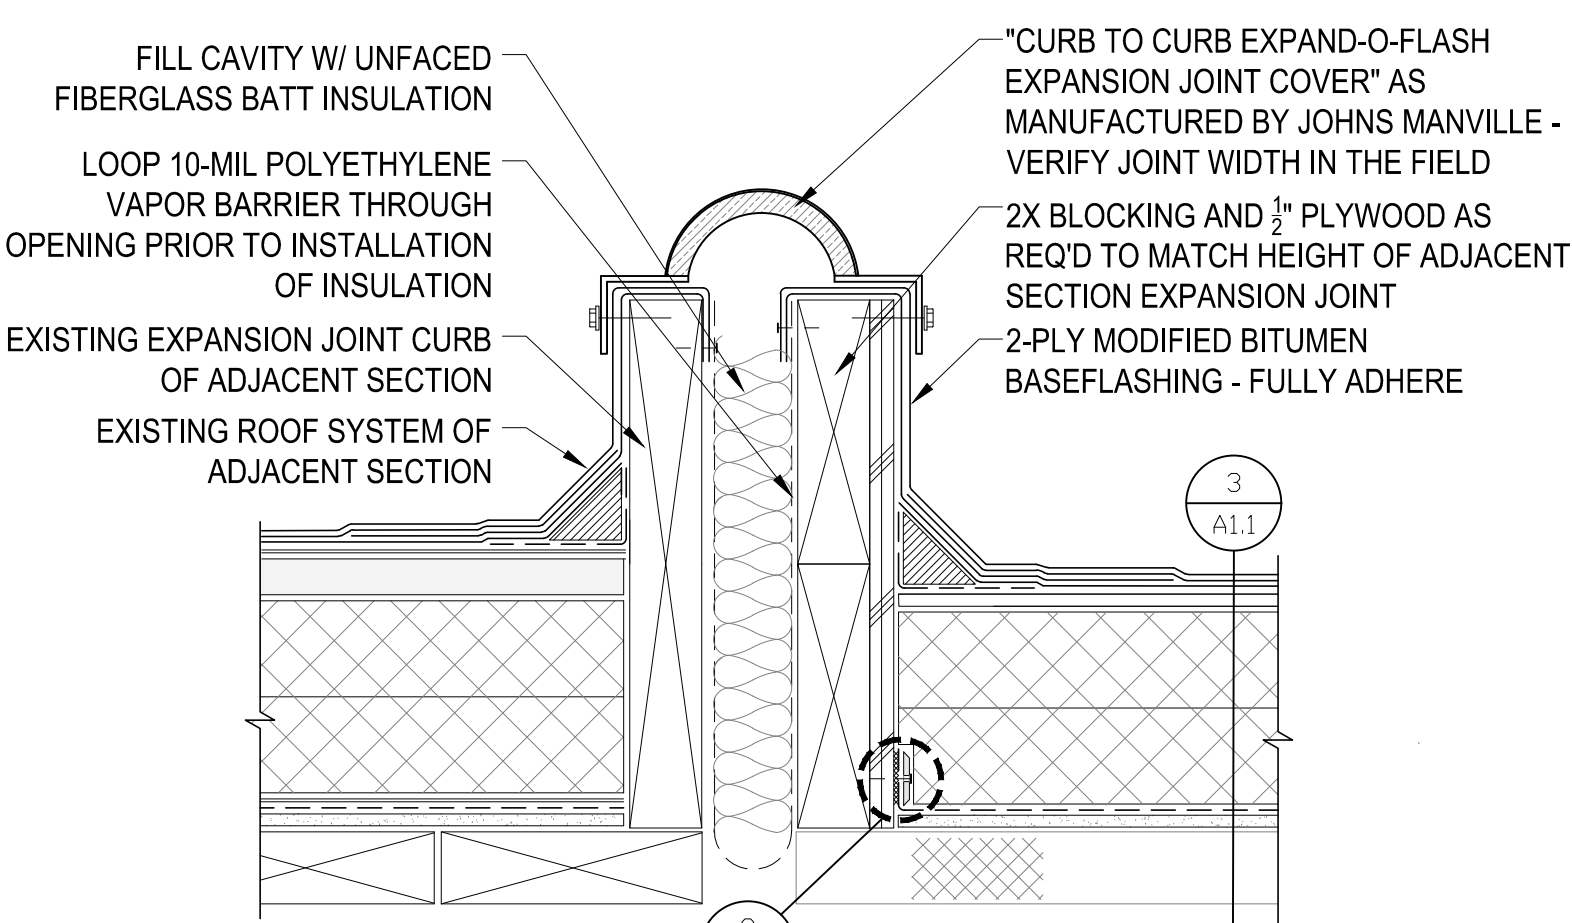

8 EXPANSION JOINT AT ADJACENT SECTION
 SCALE = 3"=1'-0"

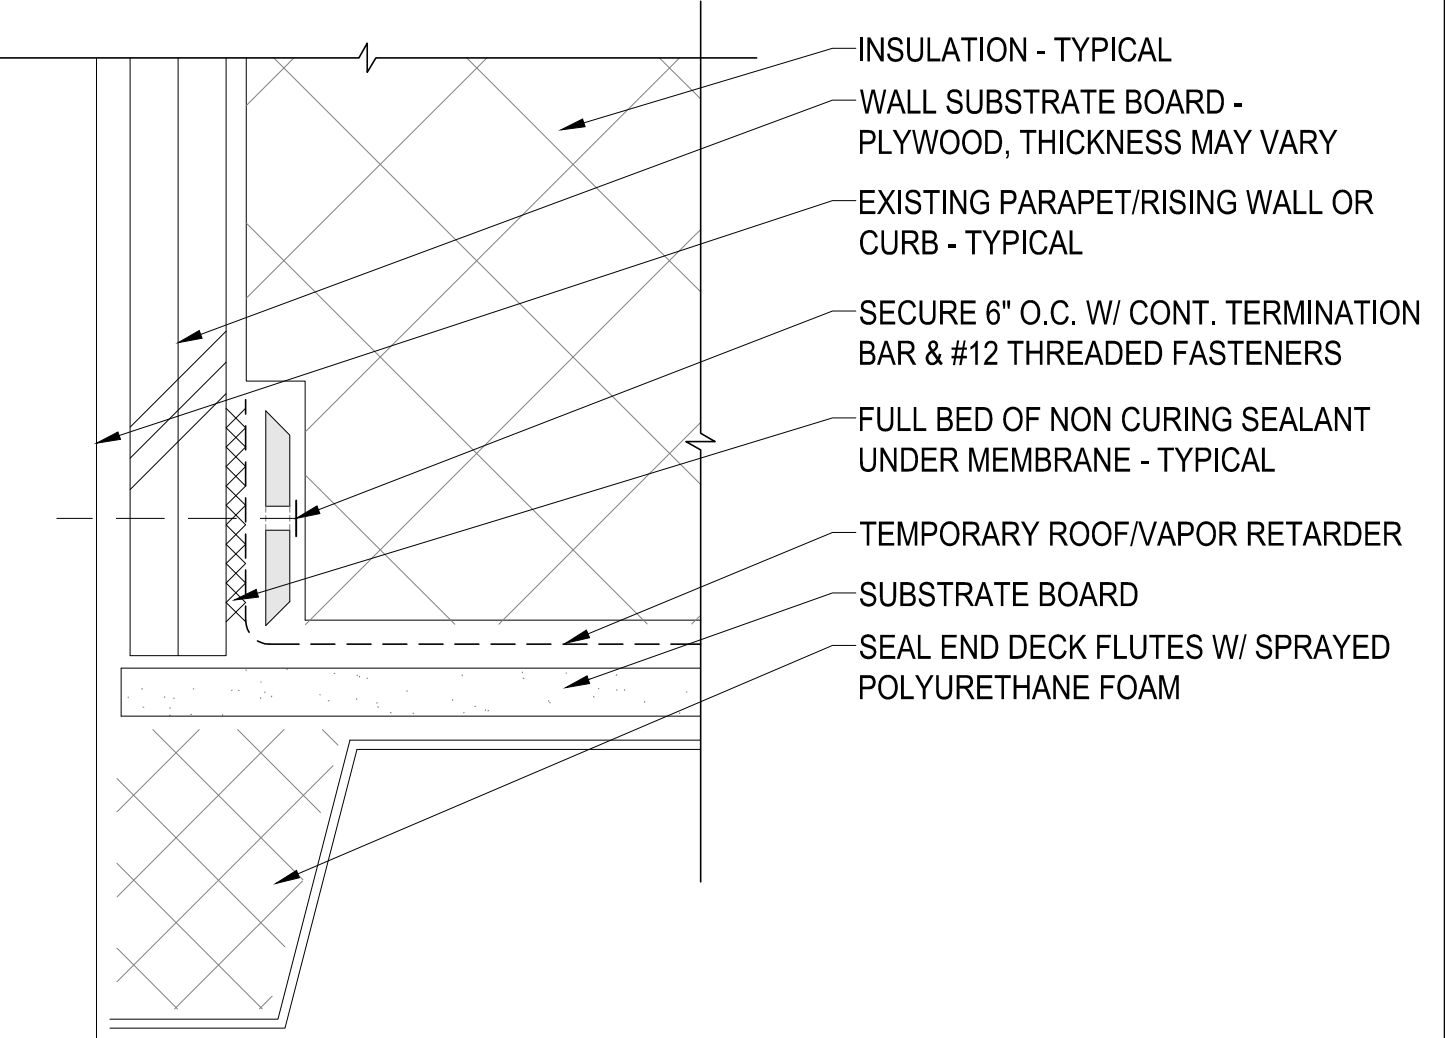

9 TYPICAL VAPOR BARRIER TERMINATION
 SCALE = NTS

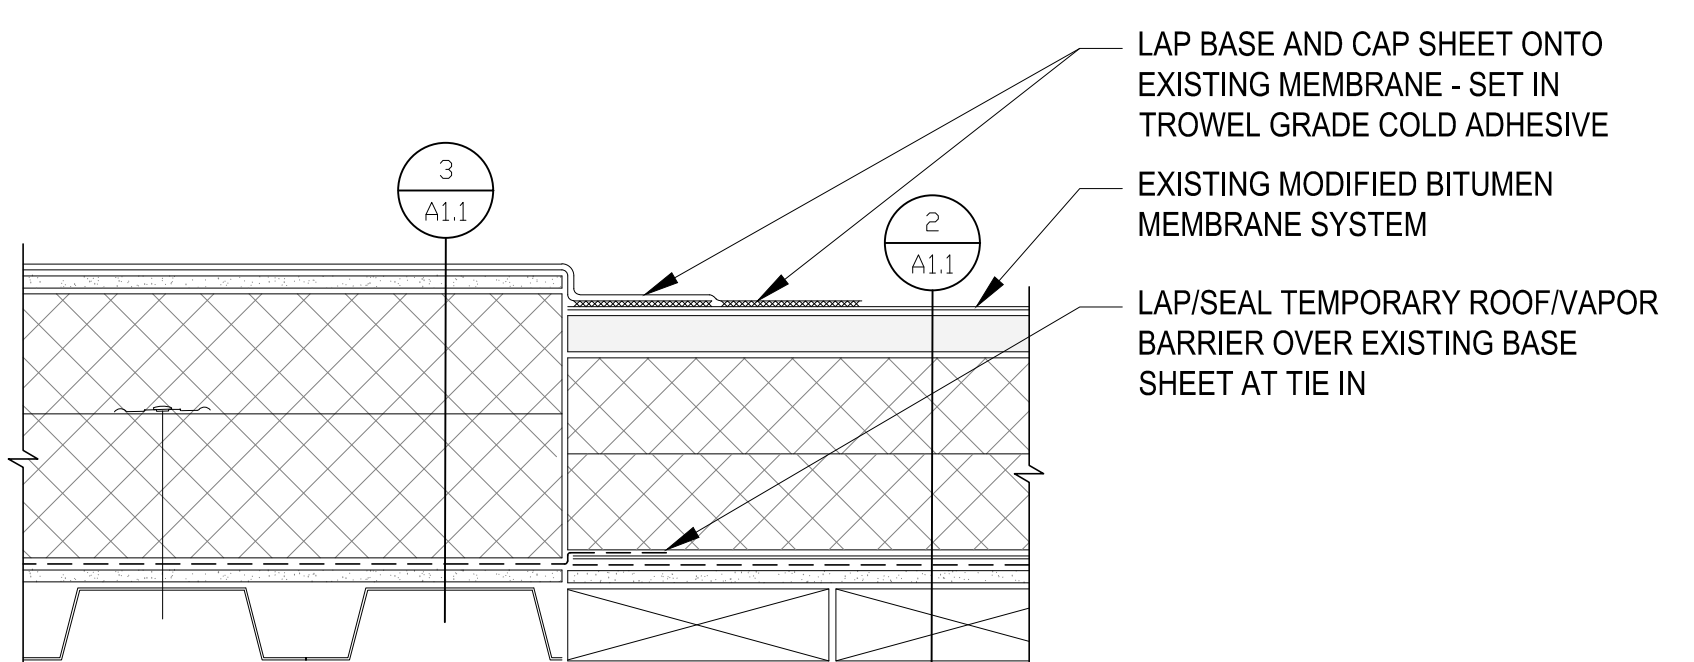


10 TIE IN AT NEW TO EXISTING ROOF
 SCALE = 3"=1'-0"

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Cushing Terrell
 ARCHITECTS
 1050 Fowler Ave. Ste. 200
 Bozeman, Montana 59718
 P: (406) 556-8800
 www.cushingterrell.com
 CUSHING TERRELL ARCHITECTS
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SHEET TITLE

SHEET A1.2

DATE 11.01.2020

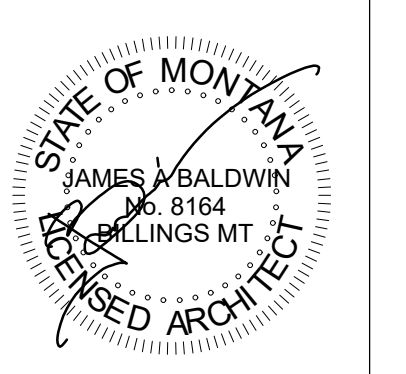

LEGEND

- └ CORNER GUARD - SEE SPECIFICATIONS
- FINISH TAG
- ◀-### FLOOR FINISH TAG
- PAINTED WALLS

ROOM FINISHES

- FLOOR FINISHES**
- C CARPET TILES
 - E EXISTING
 - SC SEALED CONCRETE

- BASE FINISHES**
- E EXISTING
 - CS CONCRETE SLAB ON GRADE

- WALL FINISHES**
- P PAINT

- MISC FINISHES**
- RT RUBBER FLOOR TRANSITION


GENERAL FINISH NOTES

- A. PROVIDE RUBBER TRANSITION STRIPS AT ALL CONCRETE AND CARPET TRANSITIONS. TRANSITION TO MATCH EXISTING.
- B. ALL TRANSITIONS TO OCCUR DIRECTLY BENEATH DOORS UNLESS OTHERWISE NOTED.
- C. ALL PRODUCTS TO BE INSTALLED PER MANUFACTURERS INSTRUCTION USING MANUFACTURERS ADHESIVES, ETC.
- D. PATCH ALL AREAS OF REMOVED FINISH.
- E. MATCH EXISTING ADJACENT WALL FINISHES AT NEW AND REMODELED WALLS.
- F. REPAINT HOLLOW METAL DOORS AND FRAMES TO MATCH EXISTING.

FINISH NOTES

1. AREA OF EXTENT OF FLOOR WORK, MATCH REPLACED FLOORING WITH EXISTING. SEE STRUCTURAL FOR SIZE EXTENT.
2. PATCH FLOOR AND TOUCH-UP WALL ONCE SHORING IS REMOVED.


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 BOZEMAN, MONTANA
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 FAX: 406.994.5665

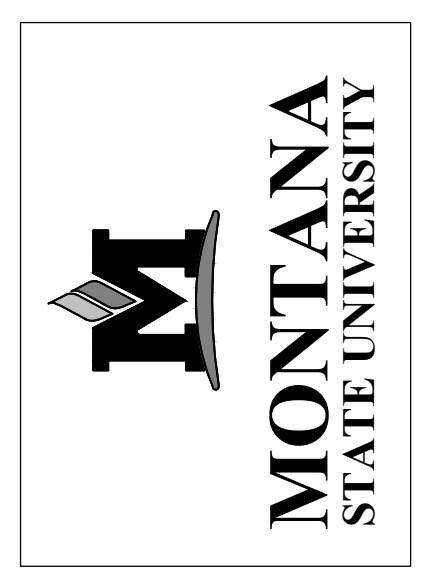DCI ENGINEERS
 1060 Fowler Ave. Ste. 200
 Bozeman, Montana 59718
 P: (406) 556-8000
 C: (406) 556-8000
 www.dci-engineers.com
 STRUCTURAL
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Project #
SHEET TITLE
 ARCHITECTURAL - FINISH PLAN

SHEET
A5.1

DATE
11.01.2020

DEMOLITION PLAN LEGEND

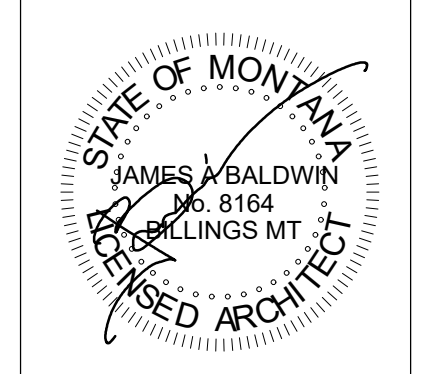- INDICATES ITEMS TO BE DEMOLISHED AND/OR REMOVED
- ① SELECTIVE DEMOTION NOTE

GENERAL DEMOLITION NOTES:

- A. THE REMOVAL/DEMOLITION NOTES LISTED ARE INTENDED TO CONVEY A GENERAL DESCRIPTION OF THE REMOVAL/DEMOLITION WORK THROUGHOUT THE PROJECT. SEE INDIVIDUAL DISCIPLINE SHEETS FOR SPECIFIC DEMOLITION WORK.
- B. WHETHER SPECIFICALLY INDICATED OR NOT, ALL ITEMS/MATERIALS/EQUIPMENT REQUIRED TO BE REMOVED OR DEMOLISHED TO COMPLETE THE WORK SHALL BE INCLUDED IN THE BID.
- C. ALL REMOVED ITEMS, EXCEPT THOSE NOTED TO BE REUSED OR TO REMAIN AS THE PROPERTY OF THE OWNER SHALL BECOME THE PROPERTY OF THE CONTRACTOR, AND SHALL BE REMOVED FROM THE JOBSITE.
- D. REFER TO COVER SHEET FOR GENERAL PROJECT NOTES.
- E. REFER TO OTHER PORTIONS OF THE CONTRACT DOCUMENTS FOR ADDITIONAL DEMOLITION REQUIREMENTS. REFER TO ASI# FOR EXTENT OF FLOOR REPAIRS. REFER TO ASI# FOR EXTENT OF CEILING REPAIRS.
- F. PROTECT THE BUILDING INTERIOR AT ALL TIMES. OUTSIDE OF WORK AREAS, PROMPTLY REPAIR DAMAGES CAUSED TO ADJACENT FACILITIES/FINISHES BY DEMOLITION OR CONSTRUCTION WORK AT NO ADDITIONAL COST TO THE OWNER. REPAIR SHALL EXTEND TO THE NEAREST INSIDE OR OUTSIDE CORNER.
- G. CONTRACTOR TO VISIT SITE AND VERIFY EXISTING CONDITIONS PRIOR TO BIDDING. CONTRACTOR IS RESPONSIBLE TO COORDINATE THEIR OBSERVATIONS WITH THESE CONTRACT DOCUMENTS. IF INCONSISTENCIES EXIST, THE CONTRACTOR SHALL INFORM THE ARCHITECT BEFORE BIDDING.
- H. PROVIDE DUST PROTECTION AS REQUIRED.
- I. THE BUILDING AND GROUNDS SHALL BE KEPT CLEAN AND FREE OF REFUSE AT ALL TIMES.
- J. DISRUPTIONS AND OUTAGES MUST BE FULLY COORDINATED WITH MSU PM A MINIMUM OF 72-HOURS IN ADVANCE. COORDINATE SCHEDULE OF DEMOLITION WORK WITH MSU TO MINIMIZE DISRUPTION OF OWNERS OPERATIONS.

DEMOLITION NOTES

1. REMOVE EXISTING UPPER GYPVITILE & LOWER ACTGRID CEILINGS AS REQUIRED TO FACILITATE WORK FOR STRUCTURAL UPGRADES - BOTH LOWER AND UPPER CEILINGS.

PLAN LEGEND

- ROOM --- ROOM NAME
- ACT --- ROOM NUMBER
- ① --- PLAN NOTE
- WALL INFILL

REFLECTED CEILING LEGEND


- ACT --- CEILING MATERIAL
- HHT --- CEILING HEIGHT
- ADDITIONAL NOTES
- 2X4 ACOUSTICAL LAY-IN CEILING
- GYPSUM BOARD CEILING
- CEILING MATERIAL
- ACT 2X4 ACOUSTICAL LAY-IN PANEL TO MATCH EXISTING
- EXST EXISTING TO REMAIN
- GYP GYPSUM BOARD - TAPE, TEXTURE, & PAINT TO MATCH EXISTING

PLAN NOTES


1. REPLACE/REPAIR DEMOD LOWER AND UPPER CEILINGS. MATERIAL COLOR AND PAINT TO MATCH EXISTING.

COORDINATION NOTE:


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1 DEMO REFLECTED CEILING PLAN
A9.1 1/8"=1'-0"

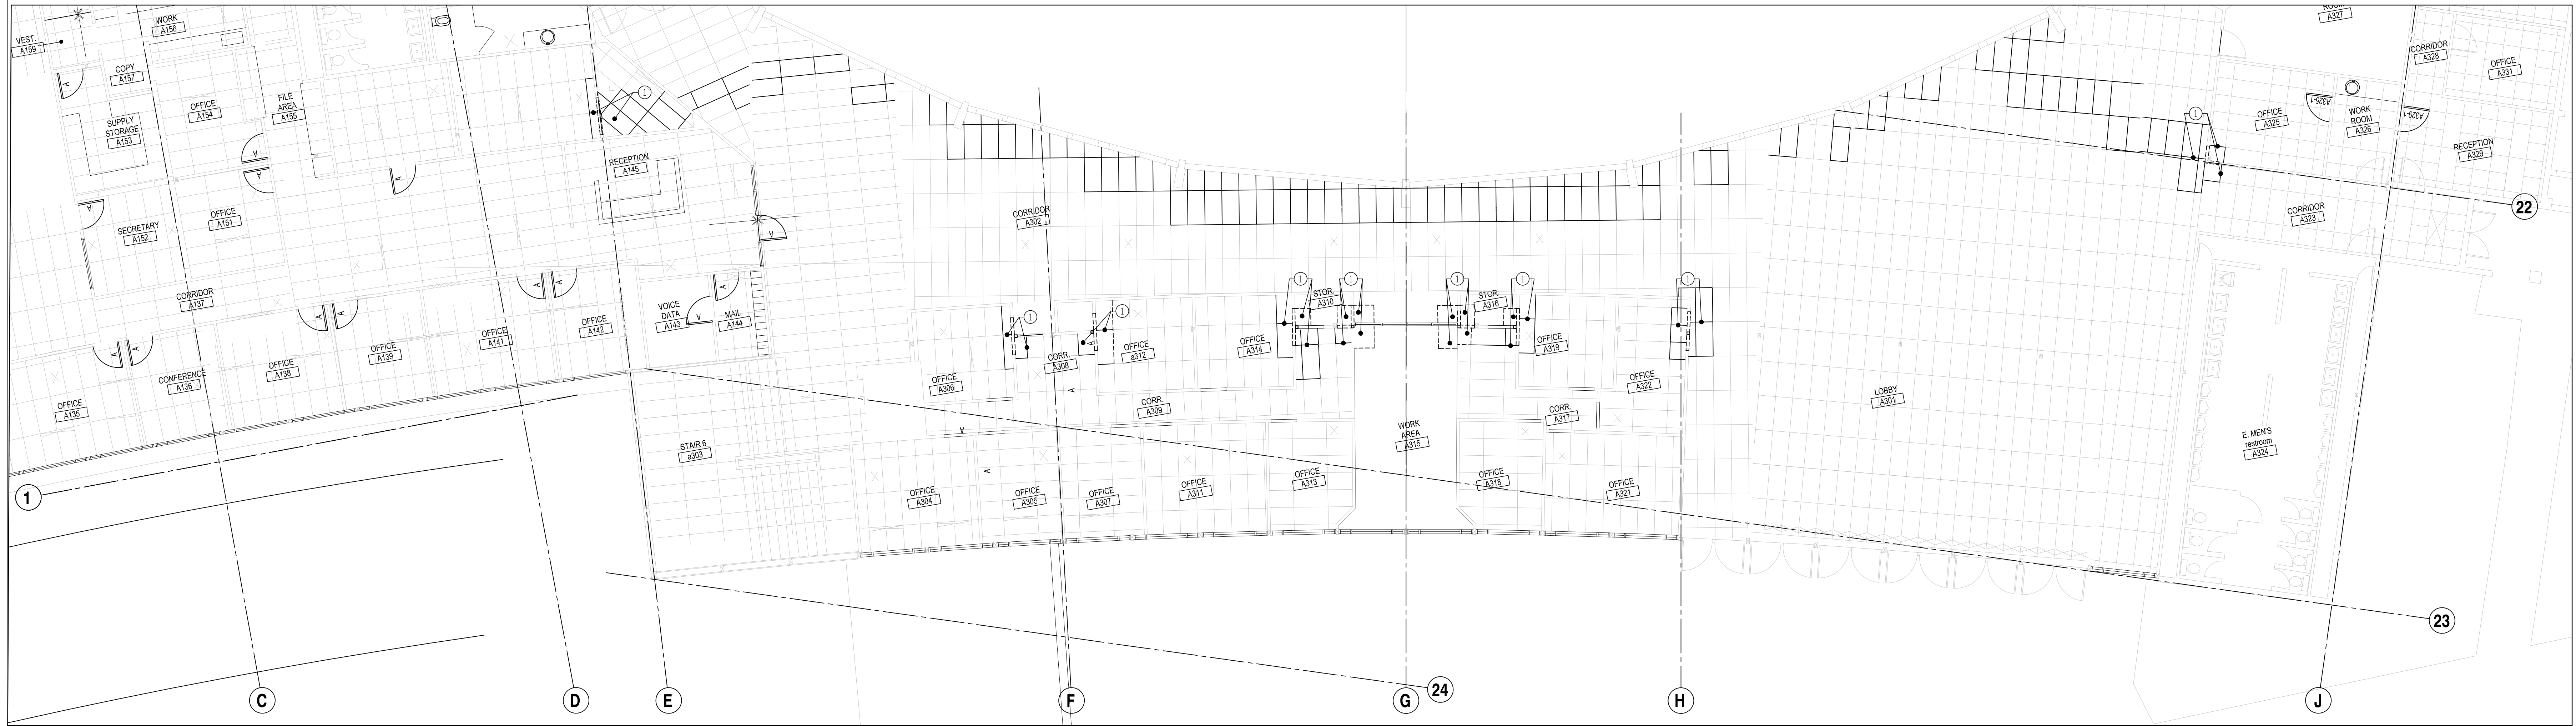


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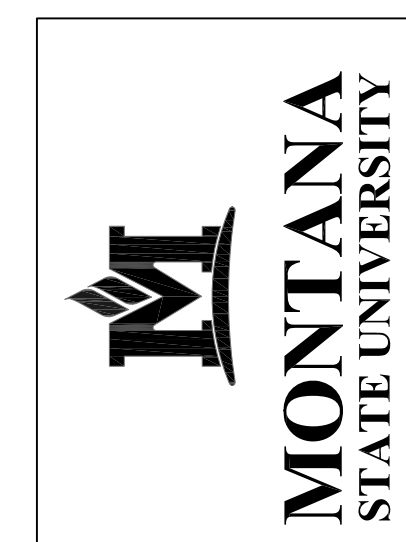
PPA# 19-0172

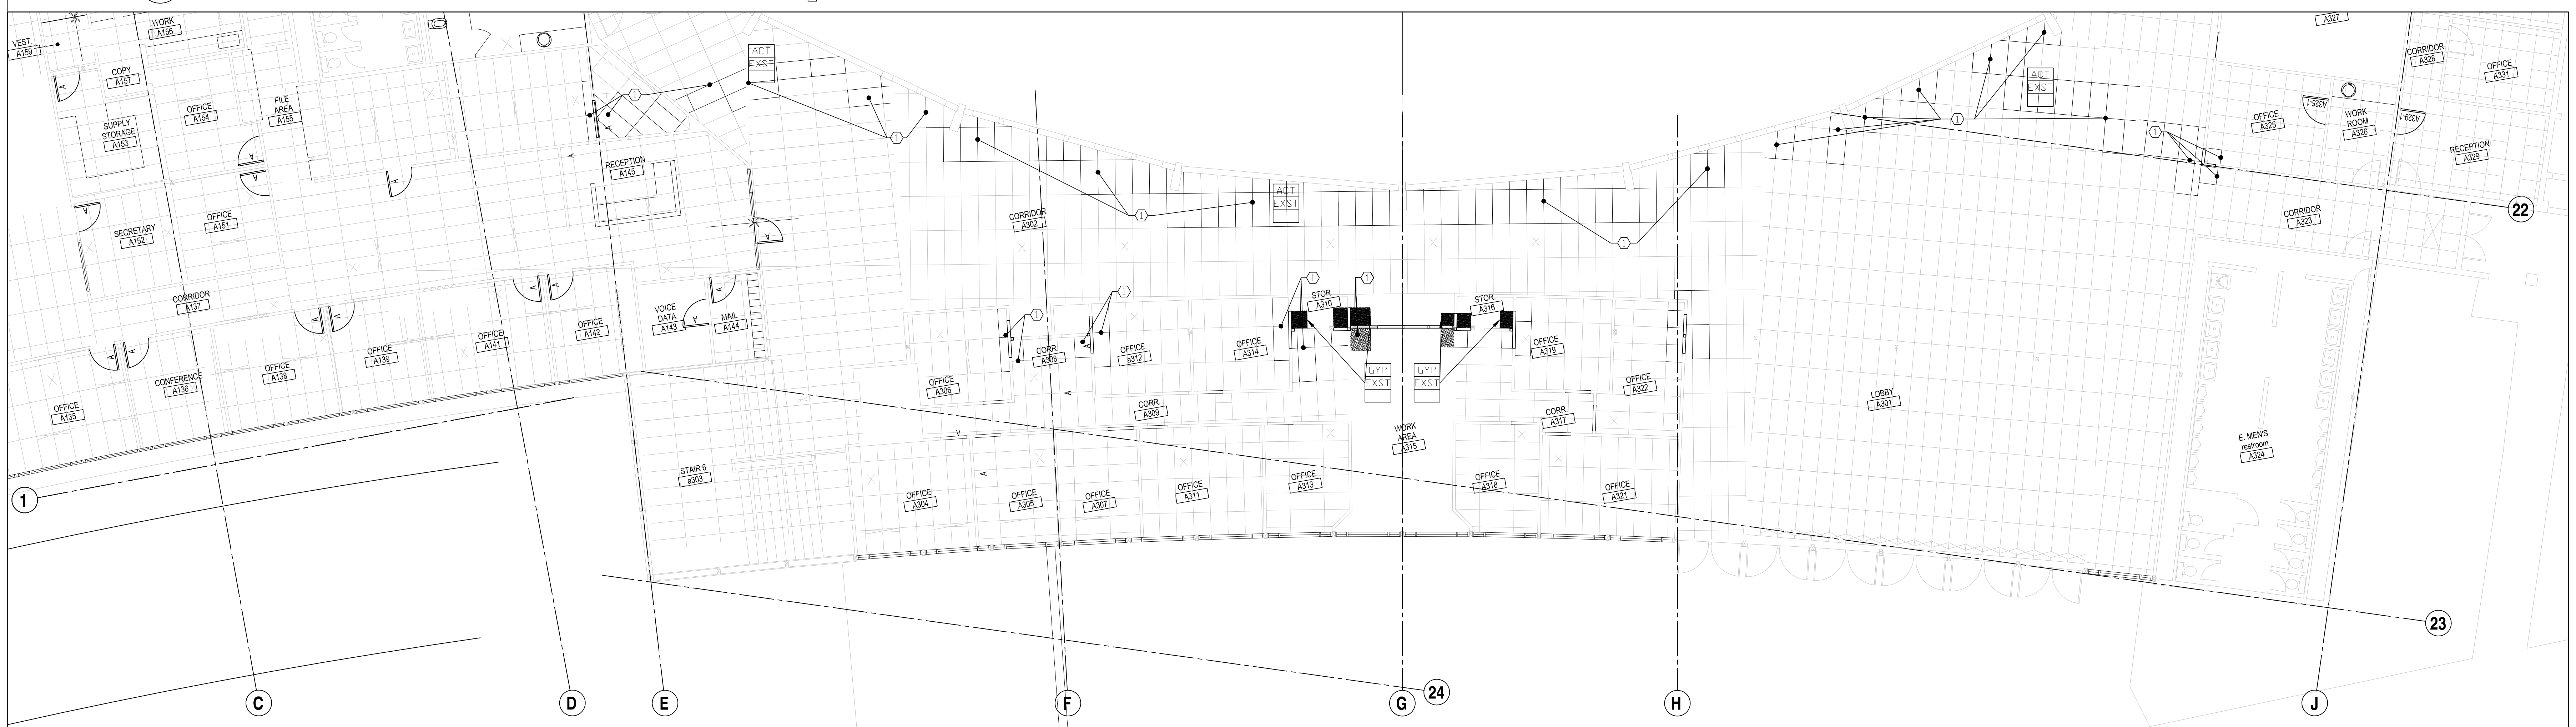Project #
SHEET TITLE
ARCHITECTURAL -
REFLECTED CEILING PLANS

SHEET
A9.1

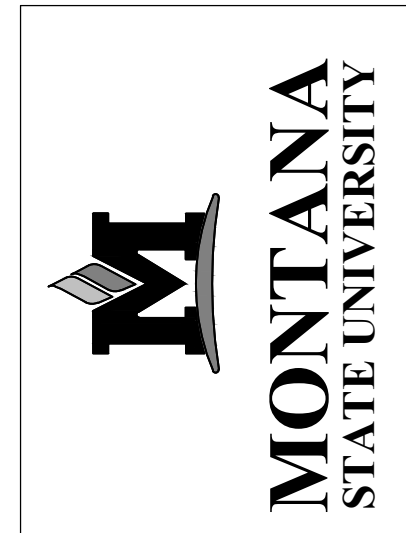DATE
11.01.2020

COORDINATION NOTE:
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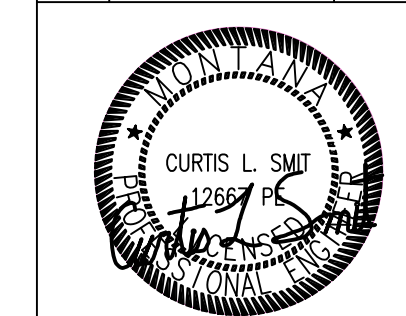
MSU-CPDC
 MONTANA STATE UNIVERSITY
 BOZEMAN, MONTANA
 PHONE: 406.994.5413
 FAX: 406.994.5665

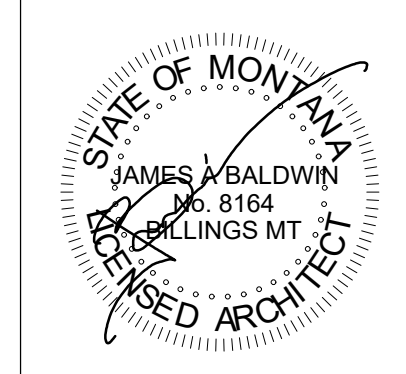EDC ENGINEER
 1080 Tower Ave, Suite 202
 Bozeman, MT 59719
 Phone: (406) 552-1000
 Fax: (406) 552-1000
 P: (406) 552-1000
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**BRICK BREEDEN
 FIELDHOUSE
 WEST ENTRY ROOF RETROFIT**

CONSTRUCTION DOCUMENTS

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REV	DESCRIPTION	DATE
SD	SCHEMATIC DESIGN	4/10/20
CD	95% REVIEW	7/28/20
CD	100% CD	11/1/20



PPA# 19-0172

CDSD #2014
SHEET TITLE
ARENA LEVEL
PLAN WEST-
PIPING
 SHEET
M1.1
 DATE
11/01/2020


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KEY NOTES

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- HWS/R PIPING TO REMAIN. PROVIDE TEMPORARY SUPPORT FOR PIPING. COORDINATE WITH GENERAL.
- REMOVE SECTION OF HWS/R PIPING TO ALLOW NEW STRUCTURAL WORK. REINSTALL PIPING AND INSULATION AFTER STRUCTURAL WORK IS COMPLETE.

ARENA LEVEL PLAN WEST - PIPING
 SCALE: 1/8" = 1'-0" (30x42 SHEETS)



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MSU-CPDC
MONTANA STATE UNIVERSITY
BOZEMAN, MONTANA
PHONE: 406.994.5413
FAX: 406.994.5665

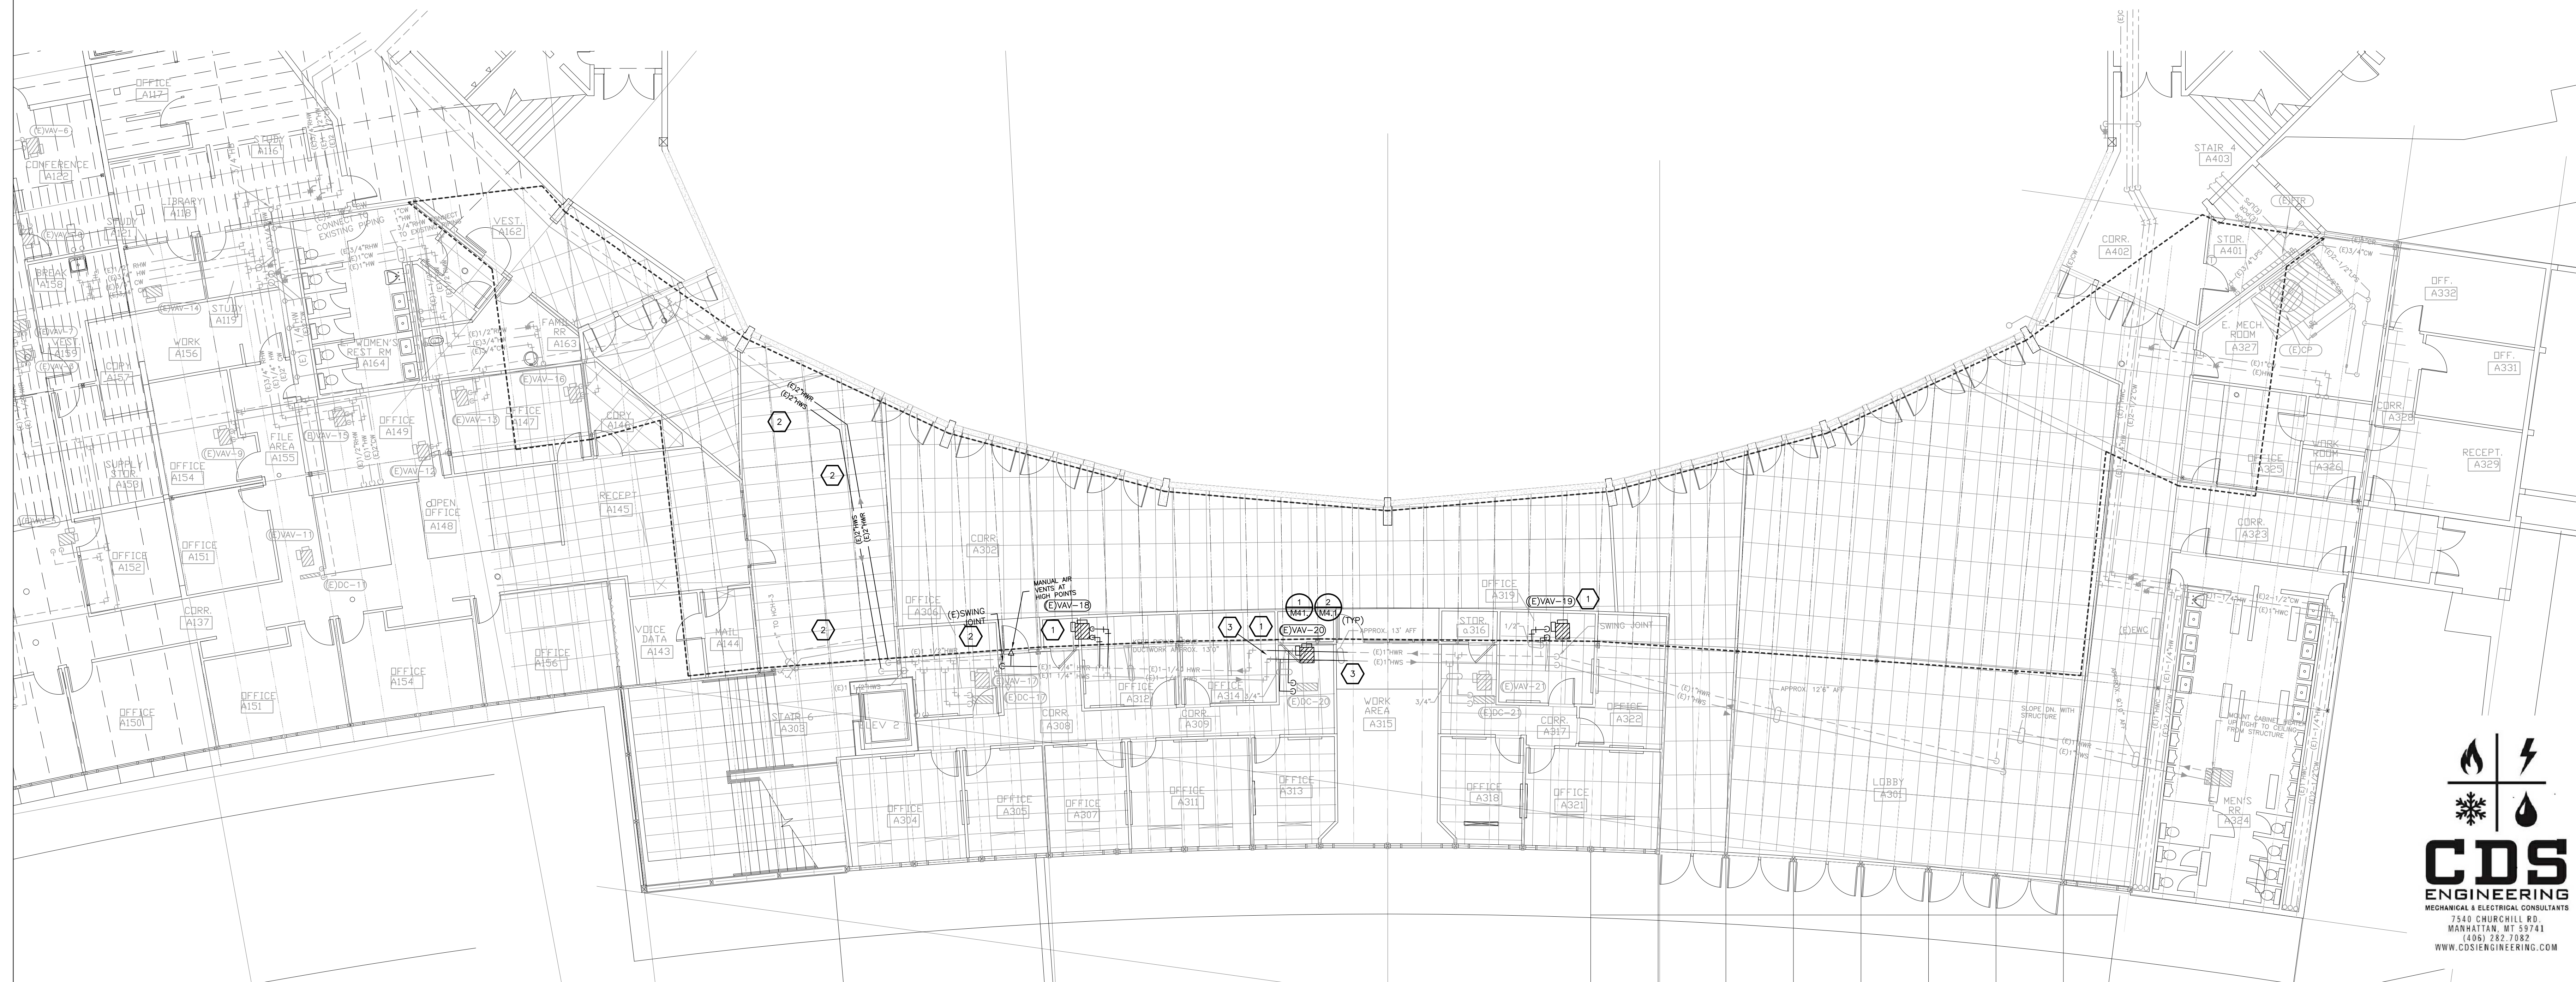IEDCI ENGINEERS
1080 Tower Ave, Suite 202
Bozeman, MT 59719
Phone: (406) 994-2200
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GENERAL NOTES

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KEY NOTES




ROOF PLAN WEST- MECHANICAL
SCALE: 1/8" = 1'-0" (30x42 SHEETS)



CONSTRUCTION DOCUMENTS

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REV	DESCRIPTION	DATE
SD	SCHEMATIC DESIGN	4/10/20
CD	95% REVIEW	7/28/20
CD	100% CD	11/1/20

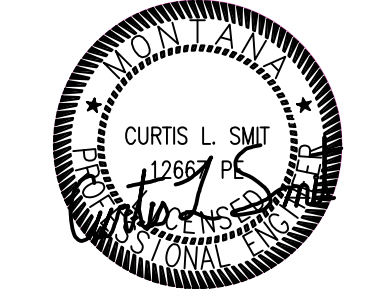

PPA# 19-0172

CDSI #2014
SHEET TITLE
ROOF PLAN WEST

SHEET
M1.2
DATE
11/01/2020



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MSU-CPDC
 MONTANA STATE UNIVERSITY
 BOZEMAN, MONTANA
 PHONE: 406.994.5413
 FAX: 406.994.5665



**BRICK BREEDEN
 FIELDHOUSE
 WEST ENTRY ROOF RETROFIT**


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KEY NOTES


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- SECTIONS OF DUCTWORK ARE SHOWN IN WORK AREA. BRACE/SUPPORT DUCTWORK THROUGHOUT STRUCTURAL WORK. WORK INCLUDES DUCTS, DIFFUSERS, FLEX DUCT, AND DUCT ACCESSORIES.
- VAV BOX AND COIL TO BE REMOVED AND REINSTALLED TO ALLOW FOR NEW STRUCTURAL COLUMN. SEE GENERAL NOTE 5 (ABOVE) FOR CONTROL REQUIREMENTS.
- REMOVE SECTIONS OF DUCTWORK TO ALLOW WORK AT COLUMN. REINSTALL/REPLACE SECTIONS AT COMPLETION OF WORK.

ARENA LEVEL PLAN WEST - HVAC
 SCALE: 1/8" = 1'-0" (30x42 SHEETS)



CONSTRUCTION DOCUMENTS
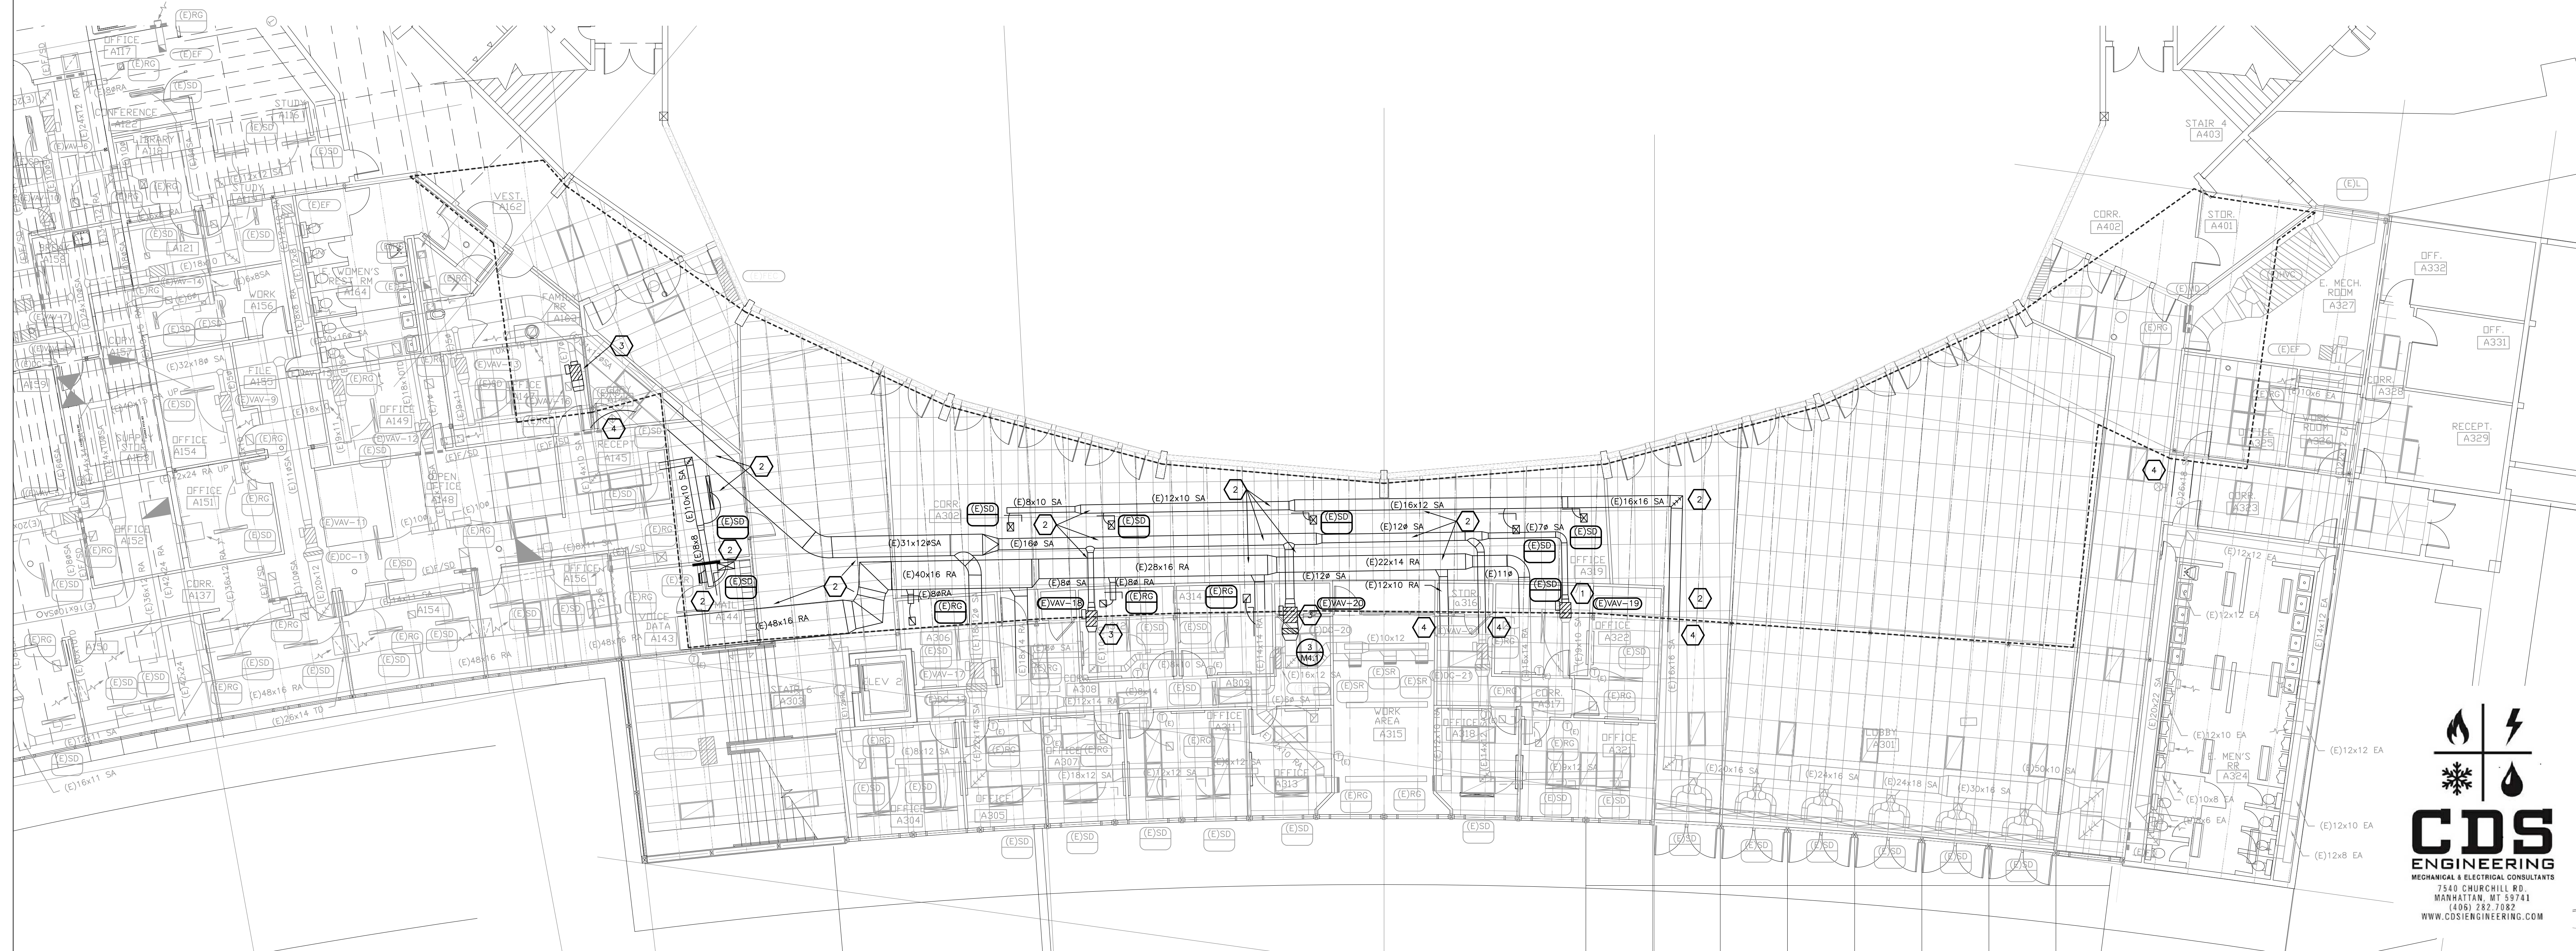
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REV 1	SCHEMATIC DESIGN	4/10/20
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CD	100% CD	11/1/20

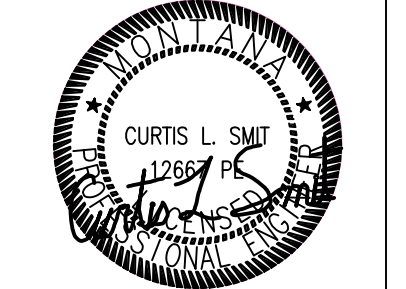

CDSI #2014
SHEET TITLE
 ARENA LEVEL
 PLAN WEST- HVAC

SHEET
M2.1
DATE
 11/01/2020



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MSU-CPDC
 MONTANA STATE UNIVERSITY
 BOZEMAN, MONTANA
 PHONE: 406.994.5413
 FAX: 406.994.5665



**BRICK BREEDEN
 FIELDHOUSE
 WEST ENTRY ROOF RETROFIT**

GENERAL NOTES

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- COORDINATE FIRE SPRINKLER WORK AND SYSTEM SHUT DOWN WITH CAMPUS SAFETY AND RISK. PROVIDE ALL NECESSARY WORK TO PROVIDE FOR THE SAFETY OF THE BUILDING DURING THE SYSTEM DOWN TIMES INCLUDING FIRE WATCH, DRAIN AND RECHARGE SYSTEM EACH DAY TO PROVIDE OPERATIONAL SYSTEM DURING NON-WORKING HOURS.

KEY NOTES


- SHORE/SUPPORT EXISTING FIRE SPRINKLER SYSTEM DURING CONSTRUCTION.
- REMOVE UPRIGHT FIRE SPRINKLER HEAD INTO ATTIC WHERE SHOWN. ALLOW INSTALLATION OF STRUCTURE. PROVIDE NEW AND/OR RELOCATE HEAD AS REQUIRED FOR NEW STRUCTURAL WORK.

ARENA LEVEL PLAN WEST - FIRE SPRINKLER
 SCALE: 1/8" = 1'-0" (30x42 SHEETS)



CONSTRUCTION DOCUMENTS

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CD	100% CD	11/1/20

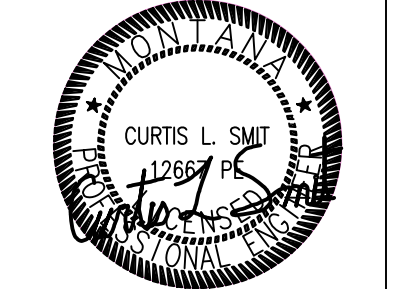

PPA# 19-0172



CDI #2014
SHEET TITLE
ARENA LEVEL
PLAN WEST-FIRE
SPRINKLER
 SHEET
M3.1
 DATE
11/01/2020

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MSU-CPDC
MONTANA STATE UNIVERSITY
BOZEMAN, MONTANA
PHONE: 406.994.5413
FAX: 406.994.5665



**BRICK BREEDEN
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WEST ENTRY ROOF RETROFIT**

CONSTRUCTION DOCUMENTS

MECHANICAL LEGEND (NOT ALL SYMBOLS ARE USED ON THIS PROJECT)

—CW— DOMESTIC COLD WATER	—HW— DOMESTIC HOT WATER	—RHW— DOMESTIC HOT RECIRC	—W— WATER SERVICE	—FS— FIRE SERVICE	—G— NATURAL GAS (7" W.C.)	—SS— BELOW GRADE SANITARY SEWER	—AS— ABOVE GRADE SANITARY SEWER	—V— SANITARY VENT	—BS— BELOW GRADE STORM	—AS— ABOVE GRADE STORM	—STO— STORM OVERFLOW	—CD— CONDENSATE DRAIN	—AUX— AUXILIARY CONDENSATE DRAIN	—HWS— HEATING WATER SUPPLY	—HWR— HEATING WATER RETURN	—A— SECTION TAG DESIGNATION AND SHEET LOCATION	—M2.1— DETAIL TAG DESIGNATION AND SHEET LOCATION	—EQUIPMENT AND EQUIPMENT TAG	—SG-1 200— DIFFUSER TAG AND OUTLET AIRFLOW (CFM)																																
—GATE VALVE	—BALL VALVE	—BUTTERFLY VALVE	—CHECK VALVE	—DOUBLE CHECK VALVE	—REDUCED PRESSURE BACKFLOW	—GAS VALVE	—PRESSURE REDUCING VALVE	—THREE-WAY CONTROL VALVE	—TWO-WAY CONTROL VALVE	—STRAINER	—BALANCING VALVE	—TEMP/PRESSURE RELIEF VALVE	—PRESSURE GAUGE	—TEMPERATURE GAUGE	—PETE'S PLUG	—UNION	—PIPE TURN DOWN	—PIPE RISE	—PIPE BOTTOM CONNECTION	—PIPE TOP CONNECTION	—PIPE CONNECTION	—PIPE CAP	—PIPE END CLEANOUT	—FLOOR DRAIN	—ROOF DRAIN	—PLUMBING FIXTURE & LABEL	—WC-1	—POINT OF CONNECTION TO EXISTING PIPING - FIELD VERIFY EXACT SIZE AND LOCATION	—FIRE SPRINKLER HEAD	—SIDEWALL HEAD	—UPRIGHT HEAD	—PENDENT HEAD	—SUPPLY DUCT DROP	—SUPPLY DUCT DOWN TO NEXT FLOOR	—SUPPLY UP TO NEXT FLOOR	—RETURN/EXHAUST DUCT DROP	—RETURN/EXHAUST DUCT DOWN TO NEXT FLOOR	—RETURN/EXHAUST UP TO NEXT FLOOR	—RETURN/EXHAUST DUCT RISE	—DUCT SIZE - FIRST NUMBER INDICATES DUCT WIDTH, NET INTERIOR SIZE INCREASE FOR DUCT LINER	—INDICATES ROUND DUCTWORK	—FLEXIBLE DUCT CONNECTION	—DUCT OFFSET DROP	—DUCT OFFSET RISE	—DUCT TRANSITION	—SQUARE TO ROUND TRANSITION	—VOLUME DAMPER, MOTORIZED DAMPER	—FIRE, SMOKE AND FIRE/SMOKE DAMPER	—DUCT TURN WITH R EQUAL TO DA (MINIMUM)	—DUCT TURN WITH SINGLE TURNING VANES, SPACING LESS THAN 3", RADIUS GREATER THAN 4"	—THERMOSTAT AND UNIT SERVED


ABBREVIATIONS

ADA AMERICANS W/ DISABILITIES	(E) EXISTING TO REMAIN	HWL HEATING WATER	SA SUPPLY AIR
AD ACT COMPLIANT EQUIPMENT	EA EXHAUST AIR	(GLYCOL) RETURN	SD SMOKE DAMPER
AFF ABOVE FINISHED FLOOR	EF EXHAUST FAN	L-## LAVATORY	SD/SG SUPPLY DIFFUSER/GRILLE
AHU AIR HANDLING UNIT	EG-## EXHAUST GRILLE	MANUF MANUFACTURER	SF SUPPLY FAN
BDD BACK DRAFT DAMPER	ELECT ELECTRICAL	1000 BTU/HR	SH SHOWER
BS/BSU BRANCH SELECTOR UNIT	FCC FLOOR CLEANOUT	MECH MECHANICAL	SK SINK
CA CLEANOUT	FC/FCU FAN COIL UNIT	MS MOP SINK	SS SANITARY SEWER
CONT CONTINUATION	FD FLOOR DRAIN	(N) NEW	ST STORM SEWER
CW DOMESTIC COLD WATER	FD/SD FIRE/SMOKE DAMPER	OA OUTSIDE AIR	TC TEMPERATURE CONTROL
CWS CHILLED WATER	FE FIRE EXTINGUISHER	ON CENTER	TG TRANSFER GRILLE
(GLYCOL SUPPLY)	FS FLOOR SINK	PRV PRESS. REDUCING VALVE	TYP TYPICAL
CWR CHILLED WATER	HB HOSE BIB	(R) REMOVE AND RELOCATE	UR URINAL
(GLYCOL RETURN)	HP/HPU HEAT PUMP UNIT	RD ROOF DRAIN	V SANITARY VENT
DDC DIRECT DIGITAL CONTROL	HW DOMESTIC HOT WATER	RA RETURN AIR	VTR VENT THROUGH ROOF
DF DRINKING FOUNTAIN	HWS HEATING WATER (GLYCOL) SUPPLY	RG-## RETURN GRILLE	WC WATER CLOSET
			WCO WALL CLEANOUT
			(X) EXISTING TO BE REMOVED


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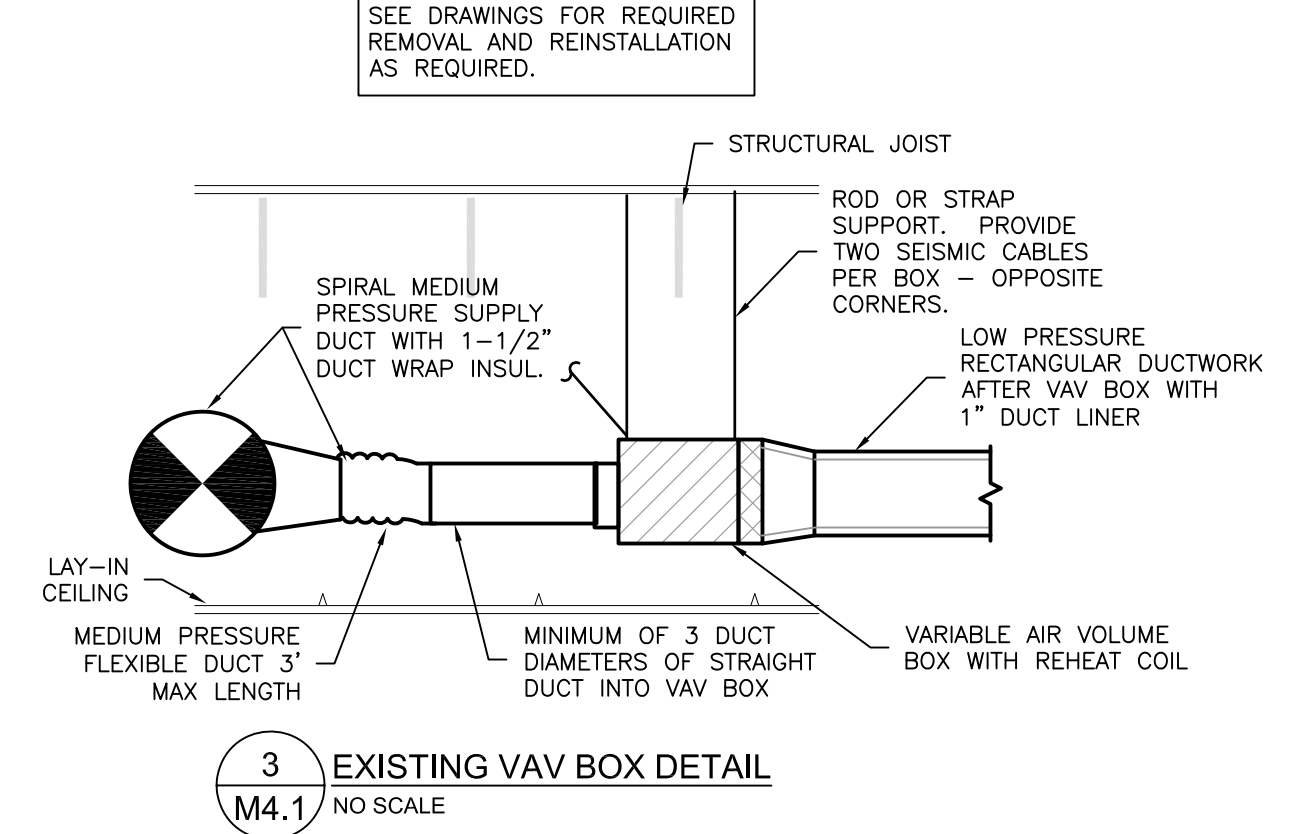
PIPE SIZE LEADER



1 PIPE HANGER DETAIL
M4.1 NO SCALE

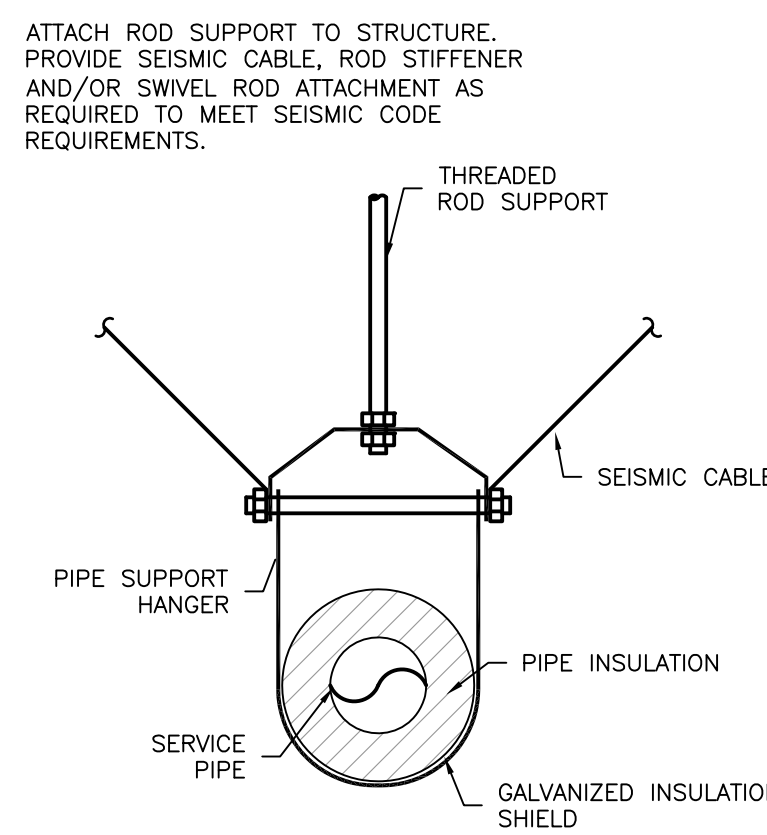

2 EXISTING TWO WAY COIL DETAIL
M4.1 NO SCALE

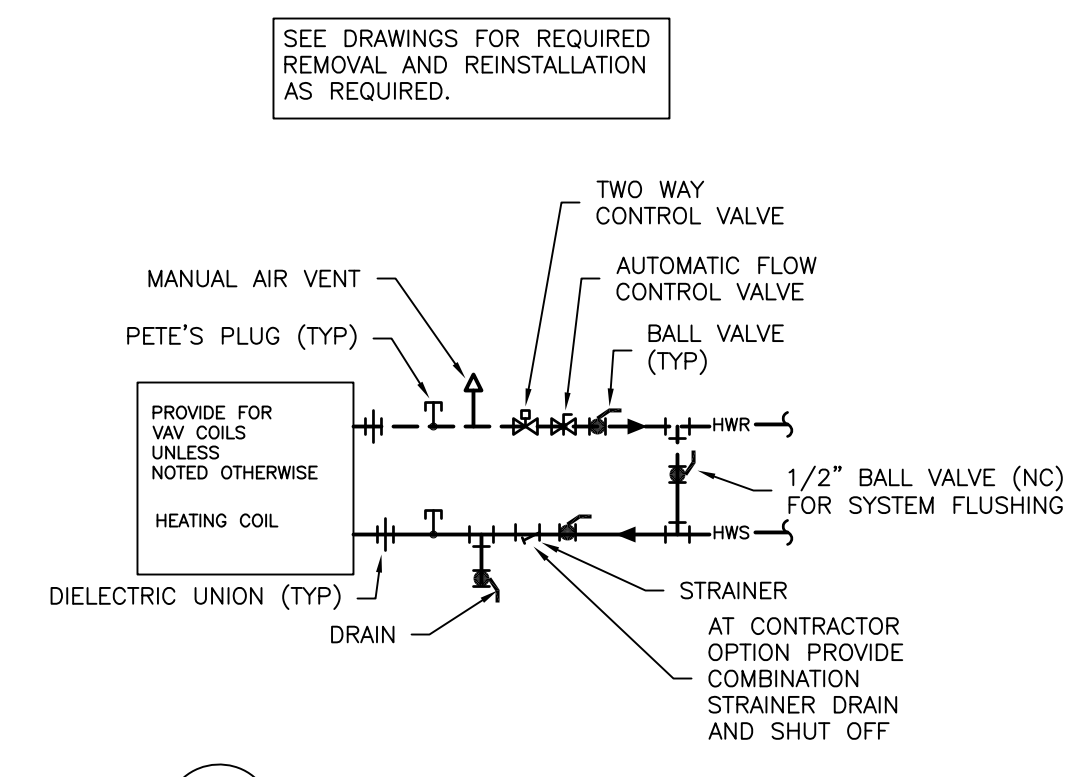


3 EXISTING VAV BOX DETAIL
NO SCALE

**MECHANICAL DETAILS, SCHEDULES AND LEGEND
NOT TO SCALE (30x42 SHEETS)**



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REV	DESCRIPTION	DATE
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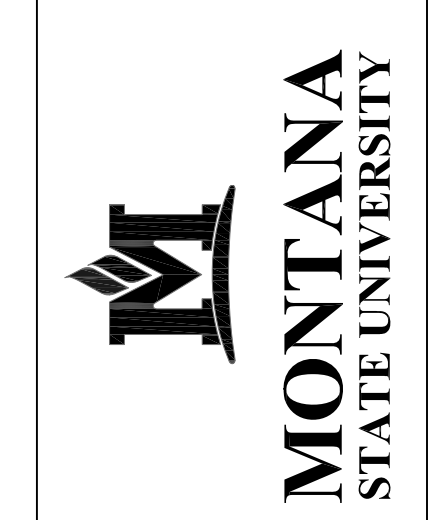
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**SHEET TITLE
MECHANICAL DETAILS,
SCHEDULES AND
LEGEND**

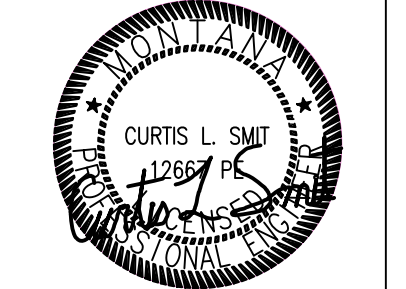SHEET

M4.1

DATE
11/01/2020



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MONTANA STATE UNIVERSITY
BOZEMAN, MONTANA
PHONE: 406.994.5413
FAX: 406.994.5665




1000 Power Ave, Suite 202
Bozeman, Montana 59719
Phone: (406) 552-5000
Fax: (406) 552-5000
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BRICK BREEDEN FIELDHOUSE WEST ENTRY ROOF RETROFIT

CONSTRUCTION DOCUMENTS

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CD	REVIEW	11/1/20
CD	100% CD	11/1/20

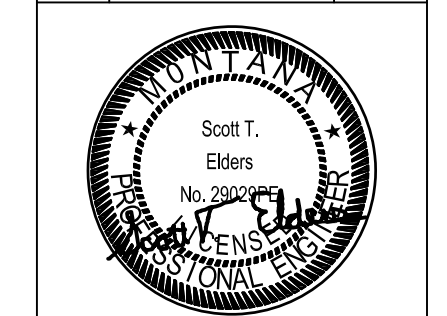

PPA# 19-0172

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SHEET TITLE
ARENA LEVEL PLAN WEST - POWER

SHEET
E1.1

DATE
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ELECTRICAL LEGEND (NOT ALL SYMBOLS ARE USED ON THIS PROJECT)

	2'x4' RECESSED LIGHT FIXTURE		DUPLEX RECEPTACLE		BRANCH CIRCUIT CONCEALED IN WALL OR CEILING
	1'x4' RECESSED LIGHT FIXTURE		HORIZONTALLY MOUNTED DUPLEX RECEPTACLE		LOW VOLTAGE CABLING
	2'x2' RECESSED LIGHT FIXTURE		30A DRYER RECEPTACLE		EMPTY CONDUIT - 3/4\"/>
	2'x4' SURFACE MOUNT LIGHT FIXTURE		50A RANGE RECEPTACLE		HOME RUN TO PANEL - NUMBER OF ARROWS INDICATES NUMBER OF CIRCUITS
	1'x4' SURFACE MOUNT LIGHT FIXTURE		QUADRUPLEX RECEPTACLE		NUMBER OF HASHMARKS INDICATES NUMBER OF CONDUCTORS, NO HASHMARKS INDICATES TWO CONDUCTORS, HASHMARKS NOT SHOWN FOR GROUND WIRES
	4' INDUSTRIAL STRIP LIGHT FIXTURE		CEILING MOUNTED RECEPTACLE		FIRE ALARM MANUAL PULL STATION
	SUSPENDED LINEAR LIGHT FIXTURE		INDICATES GROUND FAULT INTERRUPTER DEVICE		FIRE ALARM HORN/STROBE - WALL MOUNTED
	WALL MOUNT LIGHT FIXTURE		FLOOR RECEPTACLE - COMBINATION POWER/DATA		FIRE ALARM STROBE - WALL MOUNTED
	RECESSED DOWNLIGHT		POWER DIRECT CONNECTION		FIRE ALARM HORN - WALL MOUNTED
	CEILING MOUNTED EXIT SIGN, ARROWS SHOWN SHALL BE PROVIDED ON EXIT SIGN INSTALLED		POWER MOTOR CONNECTION		FIRE ALARM HORN/STROBE - CEILING MOUNTED
	SINGLE POLE TOGGLE SWITCH		ELECTRICAL PANEL - 208Y/120V 3 PHASE 4 WIRE		FIRE ALARM STROBE - CEILING MOUNTED
	THREE-WAY TOGGLE SWITCH		JUNCTION BOX - MINIMUM OF 4\"/>		FIRE ALARM HEAT DETECTOR
	FOUR-WAY TOGGLE SWITCH		COMBINATION VOICE/DATA OUTLET - NUMBER INDICATES HOW MANY CATEGORY CABLES ARE TO BE TERMINATED AT THE OUTLET		FIRE ALARM DUCT SMOKE DETECTOR
	DIMMER SWITCH		VOICE OUTLET - NUMBER INDICATES HOW MANY CATEGORY CABLES ARE TO BE TERMINATED, WITH MALE CONNECTORS, AT THE DEVICE		FIRE ALARM CONTROL PANEL (FACP)
	KEYED TOGGLE SWITCH		WIRELESS ACCESS POINT - NUMBER INDICATES HOW MANY CATEGORY CABLES ARE TO BE TERMINATED, WITH MALE CONNECTORS, AT THE DEVICE		FIRE ALARM REMOTE ANNUCIATOR (FARA)
	MOTOR TOGGLE SWITCH		CARD READER ROUGH-IN		FIRE ALARM RELAY
	MOMENTARY-CONTACT SWITCH				FIRE ALARM MAGNETIC DOOR HOLD
	OCCUPANCY SENSOR - DUAL TECHNOLOGY				
	OCCUPANCY SENSOR POWER PACK				

MOUNTING HEIGHTS

DESCRIPTION	HEIGHT
RECEPTACLES (WALL)	18" A.F.F. TO CENTER
RECEPTACLES (ABOVE COUNTER)	44" A.F.F. TO CENTER
RECEPTACLES (UNFINISHED AREA)	44" A.F.F. TO CENTER
LIGHT SWITCHES	44" A.F.F. TO CENTER
VOICE/DATA OUTLET	18" A.F.F. TO CENTER
EXIT SIGN	CENTER ON DOOR, 12" ABOVE DOOR
FIRE ALARM PULL STATION	44" A.F.F. TO CENTER
FIRE ALARM HORN/STROBE	80" A.F.F. TO BOTTOM OR 6" BELOW CEILING
CARD READERS	44" A.F.F. TO CARD SLOT
SECURITY SYSTEM CONTROLS	44" A.F.F. TO CENTER
THERMOSTATS/ HVAC CONTROLS	48" A.F.F. TO CENTER
ELECTRICAL PANELS	72" A.F.F. TO TOP
SAFETY SWITCHES/MOTOR STARTER/ VFD'S	72" A.F.F. TO TOP (EXCEPT TOP OF HANDLE SHALL NOT EXCEED 78" A.F.F.)
MOTOR CONTROL PUSHBUTTONS	60" A.F.F. TO CENTER

SUBSCRIPT "AC" BESIDE RECEPTACLES DENOTES THAT RECEPTACLE IS TO BE INSTALLED WITH BOTTOM OF BOX TWO INCHES ABOVE THE COUNTERTOP OR BACKSPLASH. COORDINATE WITH THE GENERAL CONTRACTOR AND THE CASEWORK SUPPLIER.


ABBREVIATIONS (CONTINUED)

(E)	EXISTING TO REMAIN.
(N)	NEW DEVICE IN NEW LOCATION. PROVIDE CONDUIT AND CONDUCTORS AS REQUIRED TO SUPPORT THE ELECTRICAL DEVICE IN THE NEW LOCATION.
(RL)	REMOVE DEVICE, REPLACE WITH NEW DEVICE AND INSTALL IN NEW LOCATION AND/OR HEIGHT. RECONFIGURE CONDUIT AND CONDUCTORS AS REQUIRED TO SUPPORT THE NEW LOCATIONS.
(RP)	REMOVE DEVICE, REPLACE WITH NEW DEVICE IN THE EXISTING LOCATION.
(X)	REMOVE DEVICE, CONDUIT AND CONDUCTORS BACK TO THE SOURCE. RE-CONFIGURE THE EXISTING CIRCUITS TO SUPPORT THE ELECTRICAL DEVICES TO REMAIN.

ABBREVIATIONS


AC	ABOVE COUNTER	(E)	EXISTING TO REMAIN	LTS	LIGHTS	(R)	REMOVE AND RELOCATE
ADA	AMERICANS W/ DISABILITIES ACT COMPLIANT EQUIPMENT	ET	EXHAUST FAN	ELECT	ELECTRICAL	SCH	SCHEDULE
AD	ACCESS DOOR	EPO	EMERGENCY POWER OFF	EMC	ELECTRIC WATER COOLER	MD	MAIN DISTRIBUTION BOARD
AF	ABOVE FINISHED FLOOR	FCCU	FLOOR CLEANOUT	FDC	FLOOR CLEANOUT	MFR	MANUFACTURER
AHU	AIR HANDLING UNIT	FCU	FAN COIL UNIT	FD	FLOOR DRAIN	MLO	MAIN LUGS ONLY
BKR, CB	CIRCUIT BREAKER	FD	FIRE DAMPER	FD/SD	FIRE/SMOKE DAMPER	(N)	NEW
CLNG	CEILING	FE	FIRE EXTINGUISHER	FS	FLOOR SINK	NEC	NATIONAL ELECTRICAL CODE
CONT	CONTINUATION	OTCL, GF	GROUND FAULT CIRCUIT INTERRUPTER	OD, O.D.	OUTSIDE DIAMETER	NL	NIGHT LIGHT
DDC	DIRECT DIGITAL CONTROL	GND	GROUND	NO	NUMBER	NO	NUMBER
DF	DRINKING FOUNTAIN	H.O.	HIGH OUTPUT	POS	POINT OF SALE (CASH REGISTER)	WP	WEATHER-RESISTANT
DISC	DISCONNECT SWITCH	IC	INSULATED GROUND			WR	WEATHER-RESISTANT
E.C., EC	ELECTRICAL CONTRACTOR					(X)	EXISTING TO BE REMOVED

ARENA LEVEL PLAN WEST - POWER
SCALE: 1/8" = 1'-0" (30x42 SHEETS)

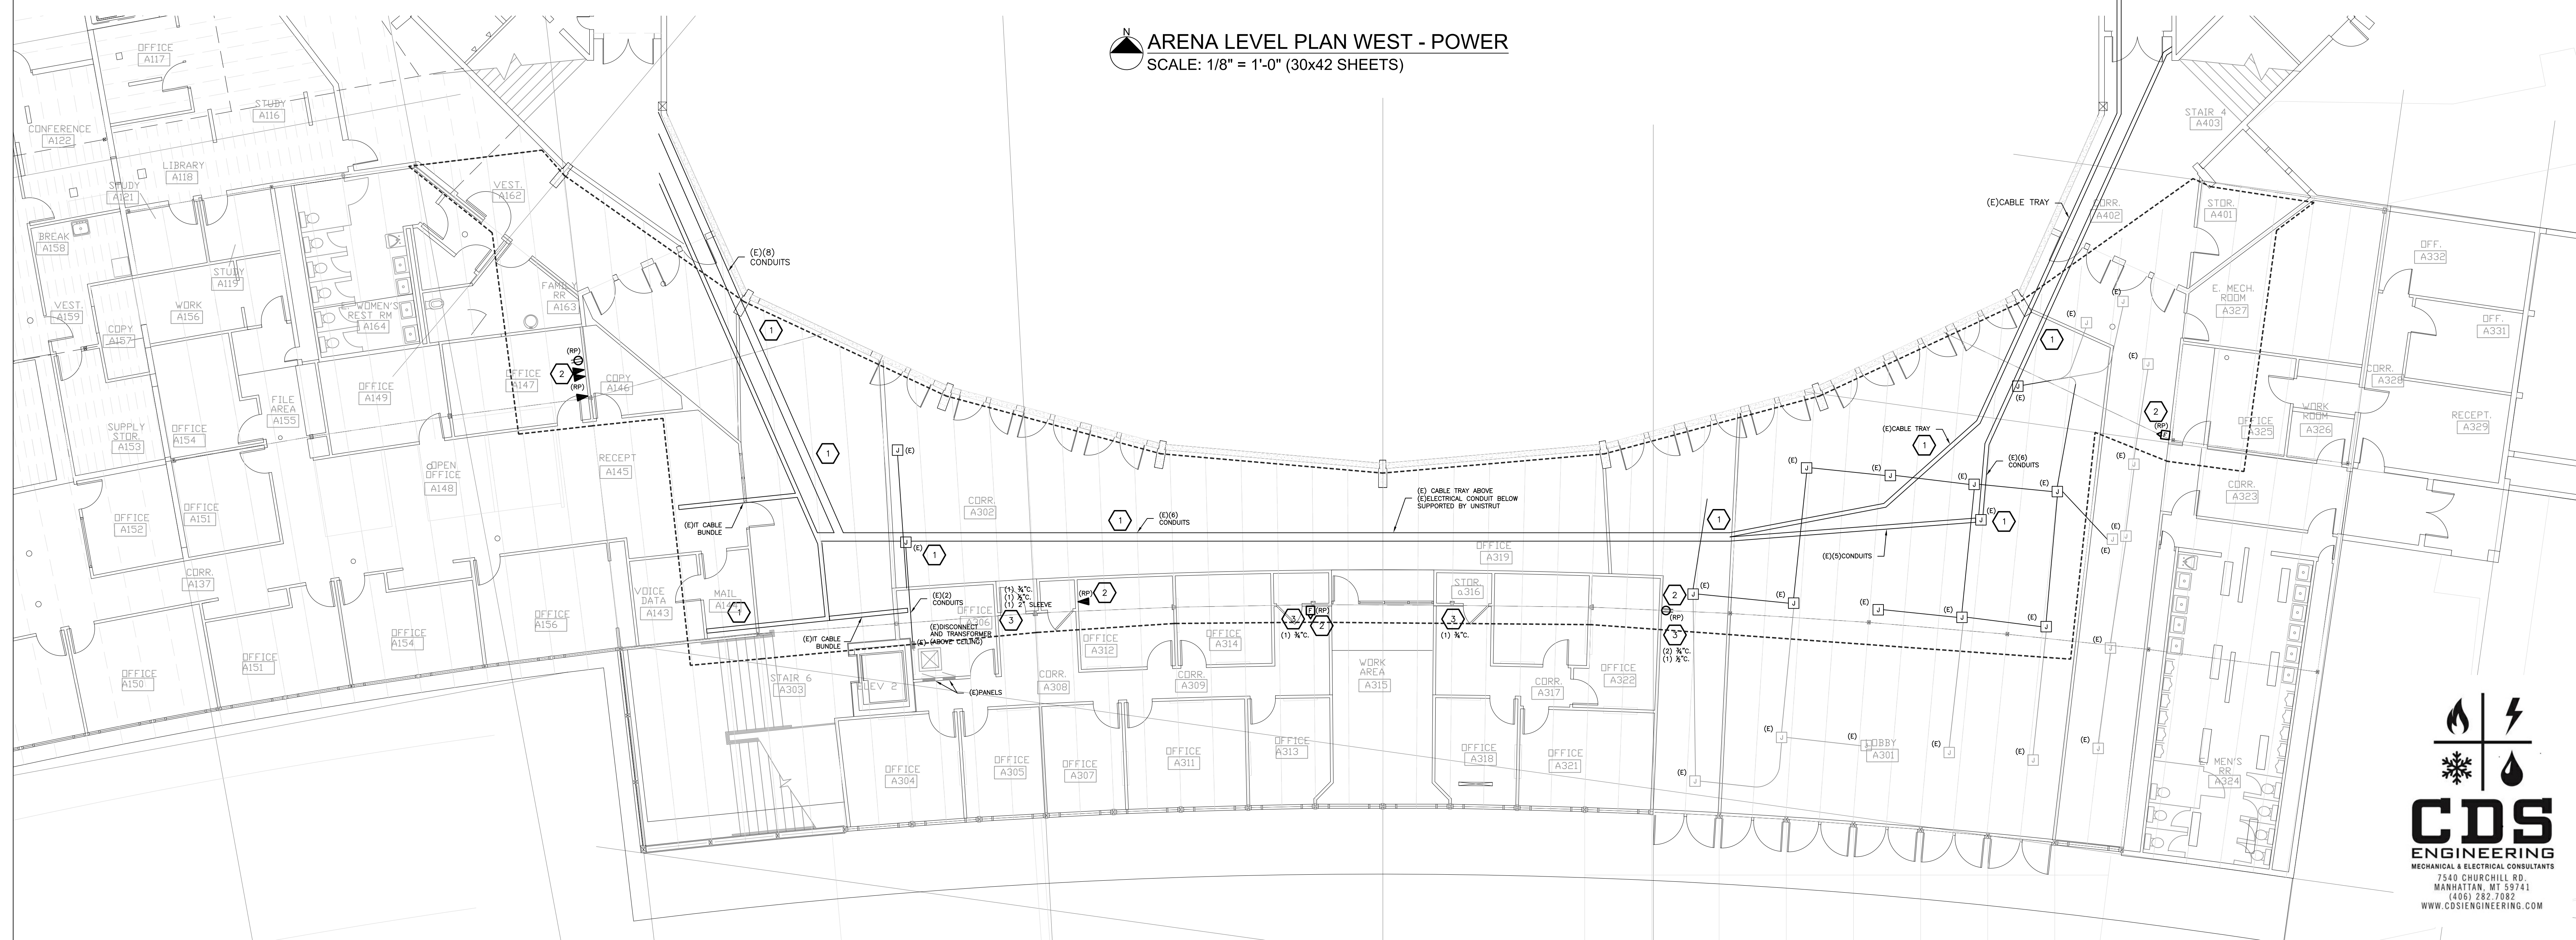

7540 CHURCHILL RD.
MANHATTAN, MT 59741
(406) 287.7382
WWW.CDSENGINEERING.COM

COORDINATION NOTE:
 IT IS ABSOLUTELY NECESSARY FOR ALL TRADES INCLUDING EQUIPMENT SUPPLIERS TO COORDINATE WITH EACH OTHER AND TO VERIFY THAT THERE ARE NO CONFLICTS IN LOCATIONS OF DUCTS, CONDUITS, SPRINKLER HEADS, SPRINKLER PIPING, DIFFUSERS, ELECTRICAL BOXES AND OTHER ITEMS THROUGHOUT THIS PROJECT BEFORE FINAL PLACEMENT OF MATERIALS.

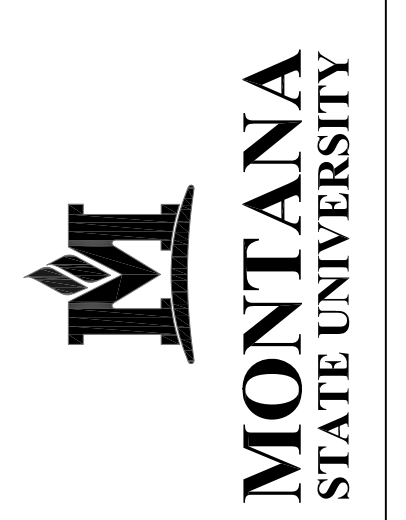

MSU-CPDC
 MONTANA STATE UNIVERSITY
 BOZEMAN, MONTANA
 PHONE: 406.994.5413
 FAX: 406.994.5665



**BRICK BREEDEN
 FIELDHOUSE
 WEST ENTRY ROOF RETROFIT**

GENERAL NOTES

1. ALL WORK SHALL BE PERFORMED IN STRICT ACCORDANCE WITH NEC, STATE AND LOCAL BUILDING CODE(S).
2. UPON THE REMOVAL OF THE ROOF, THE CAVITY CREATED BY THE STEEL TRUSSES WILL BE EXPOSED. LOCATION OF ELECTRICAL SYSTEM COMPONENTS SHALL BE CHECKED FOR CONFLICTS WITH NEW STRUCTURAL MEMBERS AND COMPONENTS OF OTHER SYSTEMS HAVING FIXED LOCATIONS. IN THE EVENT OF ANY CONFLICTS, THE ARCHITECT/ENGINEER SHALL BE CONSULTED AND HIS/HER DECISION GOVERN. ENGINEER SHALL BE NOTIFIED TO REVIEW THE CONCEALED CAVITY AFTER THE EACH SECTION HAS BEEN OPENED UP.
3. AT ALL TIMES DURING THE PERFORMANCE OF THIS CONTRACT, PROPERLY PROTECT WORK FROM DAMAGE AND PROTECT THE OWNER'S PROPERTY FROM INJURY OR LOSS. MAKE GOOD ANY DAMAGE, INJURY OR LOSS, EXCEPT THOSE CAUSED BY AGENTS OR EMPLOYEES OF THE OWNER.
4. ALL ACTIVE SERVICES WHICH ARE ENCOUNTERED SHALL BE PROTECTED, BRACED AND SUPPORTED WHERE REQUIRED FOR PROPER EXECUTION OF THE WORK AND WITHOUT INTERRUPTION OF SERVICE IF POSSIBLE.
5. ANY WORK THAT REQUIRES POWER DISRUPTIONS SHALL BE SCHEDULED, MINIMUM OF 7 WORKING DAYS AHEAD OF TIME, AND APPROVED BY THE OWNER.
6. RELOCATE AND PROTECT ALL LOW VOLTAGE CABLES INSTALLED NEAR THE NEW AND RETROFITTED COLUMN LOCATIONS TO KEEP THEM FREE FROM DAMAGE.

CONSTRUCTION NOTES


1. EXISTING LIGHTING AND ASSOCIATED CONDUIT AND CONDUCTORS TO REMAIN. LIGHTING AND ASSOCIATED CONDUIT ARE SUPPORTED FROM THE DROPPED CEILING(S) AND STRUCTURE ABOVE. PROTECT AND SUPPORT AS NEEDED TO KEEP EXISTING INFRASTRUCTURE CLEAR FROM DAMAGE DURING THE CONSTRUCTION PROJECT.
2. REMOVE THE ELECTRICAL DEVICES SHOWN AND THE ASSOCIATED CONDUIT TO ALLOW THE STEEL COLUMN TO BE RETROFITTED. RE-INSTALL CONDUIT, CONDUCTORS AND ELECTRICAL DEVICES TO FUNCTION AS INITIALLY FOUND.

ARENA LEVEL PLAN WEST - LIGHTING
 SCALE: 1/8" = 1'-0" (30x42 SHEETS)



CONSTRUCTION DOCUMENTS

DRAWN BY:	STE	DATE:	
REVIEWED BY:	STE	DATE:	4/10/20
REV. 1:	SCHEMATIC DESIGN	DATE:	
CD	95% REVIEW	DATE:	7/28/20
CD	100% CD	DATE:	11/1/20

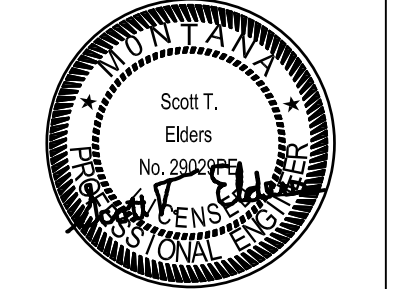

PPA# 19-0172

CDSI #2014
SHEET TITLE
 ARENA LEVEL
 PLAN WEST-
 LIGHTING
 SHEET

E2.1

DATE
11/01/2020

